NEW YORK STATE INSURANCE FUND

AV Upgrades

199 Church Street, New York, 10007

PROJECT #21-048-1165.02

OGS SUBMISSION
OGS PROJECT NUMBER: SF760



NEW YORK STATE INSURANCE

199 Church Street, New York, 10007

NYSIF-AV 15th Floor Upgrades






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ONSULTANT:



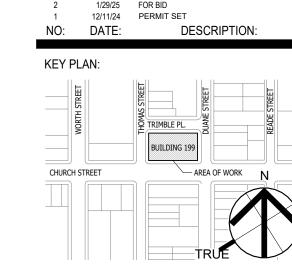

SEAL AND SIGNATURE



OGS PROJECT NO: SF760

DRAWING TITLE: COVER SHEET

ISSUE DATE:	
12/11/24	
PROJECT NO.:	SCALE:
21-048-1165.02	
DRAWING NO.:	

T.000

PROJECT LOCATION:

GENERAL NOTES

- THE CONTRACTOR SHALL NOTIFY LIRO ARCHITECTS OF ANY ERRORS. OMISSIONS CONFLICTS OR AMBIGUITIES BETWEEN THE PLANS, DRAWINGS & SPECIFICATIONS PRIOR TO PROCEEDING WITH THAT PORTION OF THE WORK. IF SUCH NOTICE IS NOT FURNISHED LIRO ARCHITECTS, THE CONTRACTOR SHALL BE DEEMED TO HAVE INSPECTED THE PLANS, DRAWINGS, & SPECIFICATIONS & TO HAVE FOUND THEM IN PROPER FORM FOR EXECUTION.
- CONTRACTOR IS REQUIRED, PRIOR TO BID, TO FIELD CHECK CONDITIONS OF EXISTING STRUCTURE (I.E. ARCH, BEAMS, SLABS, ETC.) INCLUDING INTEGRITY OF EXISTING FIREPROOFING & TO INCLUDE ALL COSTS NECESSARY FOR SUPPORTS & BRACING FOR ALL WORK. ALL SUPPORT METHODS SHALL MEET ALL APPLICABLE CODES & AGENCY REQUIREMENTS & BUILDING STANDARDS. NO ADDITIONAL COSTS FOR SUPPORTS WILL BE ACCEPTED AFTER THE BID. IN ADDITION, SAID INSPECTION & REQUIRED WORK FOR FIREPROOFING & FIRE STOPPING OF EXISTING CONDITIONS SHALL BE INCLUDED IN THE BID.
- THE ARCHITECT DOES NOT CERTIFY DIMS OR CONDITIONS OF EXISTING CONSTRUCTION. CONTRACTOR SHALL NOTIFY ARCHITECT IMMEDIATELY OF ANY DISCREPANCY BETWEEN DRAWINGS & EXISTING CONDITIONS. IN ADDITION, THE CONTRACTOR SHALL NOTIFY THE ARCHITECT OF ANY DEFECTIVE CONSTRUCTION UNCOVERED DURING CONSTRUCTION.
- ALL INSURANCE & PERMITS REQUIRED BY LAW FOR CONSTRUCTION SHALL BE THE RESPONSIBILITY OF THE GENERAL CONTRACTOR.
- THE CONTRACTOR SHALL BE LIABLE FOR & REPAIR ANY DAMAGES TO THE OWNER'S PROPERTY RESULTING FROM HIS WORK.
- ALL CONSTRUCTION SCRAPS, DIRT, & DEBRIS SHALL BE REMOVED FROM THE PREMISES DAILY AT THE COMPLETION OF THE WORK, THE PREMISES SHALL BE LEFT IN A PROFESSIONAL CLEAN
- CONTRACTOR SHALL DEVISE & PROVIDE PROTECTIVE MEASURES TO INSURE THE SAFETY OF THE OWNER, THE TENANTS, AND THE GENERAL PUBLIC.
- ALL WORK TO BE PREFORMED IN A WORKMANLIKE FASHION. MATERIALS UTILIZED SHALL BE AS SPECIFIED ON THE DRAWINGS OR IN THE JOB SPECIFICATIONS, OF, IF GENERIC, IN
- COMPLIANCE WITH ASTM, NEW YORK CODE, OR OTHER GENERALLY ACCEPTED STANDARDS. ALL PLUMBING, ELECTRICAL, & MECHANICAL EQUIPMENT INSTALLATIONS TO COMPLY WITH APPLICABLE BUILDING CODES & SHALL BE PERFORMED BY LICENSED CONTRACTORS.
- . CONTRACTOR SHALL DO ALL THE NECESSARY CUTTING & PATCHING FOR THE COMPLETION OF THE NEW WORK. HOWEVER, EXISTING BEAMS OR STRUCTURAL MEMBERS SHALL NOT BE CUT OR NOTCHED WITHOUT CONSULTATION WITH THE ARCHITECT.
- . WHERE EXISTING EQUIPMENT OR CONSTRUCTION IS REMOVED OR ALTERED, ALL REMAINING SURFACES & FINISHES AFFECTED SHALL BE PATCHED & FINISHED TO MATCH ADJACENT CONSTRUCTION/PRE-EXISTING CONDITION.
- . WHERE NEW ELECTRICAL LINES ARE CONCEALED IN WALLS OR CEILINGS, THE FINISH SURFACE SHALL NOT BE INSTALLED UNTIL THE NEW ELECTRICAL LINES HAVE BEEN TESTED &
- INSPECTED BY ENGINEER & MUNICIPAL AUTHORITIES. B. INSPECTION REQUIREMENTS SHALL BE AS PER THIS SET OF DRAWINGS &/OR ATHORITY
- HAVING JURSIDICTION REGULATIONS. I. ALL MATERIALS, ASSEMBLIES & METHODS OF CONSTRUCTION REGULATED BY THE CODE & NOT LISTED AS SUBJECT TO CONTROLLED INSPECTION, SHALL BE SUBJECT TO SEMI-CONTROLLED INSPECTION BY THE PERSON SUPERINTENDING CONSTRUCTION. SIGNED COPIES OF ALL TEST & INSPECTION REPORTS SHALL BE FILED THROUGH THE ARCHITECT WITH THE AUTHORITY HAVING JURISDICTION.
- DUCTS, PIPES & CONDUITS PASSING THROUGH RATED CONSTRUCTION SHALL HAVE SPACES NOT EXCEEDING 1/2" FIRE STOPPED WITH NON-SHRINKING GROUT & CLOSED OFF WITH CLOSE FITTING METAL ESCUTCHEONS.
- 6. ALL EXITS SHALL BE KEPT READILY ACCESSIBLE & UNOBSTRUCTED AT ALL TIMES. 7. ILLUMINATION OF AT LEAST 5 FOOT CANDLES MEASURED AT THE FLOOR LEVEL SHALL BE
- MAINTAINED CONTINUOUSLY DURING OCCUPANCY, IN EXITS & THEIR ACCESS FACILITIES. 8. DIMENSIONS BEARING THIS SIGN "+/-" OR "APPROX." ARE FOR GUIDANCE ONLY SHALL NOT BE USED FOR LAYOUT OF WORK.
-). GENERAL CONTRACTOR SHALL SECURE ALL REQUIRED PERMITS & APPROVALS FROM ALL DEPARTMENTS HAVING JURISDICTION & SHALL OBTAIN BUILDING DEPARTMENT CERTIFICATE OF OCCUPANCY UPON COMPLETION OF WORK.
- . MINOR DETAILS NOT USUALLY SHOWN OR SPECIFIED, BUT NECESSARY FOR PROPER CONSTRUCTION OF ANY PART OF THE WORK SHALL BE INCLUDED AS IF THEY WERE INDICATED
- I. THE CONTRACTOR SHALL COORDINATE ALL WORK PROCEDURES WITH REQUIREMENTS OF LOCAL AUTHORITIES & BUILDING MANAGEMENT.
- . THE CONTRACTOR SHALL BE RESPONSIBLE FOR THE PROTECTION OF ALL CONDITIONS & MATERIALS WITHIN THE PROPOSED CONSTRUCTION AREA. THE CONTRACTOR SHALL HAVE SOLE RESPONSIBILITY FOR ANY DAMAGE OR INJURIES CAUSED BY OR DURING THE EXECUTION OF THE WORK
- . THE CONTRACTOR SHALL LAY OUT HIS OWN WORK & SHALL PROVIDE ALL DIMENSIONS REQUIRE D FOR OTHER TRADES (PLUMBING, ELECTRICAL, ETC.)
- . ALL PIPING & WIRING INDICATED FOR REMOVAL SHALL BE REMOVED TO A POINT OF CONCEALMENT & SHALL BE PROPERLY CAPPED OR PLUGGED. ELEC. SERVICES TO BE ABANDONED ARE TO BE TRACED BACK TO PANEL & DISCONNECTED.
- THE CONTRACTOR IS RESPONSIBLE FOR ASCERTAINING CONSTRUCTION RULES & REGULATIONS OF THE BUILDINGS MANAGEMENT & FOR ACCOMMODATING THESE REQUIREMENTS IN THEIR PRICE.
- 6. ALL WORK IS TO CONFORM WITH DRAWINGS & SPECIFICATIONS WHETHER BY LIRO ARCHITECTS, ENGINEERS, TELECOMMUNICATIONS CONSULTANTS, &/OR ANY & ALL OTHER CONSULTANTS
- THE CONTRACTOR IS TO MAINTAIN A COMPLETE & UP TO DATE SET OF DRAWINGS ON THE JOB AT ALL TIMES, INCLUDING THE CONTRACT DOCUMENTS & SHOP DRAWINGS.
- 8. DRAWINGS ARE NOT TO BE SCALED. 29. ALL DIMENSIONS GIVEN FOR PARTITIONS ARE FINISH SURFACE TO FINISH SURFACE UNLESS OTHERWISE NOTED, REFER TO CONSTRUCTION PLAN.
- . THE CONTRACTOR IS TO PREPARE THE JOB SITE PARTITION LAYOUT FOR APPROVAL BY LIRO ARCHITECTS, PRIOR TO ERECTING PARTITIONS. PROVIDE THREE (3) DAYS PRIOR NOTICE TO LIRO ARCHITECTS.
- I. THE CONTRACTOR SHALL TAPE MARK-ON FLOOR SLAB &/OR RAISED FLOOR, ALL FURNITURE SYSTEM PARTITIONS & ELECTRICAL, TELEPHONE & COMMUNICATION CABLE FEED FLOOR OUTLETS, FOR LIRO ARCHITECTS APPROVAL PRIOR TO CORE DRILLING & PLACEMENT OF OUTLETS.PROVIDE THREE (3) DAYS PRIOR NOTICE TO LIRO ARCHITECTS.
- 2. ALL GYPSUM BOARD USED IN PARTITION TYPES TO BE TYPE (X). 3. UNLESS OTHERWISE NOTED, THE CONTRACTOR SHALL DOUBLE UP METAL STUDS AT ALL DOORS, OPENINGS, & FRAMES.
- 4. WHERE STEEL STUDS ADJOIN METAL DUCT OR WHERE TWO METALS ARE AFFIXED TO EACH OTHER, THE CONTRACTOR WILL PROVIDE THE NECESSARY INSULATING MATERIAL SO THAT NO VIBRATION OR NOISE IS TRANSMITTED BETWEEN THE METALS.
- 5. ALL PARTITIONS SHOWN "ALIGNED" ARE TO BE SMOOTH & FLUSH WITH EXISTING PARTITION. WHERE REQUIRED & WHERE PARTITIONS ALIGN WITH COLUMNS, CARRY SINGLE FACE OF SHEET ROCK TIGHT TO & PAST COLUMN FACE.
- . PERIPHERAL WALL SURFACE OR EXISTING COLUMN FACES EXHIBITING CRAVING, WATER DAMAGE, OR IRREGULARITY, ANY OF WHICH IS LIKELY TO CAUSE UNEVEN APPEARANCE IN THE FINAL FINISH, ARE TO BE SHEATHED OVER OR FURRED OUT AS NECESSARY WITH GYPSUM
- BOARD, TAPED & SPACKLED AS REQUIRED. 7. THE CONTRACTOR IS TO PROVIDE ALL PIPE MOISTURE WRAPPING MATERIAL AS APPROVED FOR BUILDING STANDARD INSTALLATION.
- 8. THE CONTRACTOR IS TO REPLACE THE INTEGRITY OF RATED PARTITIONS, COLUMNS & BEAM FIREPROOFING IF DAMAGED. REPLACEMENT TO COMPLY WITH LOCAL CODES. . THE CONTRACTOR SHALL CONTINUOUSLY MAINTAIN ADEQUATE PROTECTION OF ALL
- REMAINING EXISTING CONDITIONS & NEW WORK FROM DAMAGE. HE SHALL PROTECT THE TENANT & THE BUILDING'S PROPERTY FROM INJURY OR LOSS ARISING IN CONNECTION WITH THE WORK. ALL FINISHED SURFACES SHALL BE PROTECTED BY THE CONTRACTOR GENERALLY, BUT NOT LIMITED TO: DOORS, JAMBS, & PASSAGEWAYS. THE CONTRACTOR SHALL, WITHOUT EXTRA COMPENSATION, REFINISH ALL SURFACES IN SUCH SPACES WHERE THESE SURFACES PROVE TO HAVE BEEN INADEQUATELY PROTECTED & ARE DAMAGED BY THE CONTRACTOR'S SUBCONTRACTORS.
- . ALL WOODWORK ATTACHED TO PREMISES SHALL BE FIRE RETARDANT TO COMPLY WITH LOCAL CODES & REQUIREMENTS OF AGENCIES HAVING JURISDICTION.
- I. ANY EXISTING WORKING JUNCTION BOXES, OUTLETS, THERMOSTATS TO REMAIN ON WALLS RECEIVING A NEW GYPSUM BOARD LAMINATION, FURRING OR BUILD OUT, SHALL BE EXTENDED FLUSH TO THE NEW SURFACE.
- THERE SHALL BE NO SUBSTITUTIONS OF ANY MATERIAL WHERE SPECIFIC MANUFACTURER'S ARE SPECIFIED. WHERE APPROVED EQUAL IS USED IT SHALL BE UNDERSTOOD THAT THE SUBSTITUTE SHALL BE BY JUDGMENT & APPROVAL OF LIRO ARCHITECTS & NOTIFICATION TO LIRO ARCHITECTS TO BE MADE PRIOR TO INSTALLATION.

GENERAL BUILDING CODE NOTES:

- WORK SHALL BE EXECUTED IN FULL COMPLIANCE WITH THE APPLICABLE PROVISIONS OF ALL LAWS, BY-LAWS, STATUTES, ORDINANCES, CODES, RULES, REGULATIONS AND LAWFUL ORDERS OF PUBLIC AUTHORITIES BEARING ON THE PERFORMANCE AND EXECUTION OF THE WORK. WORK SHALL BE IN CONFORMANCE WITH THE NYS 2020 BUILDING CODES.
- THE CONTRACTOR SHALL PROMPTLY NOTIFY THE OWNER AND ARCHITECT OF ANY PORTIONS OF THE WORK, IN THE CONTRACT DOCUMENTS THAT ARE IN VARIANCE OF THE ABOVE LIST. ALL MATERIALS, ASSEMBLIES, FORMS OF CONSTRUCTION AND SERVICE EQUIPMENT
- REGULATED BY CODE SHALL MEET THE FOLLOWING REQUIREMENTS: A. THEY SHALL HAVE BEEN ACCEPTABLE PRIOR TO THE EFFECTIVE DATE OF THE CODE BY
- THE BOARD OF STANDARDS AND APPEALS OR MEA, B. THEY SHALL HAVE BEEN ACCEPTED FOR THE USE UNDER THE PRESCRIBED TEST METHODS BY THE COMMISSIONER
- C. APPROVED BY THE OFFICE OF TECHNICAL CERTIFICATION AND RESEARCH (OTCR) D. SHALL BE LISTED AND LABELED BY A NYS RECOGNIZED AGENCY TO MEET REQUIRED
- MATERIALS OR ASSEMBLIES REQUIRED TO HAVE A FIRE RESISTANCE RATING SHALL COMPLY WITH ONE OF THE FOLLOWING:
- A. THEY SHALL CONFORM WITH CHAPTER 7 OF THE NYS 2020 BUILDING CODE. B. THEY SHALL HAVE BEEN TESTED IN ACCORDANCE WITH ASTM E119 OR UL 263, STANDARD METHODS OF FIRE TESTS OF BUILDING CONSTRUCTION AND MATERIALS BY A NATIONALLY RECOGNIZED AGENCY.
- C. THEY SHALL HAVE BEEN ACCEPTABLE PRIOR TO THE EFFECTIVE DATE OF THE CODE. D. APPROVED BY OTCR.
- INTERIOR FINISH: MATERIALS SHALL BE CLASSIFIED IN ACCORDANCE WITH THE SURFACE FLAME SPREAD RATING OBTAINED ACCORDANCE AS PRESCRIBED IN ASTM E-84-1961 "STANDARD METHOD OF TEST FOR SURFACES BURNING CHARACTERISTICS OF BUILDING MATERIALS', CONTRACTOR TO SUBMIT LIST OF FINISH MATERIAL TO THE BUILDING DEPARTMENT FOR APPROVAL & ACCEPTANCE PRIOR TO USE OF FINISH MATERIALS, & SHALL
- COMPLY LOCAL REGULATIONS. IF APPLICABLE BY THE NYS OGS, THE CONTRACTOR'S LICENSED PROFESSIONAL IS RESPONSIBLE FOR FILING APPLICATION AND OBTAINING PERMITS FOR CONSTRUCTION EQUIPMENT OR PUBLIC PROTECTIVE REQUIRED TO ENSURE SAFETY OF OPERATION AND THE
- PUBLIC AS PER NYS 2020 CONSTRUCTION CODE. ALL WORK SHALL COMPLY WITH CHAPTER 11 "ACCESSIBILITY" OF THE 2020 NYS BUILDING CODE AND ICC A117.1-2009.
- ALL NEW WORK SHALL COMPLY WITH THE 2020 NEW YORK CITY ENERGY CONSERVATION
- ALL NEW INTERIOR FINISHES SHALL BE CONSTRUCTED OF MATERIALS MEETING CHAPTER 8 FOR FLAME SPREAD AND SMOKE DEVELOPMENT RATINGS OF THE 2020 NYS BUILDING CODE 10. FIRE-RESISTANT RATED PARTITIONS SHALL EXTEND UP TO, AND BE SECURED TO, THE UNDERSIDE OF THE FLOOR STRUCTURE ABOVE. PENETRATIONS THROUGH FIRE-RESISTANT
- RATED PARTITIONS AND FLOORS SHALL BE APPROPRIATELY PROTECTED 1. ALL INTERIOR FINISHES SHALL COMPLY WITH SECTION BC 803 AND TABLE 803.11 FOR FLAME SPREAD AND SMOKE DEVELOPMENT 12. CONSTRUCTION OF HUNG CEILINGS SHALL COMPLY WITH SECTION BC 808 AND CHAPTER 7.

BUILDING INFORMATION BUILDING ADDRESS: 199 CHRUCH STREET REFER TO A.101 FOR NEW YORK, NY 10007 BUILDING CODE ANALYSIS. **BOROUGH: MANHATTAN** BLOCK: 151 LOT: 10 BIN: 10011652

COMMUNITY BOARD: 11 LANDMARK: NO ZONING MAP: 12a ZONING DISTRICT: C6-4 BUILDING CLASSIFICAION: O6 - OFFICE BUILDING

2020 NEW YORK STATE BUILDING CODE 2020 UNIFORM CODE SUPPLEMENT OF NEW YORK STATE BUILDING CODE 2020 NEW YORK STATE ELECTRICAL CODE

NO CHANGE TO THE USE, EGRESS, OR OCCUPANCY.

GNERAL NOTES, CONTINUED

- 43. THE CONTRACTOR SHALL CONSULT WITH & ADHERE TO REGULATIONS OF THE BUILDING AS TO TIME & METHOD OF DELIVERY, DEBRIS REMOVAL, HOURS OF DEMOLITION & NOISY CONSTRUCTION, & MAKING ARRANGEMENTS FOR CONSTRUCTION PERSONNEL TO ENTER
- 44. ALL METAL STUDS TO BE MINIMUM GAUGE OF "U.S. GYPSUM" #ST22 STUDS OR EQUAL, UNLESS OTHERWISE NOTED OR REQUIRED.
- 45. ALL WORK SHALL BE GUARANTEED FOR THE PERIOD OF ONE YEAR FROM THE DATE OF SUBSTANTIAL COMPLETION OR TENANT/OWNER MOVE IN WHICHEVER IS LATER.
- 46. IT SHALL BE THE RESPONSIBILITY OF THE CONTRACTOR TO DISTRIBUTE ADEQUATE COPIES OF THESE DRAWINGS TO ALL APPLICABLE TRADES AT ALL TIMES DURING THE PROGRESS OF THE
- 7. THE CONSTRUCTOR SHALL SUBMIT A DIGITAL SET OF SHOP DRAWINGS & THREE (3) PRODUCT SAMPLES TO LIRO ARCHITECTS & OTHER PROJECT CONSULTANTS FOR LIRO ARCHITECTS REVIEW PRIOR TO COMMENCEMENT OF WORK. 48. REFER TO ALL OTHER PLANS INCLUDING ENGINEERING & AUDIOVISUAL PLANS FOR RELATED
- 49. ALL CONSTRUCTION DOCUMENTS ARE COMPLEMENTARY (ARCH., ENG., ETC.) & WHAT IS CALLED FOR BY ANY WILL BE BINDING AS IF CALLED FOR BY ALL. ANY WORK SHOWN OR
- REFERRED TO ON ANY CONSTRUCTION DOCUMENTS SHALL BE PROVIDED AS THOUGH ON ALL RELATED DOCUMENTS. 50. ALL EXISTING CORE WALLS, PERIMETER WALLS, COLUMNS, & ANY & ALL EXISTING WALLS TO
- REMAIN ARE TO BE FIELD INSPECTED BY CONTRACTOR AT TIME OF BID & ALL COSTS TO PATCH & REPAIR ALL MENTIONED ITEMS TO A SMOOTH SURFACE FOR FINISHING ARE TO BE INCLUDED AT TIME OF BID. UNFINISHED OR BADLY DAMAGED CORE WALLS, COLUMNS & MASONRY WALL SURFACES TO BE LAMINATED OR FURRED TIGHT WITH 5/8" GYPSUM BOARD TO 3" ABOVE HUNG CEILING & TAPED & SPACKLED READY FOR FINISHES, UNLESS OTHERWISE NOTED. ALL EXISTING WALLS TO REMAIN, WHERE AFFECTED BY DEMOLITION &/OR NEW
- CONSTRUCTION, TO BE PATCHED, PROVIDE CORNER BEADS IF REQUIRED, TAPE & SPACKLE. PREPARE TO ACCEPT NEW FINISHES. 52. ALL WORK SHALL COMPLY WITH APPLICABLE LOCAL & MUNICIPAL BUILDING CODES AS WELL AS
- ANY & ALL REGULATORY AGENCIES INCLUDING, BUT NOT LIMITED TO OSHA, AMERICAN DISABILITIES ACT (ADA), ETC. GENERAL NOTES SHALL APPLY TO ALL DRAWINGS.
- 53. THE CONTRACTOR SHALL INCLUDE IN THEIR BID ALL COSTS FOR DISCONNECTION, TRANSPORTATION, & REINSTALLATION OF ALL ITEMS AT THE OWNER'S EXISTING PREMISES WHICH ARE DESIGNATE TO BE RELOCATED.
- 54. THE CONTRACTOR SHALL SUBMIT FOR APPROVAL COORDINATED SHOP DRAWINGS OF ALL TRADES HAVING AN IMPACT ON EACH OTHER, INCLUDING BUT NOT LIMITED TO HVAC, SPRINKLER, PLUMBING, CEILING, LIGHTING, ETC, IF CONFLICTS OCCUR AFTER INSTALLATION OF ANY TRADE'S WORK, IT SHALL BE THE RESPONSIBILITY OF THE CONTRACTOR TO RECTIFY SAME AT NO COST TO THE OWNER.
- 5. CONTRACTOR TO PROVIDE A SYSTEM OF TEMPORARY LIGHTS THROUGHOUT THE SPACE DURING DEMOLITION & CONSTRUCTION.
- 56. SECURITY & BUILDING ACCESS: CONTRACTOR TO ENSURE THAT ALL PERSONNEL SIGN IN DAILY AT THE RECEPTION DESK. 57. CONSTRUCTION HOURS: U.O.N BY THE CLIENT, ALL CONSTRUCTION TO OCCUR DURING
- NORMAL WORKING HOURS FROM 8A.M TO 6P.M MONDAY THROUGH FRIDAY. ADVANCED NOTICE MUST BE PROVIDED AND APPROVED BY THE CLIENT FOR NOISY OPERATIONS SUCH AS BUT NOT LIMITED TO DEMOLITION OR DRILLING. HOURS FOR DELIVERIES: U.O.N BY THE CLIENT, ALL DELIVERIES AND REMOVALS SHALL OCCUR PRIOR TO 8.A.M MONDAY THROUGH FRIDAY, WITH LIMITED DELIVERIES AFTER 8.A.M UPON
- FILLED REGION PATTERNS ACOUSTIC CONCRETE TILE GYP BD SAFING

PLYWOOD

STEEL

ABBREVIATIONS

AFF

ALUM

APPROX

ARCH

ASB

AVG

AWP

AWC

BD

BLDG

BLK

BLKG

BTWN

CCTV

CLG

CLR

COL

CONC

CONT

CPT

DBL

DEMO

DEPT

DIAG

DIM

DWG

EMER

EQ

EST

EXT

FRT

FURN

GEN

GYP

EQUIP

DIV

CONST

CONTR

CU YD

ACOUSTICAL CEILING PANEL

HDWR

HGT

HORIZ

HVAC

INST

INT

LBS

LVR

MATL

MECH

MFR

MISC

MTL

OH

OTCR

PLUMB

PLYWD

PNL

PREP

PSF

QTY

FIRE EXTINGUISHER CABINET PREFAB PREFABRICATE(D'

INSUL

HARDWARE

HOLLOW META

HEATING, VENTILATING

AIR CONDITIONING

INSIDE DIAMETER

INFORMATION

INSTALL(ATION)

INSULATE(ION)

HORIZONTAL

HEIGHT

HOUR

HEIGHT

INCLUDE

INTERIOR

INVERT

JANITOR

LAMINATE

POUNDS

LOUVER

METER(S)

MATERIAI

MAXIMUM

MINIMUM

METAL

NUMBER

NOMINAL

MECHANICAL

MANUFACTURER

MISCELLANEOUS

NOT IN CONTRACT

NOISE REDUCTION

COEFFICIENT

NOT TO SCALE

NEW YORK STATE

OFFICE OF GENERAL SERVICES

CERTIFICATION AND RESEARCH

POUNDS PER SQUARE FOOT

POUNDS PER SQUARE INCH

OFFICE OF TECHNICAL

NEW YORK CITY

PROPERTY LINE

PLUMBING

PLYWOOD

PREFINISHED

PROJEC^{*}

QUANTIT'

RADIUS

REQUIREI

ROOM

REFERENCE

REINFORCE(D)(ING)

ROUGH OPENING

PANEL

PAINT

ON CENTER

OVERHEAD

OPENING

LAVATORY

LINEAR FEET (FOOT)

JOINT

ACOUSTICAL CEILING TILE

ABOVE FINISHED FLOOR

ALTERNATE

ALUMINUM

AVERAGE

BOARD

BLOCK

BUILDING

BLOCKING

BETWEEN

ACCESS PANEL

APPROXIMATE (LY)

ARCHITECT(URAL)

ARCHITECT(URAL)

BUILDING CODE

CONTROL JOINT

CENTERLINE

CENTIMETER

CEILING

COLUMN

CONCRETE

CONSTRUCT(ION

CONTINUOUS

CONTRACT(OR

CARPET TILES

DEMOLISH, DEMOLITION

CUBIC YARD

DIAMETER

DEPARTMENT

DIAGONAL

DIMENSION

DIVISION

DETAIL

DRYWALL

DRAWING

FLEVATION

ELECTRICAL

EQUIPMENT

ESTIMATE

EXTERIOR

FACE BRICK

FLOOR DRAIN

FIRE RATED

FOOT, FEET

FURNITURE

GAL VANIZED

GENERAL

GLASS

GYPSUM

FURRING

FIRE EXTINGUISHER

FINISHED FLOOR ELEVATION

FIBER RETARDANT TREATED PSI

FINISHED FLOOR

EQUAL

EMERGENCY

EXPANSION JOINT


DOUBLE

CLEAR

ACOUSTICAL WALL PANEL

CLOSED CIRCUIT TELEVISION


ACOUSTICAL WALL COVERING INCL

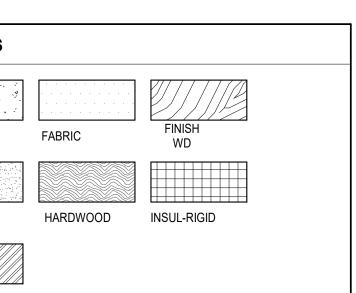

SYMBOLS LEGEND COLUMN LINE GRID DESIGNATIONS 1ST FLOOR LEVEL LINE/MARK LEVEL NAME LEVEL ELEVATION INT ELEVATIONS **ELEVATION NUMBER** DRAWING SHEET NUMBER **DETAIL CALLOUT** A101 **DETAIL NUMBER** SHEET NUMBER **DETAIL SECTION DETAIL NUMBER** A101 SHEET NUMBER **BUILDING / WALL SECTIONS** DETAIL NUMBER SHEET NUMBER View Name DETAIL TITLE DETAIL NAME 1/8" = 1'-0" **DETAIL NUMBER** SCALE 1 / A101 REFERENCE DETAIL / SHEET SPOT ELEVATION MARKER **NORTH ARROW CENTER LINE MARK** Room name **ROOM TAG** 101 150 SF **REVISION TAG** FINISH **CEILING TAG CEILING FINISH** 1'-0" **CEILING HEIGHT** DOOR TAG (101) DOOR NUMBER 00-00000 FINISH TAG **KEYNOTE TAG**

MATERIAL TAG / MARK

WALL/PARTITION TAG

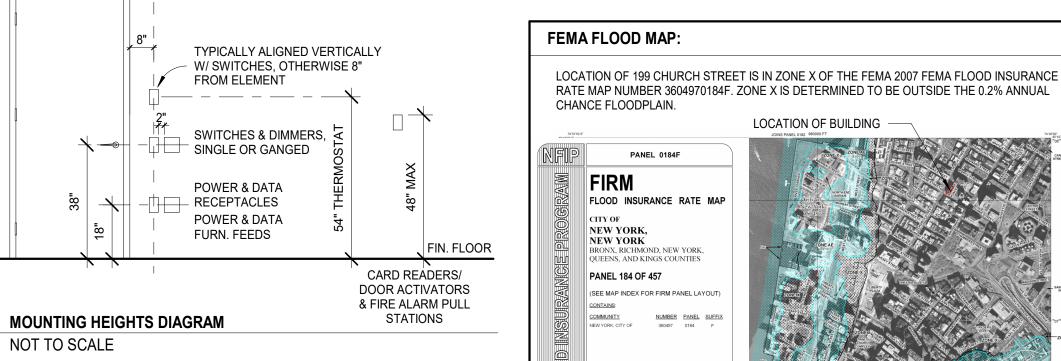

e to User: The Map Number shown below should when placing map orders; the Community Numb

MAP NUMBER

3604970184F

MAP REVISED

SEPTEMBER 5, 2007

FIN. CLG

SCHEDULE

SPECIFICATION

STAINLESS STEEL

COEFICENT

STANDARD

STEEL

STORAGE

STRUCTURAL

SYMMETRY(RICAL)

TO BE DETERMINED

TOP OF FINISH FLOOR

VINYL COMPOSITION TILE

TOP & BOTTOM

THICK(NESS)

TOP OF FINISH

TOP OF SLAB

TOP OF STEEL

TOP OF WALL

TYPICAL

UNFINISHED

UNLESS NOTED

VERIFY IN FIELD

OTHERWISE

VINYL BASE

VERTICAL

WITHOUT

WOOD

WEIGHT

WOOD BASE

WATER CLOSET

WITH

THROUGH

SUBFLOOR

SOUND TRANSMISSION

SHEET

SQUARE

SPEC

SQ

STC

STD

STL

STG

STR

SYM

TBD

THK

TOF

TOFF

TOS

TOSTL

TOW

UNFIN

UNO

VCT

VERT

W/O

VIF

TYP

SUBFLR

DRAWING LIST SHEET NO. SHEET NAME GENERAL INDEX, GENERAL NOTES, ABBREVIATION, SYMBOLS & LEGENDS DEMOLITION DEMOLITION FLOOR PLAN DEMOLITION RCP DM.103 DEMOLITION ELEVATION ENERGY EN-001.00 **ENERGY COMPLIANCE SHEET #1** ENERGY COMPLIANCE SHEET #2 EN-002.00 ARCHITECTURAL PROPOSED FLOOR PLAN PROPOSED RCP PROPOSED ELEVATIONS, SECTIONS, AND DETAILS ELECTRICAL ELECTRICAL NOTES, SYMBOLS, ABBREVIATIONS, AND DWG LIST ELECTRICAL 15TH FLOOR AUDIOVISUAL COORDINATION PLAN ELECTRICAL 15TH FLOOR PARTIAL POWER PLAN - AUDITORIUM ELECTRICAL 15TH FLOOR PARTIAL POWER PLAN - SOUTHEAST ELECTRICAL 15TH FLOOR PARTIAL POWER PLAN - SOUTH ELECTRICAL DETAILS AUDIO VISUAL AUDIOVISUAL TITLE SHEET TA.000 TA.001 AUDIOVISUAL SCHEDULES AUDIOVISUAL OVERALL PLAN - LEVEL 15 AUDIOVISUAL OVERALL RCP - LEVEL 15 TA.400 AUDIOVISUAL SECTIONS & ELEVATIONS TA.401 AUDIOVISUAL SECTIONS & ELEVATIONS TA.500 AUDIOVISUAL RISERS TA.700 AUDIOVISUAL SYSTEM DIAGRAMS AUDIOVISUAL SYSTEM DIAGRAMS AUDIOVISUAL SYSTEM DIAGRAMS AUDIOVISUAL SYSTEM DIAGRAMS TA.704 AUDIOVISUAL SYSTEM DIAGRAMS AUDIOVISUAL SYSTEM DIAGRAMS SUMMARY OF WORK INCLUDE, BUT NOT LIMITED TO, THE FOLLOWING GENERAL ITEMS OF WORK: OF CONTRACT WORK MODIFY IF REQUIRED FOR PROPER INSTALLATION. ROOM NAME, NUMBER AND AREA ELECTRICAL DRAWINGS FOR ASSOCIATED ELECTRICAL WORK. A. GENERAL SCOPE

THE WORK SHALL BE AS SHOWN AND CALLED FOR IN THE CONTRACT DOCUMENTS AND SHALL

REMOVE ALL ITEMS THAT INTERFERE WITH CONTRACT WORK, REINSTALL AFTER COMPLETION

- INSTALL AUDIO AND VISUAL EQUIPMENT IN THE AUDITORIUM, CONFERENCE ROOM A, CONFERENCE ROOM B, TRAINING ROOM A, TRAINING ROOM B, TRAINING ROOM C, AND ALL ASSOCIATED STORAGE/AV ROOMS. REFER TO AV DRAWINGS FOR ALL AUDIO-VISUAL EQUIPMENT AND AREAS OF INSTALLATION. REPLACE LIGHTING CONTROLERS, REFER TO
- a. REMOVE EXISTING AV RACKS AND ASSOCIATED WALL OR FLOOR MOUNTED
- EQUIPMENT AND REPLACE WITH NEW AV RACKS UON, REFER TO AV DRAWINGS. b. PER DRAWINGS, REMOVE SELECT ACOUSTIC CEILING TILE TO PREFORM WORK. WHERE THE ACOUSTIC CEILING TILE IS REMOVED AND REPLACED, INSTALL NEW ACOUSTIC CEILING TILE MATCHING THE CEILING SYSTEM, UON.
- REMOVE CEILING TILES FOR MICROPHONES. REFER TO AV DRAWINGS. d. ALL NEW WALL OPENINGS AND ASSOCIATED CUTTING SHOULD BE REPLACED IN KIND AND REFINISHED TO MATCH EXISTING ADJACENT CONSTRUCTION AT NO ADDITIONAL COST TO OWNER.
- e. PRIOR TO ALL WORK TO EXISTING FURNITURE OR EQUIPMENT SHOULD BE SUBMITTED AND ACCEPTED SHOP DRAWINGS DETAILING THE WORK. AUDITORIUM
- REMOVE EXISTING EQUIPMENT IN STORAGE/ AV ROOM (8). b. CAREFULLY REMOVE, SALVAGE, CUT TO SIZE, REFINISH CUT PANELS, AND
- REPLACE IN PLACE EXISTING WOOD WALL PANELS IN THE AUDITORIUM TO ACCOMMODATE THE ENLARGED VIDEO WALL.
- c. CUT AND ENLARGE AUDITORIUM VIDEO WALL OPENING d. INSTALL PARTITION IN STORAGE/ AV ROOM (8) ASSOCIATED WITH AUDITORIUM TO HOLD THE WEIGHT OF THE VIDEO WALL

e. INSTALL CEILING MOUNTED MONITORS TO EXISTING STRUCTURE. AT STRUCTURAL

- STEEL WRAPPED IN FIRE-PROOFING. REMOVE AND REPLACE FIRE-PROOFING TO MATCH EXISTING ADJACENT CONSTRUCTION. REPLACE ACOUSTIC CEILING TILE WITH CEILING COVER TILE FOR ALL AV EQUIPMENT AND CEILING HUNG MONITOR
- CONFERENCE ROOM A a. INSTALL CAMERAS AT WALL LOCATIONS, REFER TO AV DRAWINGS.
- b. INSTALL PROJECTOR, REFER TO AV DRAWINGS. D. CONFERENCE ROOM B
- a. CAREFULLY, REMOVE EXISTING DISPLAYS AND CAMERA. PATCH AND REPAIR WOODWORK IN KIND.
- TRAINING ROOM A, B, AND C a. REMOVE AND INSTALL ACOUSTIC WALL COVERINGS PER LOCATIONS ON
- DRAWINGS b. CUT PARTITIONS FOR VIDEO HANGER STRUCTURAL SUPPORT AS REQUIRED BY STRUCTURAL SUPPORT INSTALLATION. REPLACE GYPSUM SUBSTRATE PRIOR TO REINSTALLING ACOUSTIC WALL COVERINGS.
- REFER TO ELECTRICAL DRAWINGS FOR ADDITIONAL SCOPE OF WORK.

REFER TO AV DRAWINGS FOR ADDITIONAL SCOPE OF WORK.

ALLOWANCES

THE CONTRACTOR SHALL INCLUDE IN THEIR BID PRICE AN EXPECTED UNIT COST AMOUNT TO BE INCLUDED IN THE CONTINGENCY ALLOWANCE, BUT NOT ADDED, FOR EACH OF THE

THE UNIT PRICE PER SF FOR REPLACEMENT OF CONCRETE FIRE STOPPING ENCLOSURE ASSEMBLY AND FIRESAFING PENETRATION JOINT. THE UNIT PRICE PER CEILING TILE FOR REPLACEMENT OF CEILING TILES OF UP TO 50 SF.

SPECIAL INSPECTIONS

SPECIAL INSPECTIONS REQUIRED UNDER THIS APPLICATION IN ACCORDANCE WITH CHAPTER 17 AND THE APPLICABLE SECTIONS OF THE NYS BUILDING CODE ARE LISTED IN THE BELOW

THE CONTRACTOR MUST NOTIFY THE RELEVANT SPECIAL INSPECTOR OR SPECIAL INSPECTION AGENCY IN WRITING FOR SPECIAL INSPECTIONS AT LEAST 72 HOURS BEFORE THE SPECIFIC WORK COMMENCES.

4. INSPECT ANCHORS POST-INSTALLED CONTINUOUS IN HARDENED CONCRETE MEMBERS.

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NYSIF-AV 15th Floor Upgrades



ARCHITECTUR

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CONSULTANT:

12/11/24 OGS SUBMISSION NO: DATE: DESCRIPTION: KEY PLAN:

SEAL AND SIGNATURE

CHURCH STREET




OGS PROJECT NO. SF760

DRAWING TITLE:

INDEX, GENERAL NOTES, ABBREVIATION, SYMBOLS & LEGENDS

12/11/24 21-048-1165.02 As indicated DRAWING NO.:

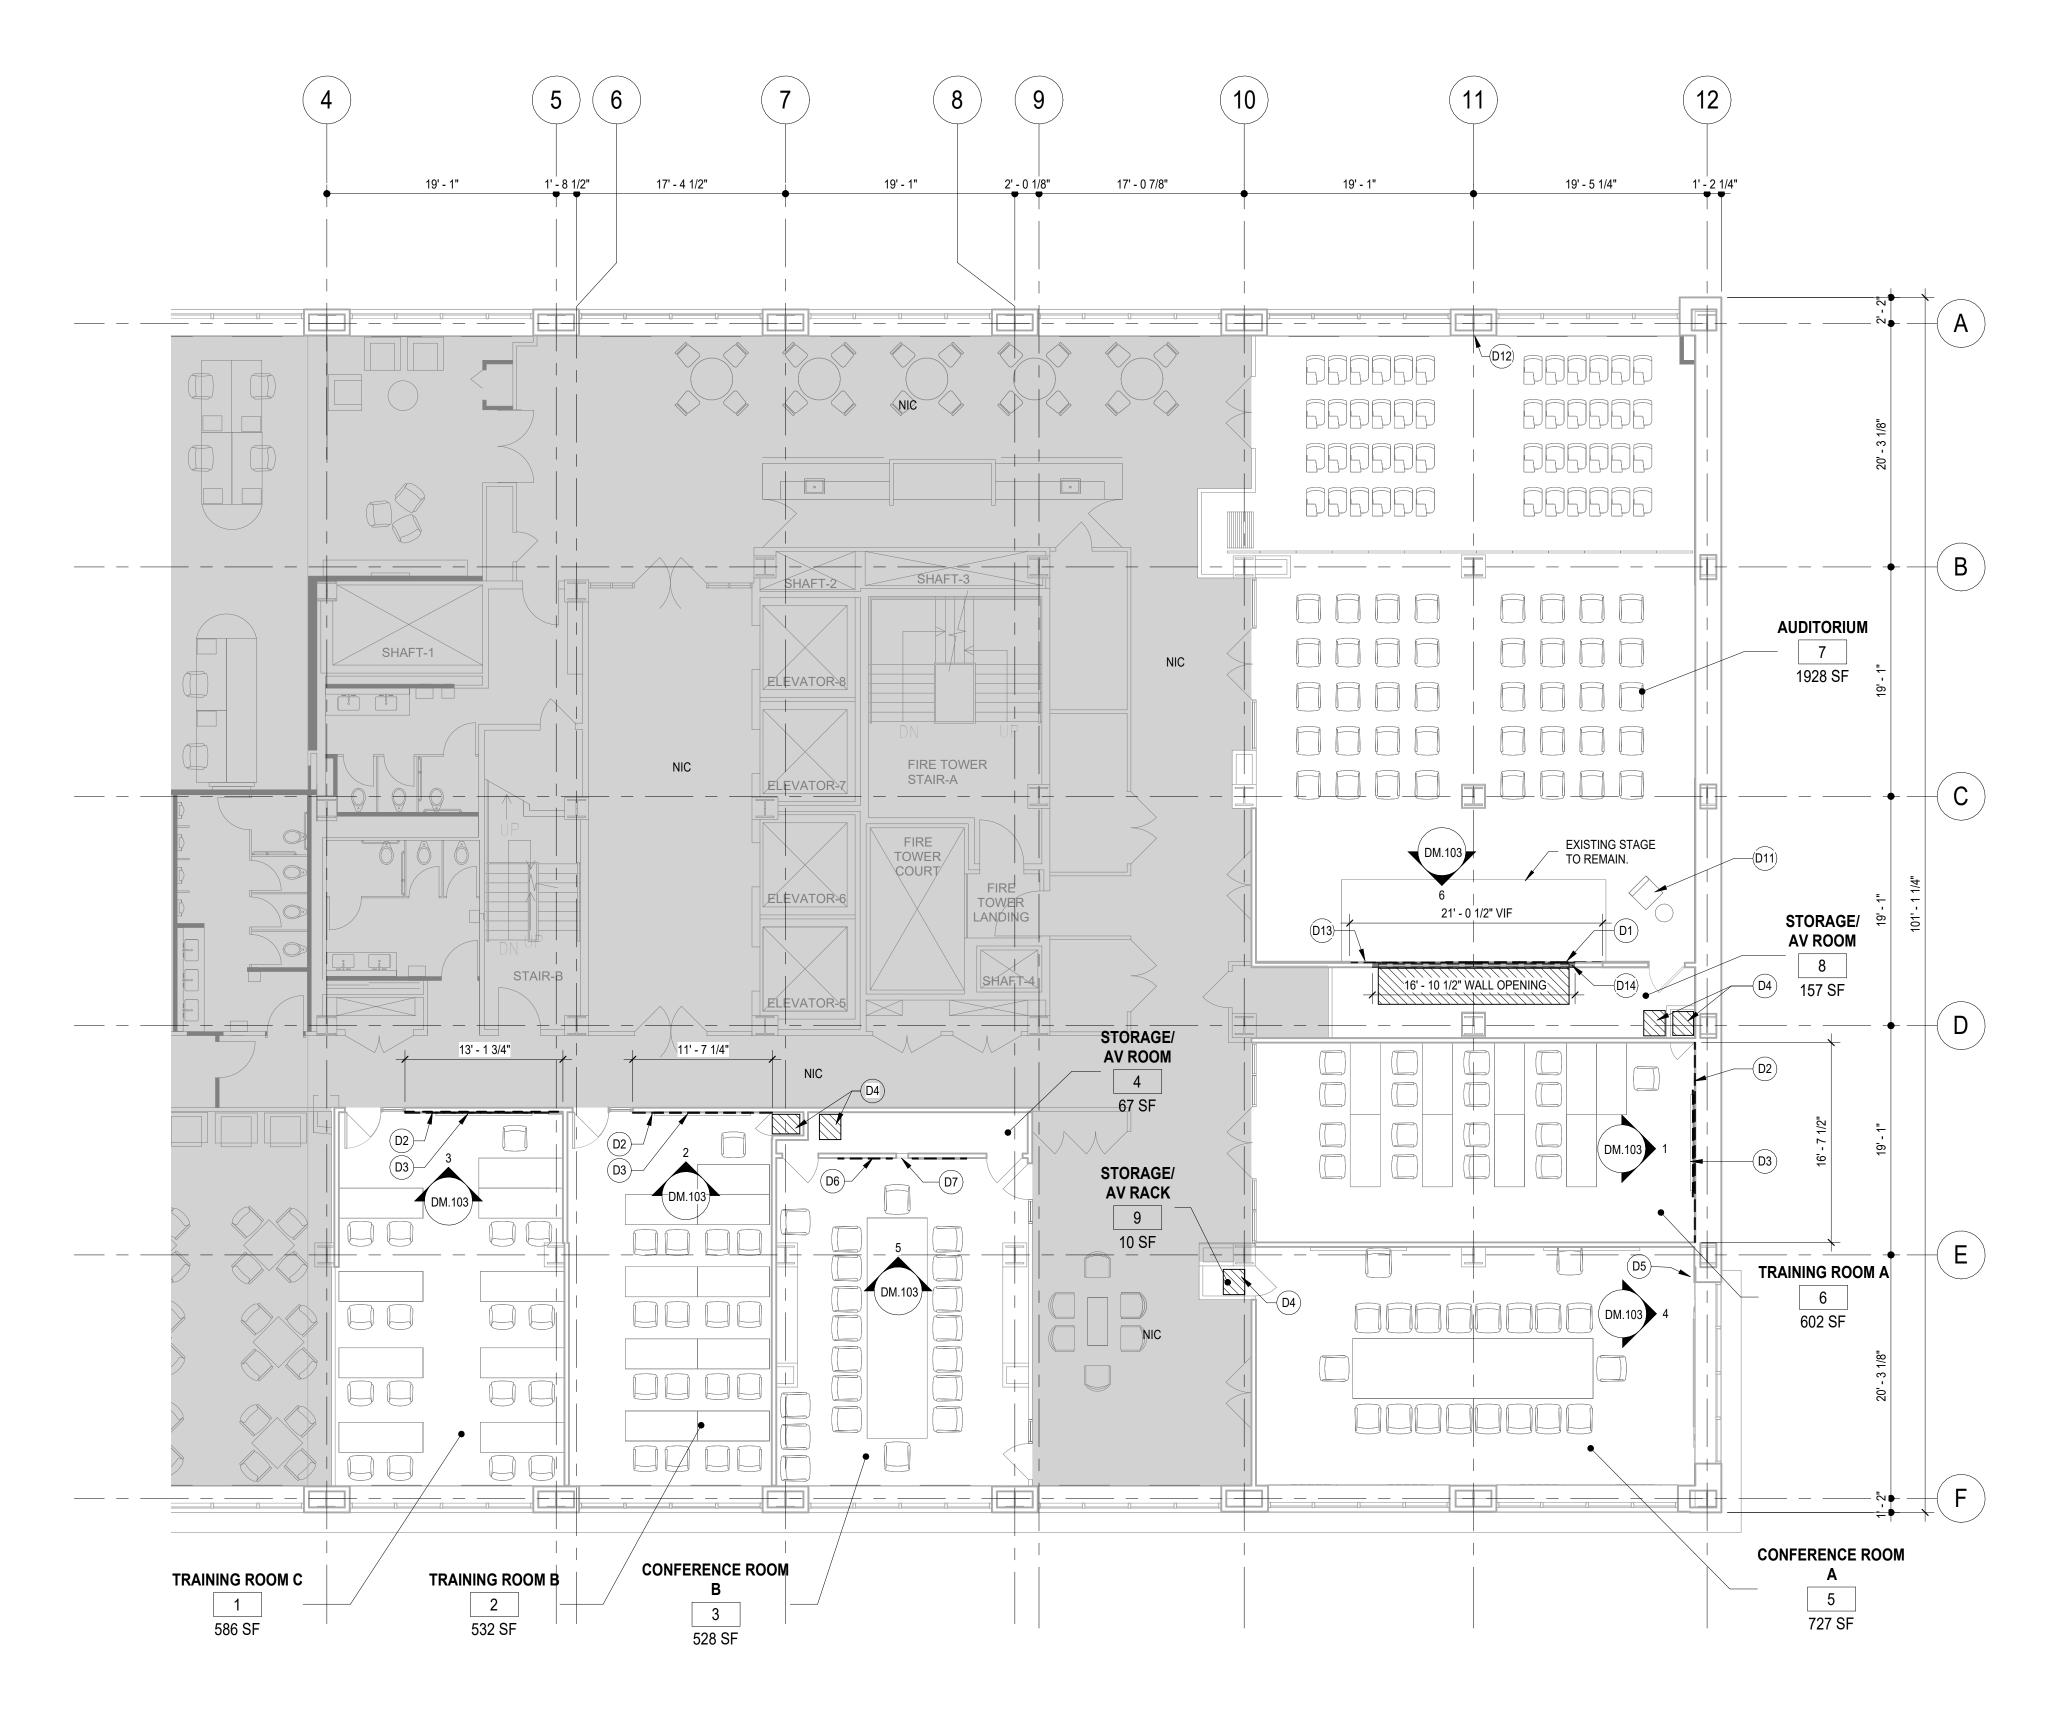

1 DEMO FLOOR PLAN - 15TH FLOOR 1/8" = 1'-0"

DEMOLITION KEYNOTES REMOVE EXISTING SCREENS AND ASSOCIATED EQUIPMENT IN THEIR REMOVE ACOUSTIC PANEL IN IT'S ENTIRETY. FILL AND PATCH BACKUP WALL T RECEIVE NEW FINISH. REMOVE AND SALVAGE EXISTING WHITEBOARD. TURN WHITE BOARD OVER TO REMOVE AV RACK IN IT'S ENTRIETY, PREPARE SPACE TO RECEIVE A NEW AV RACK. REFER TO AV DRAWINGS. REMOVE AND SALVAGE EXISTING CAMERA. WALL MOUNTING BRACKET TO REMAIN, UON. TURN OVER TO OWNER. REMOVE AND SALVAGE EXISTING SCREENS. TURN OVER TO OWNER. REMOVE AND SALVAGE EXISTING CAMERA. TURN OVER TO OWNER. REMOVE EXISTING AV EQUIPMENT AND PREPARE FOR NEW AV EQUIPMENT. REFER TO AV DRAWINGS. CUT WALL OPENING TO INSTALL AUDIO-VISUAL INPUTS, REFER TO AV DRAWINGS. CAREFULLY REMOVE EXISTING WOOD PANELING AND SALVAGE FOR RE-INSTALLATION. PREPARE WALL STRUCTURE TO CUT WALL OPENING. CUT WALL OPENING WIDER, REFER TO CONSTRUCTION DETIALS.



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199 Church Street, New York, 10007

NYSIF-AV 15th Floor Upgrades




ARCHITECTURE ONE STATE STREET PLAZ.
28TH FLOOR
NEW YORK NY 10004

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SEAL AND SIGNATURE



OGS PROJECT NO. SF760

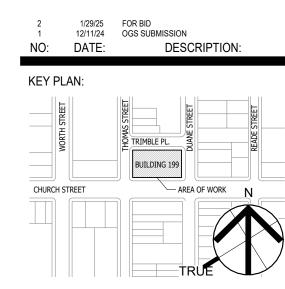DRAWING TITLE:


DEMOLITION FLOOR PLAN

12/11/24

PROJECT NO: SCALE
21-048-1165.02 1/8" = 1'-0"

DM.101

PROJECT LOCATION:

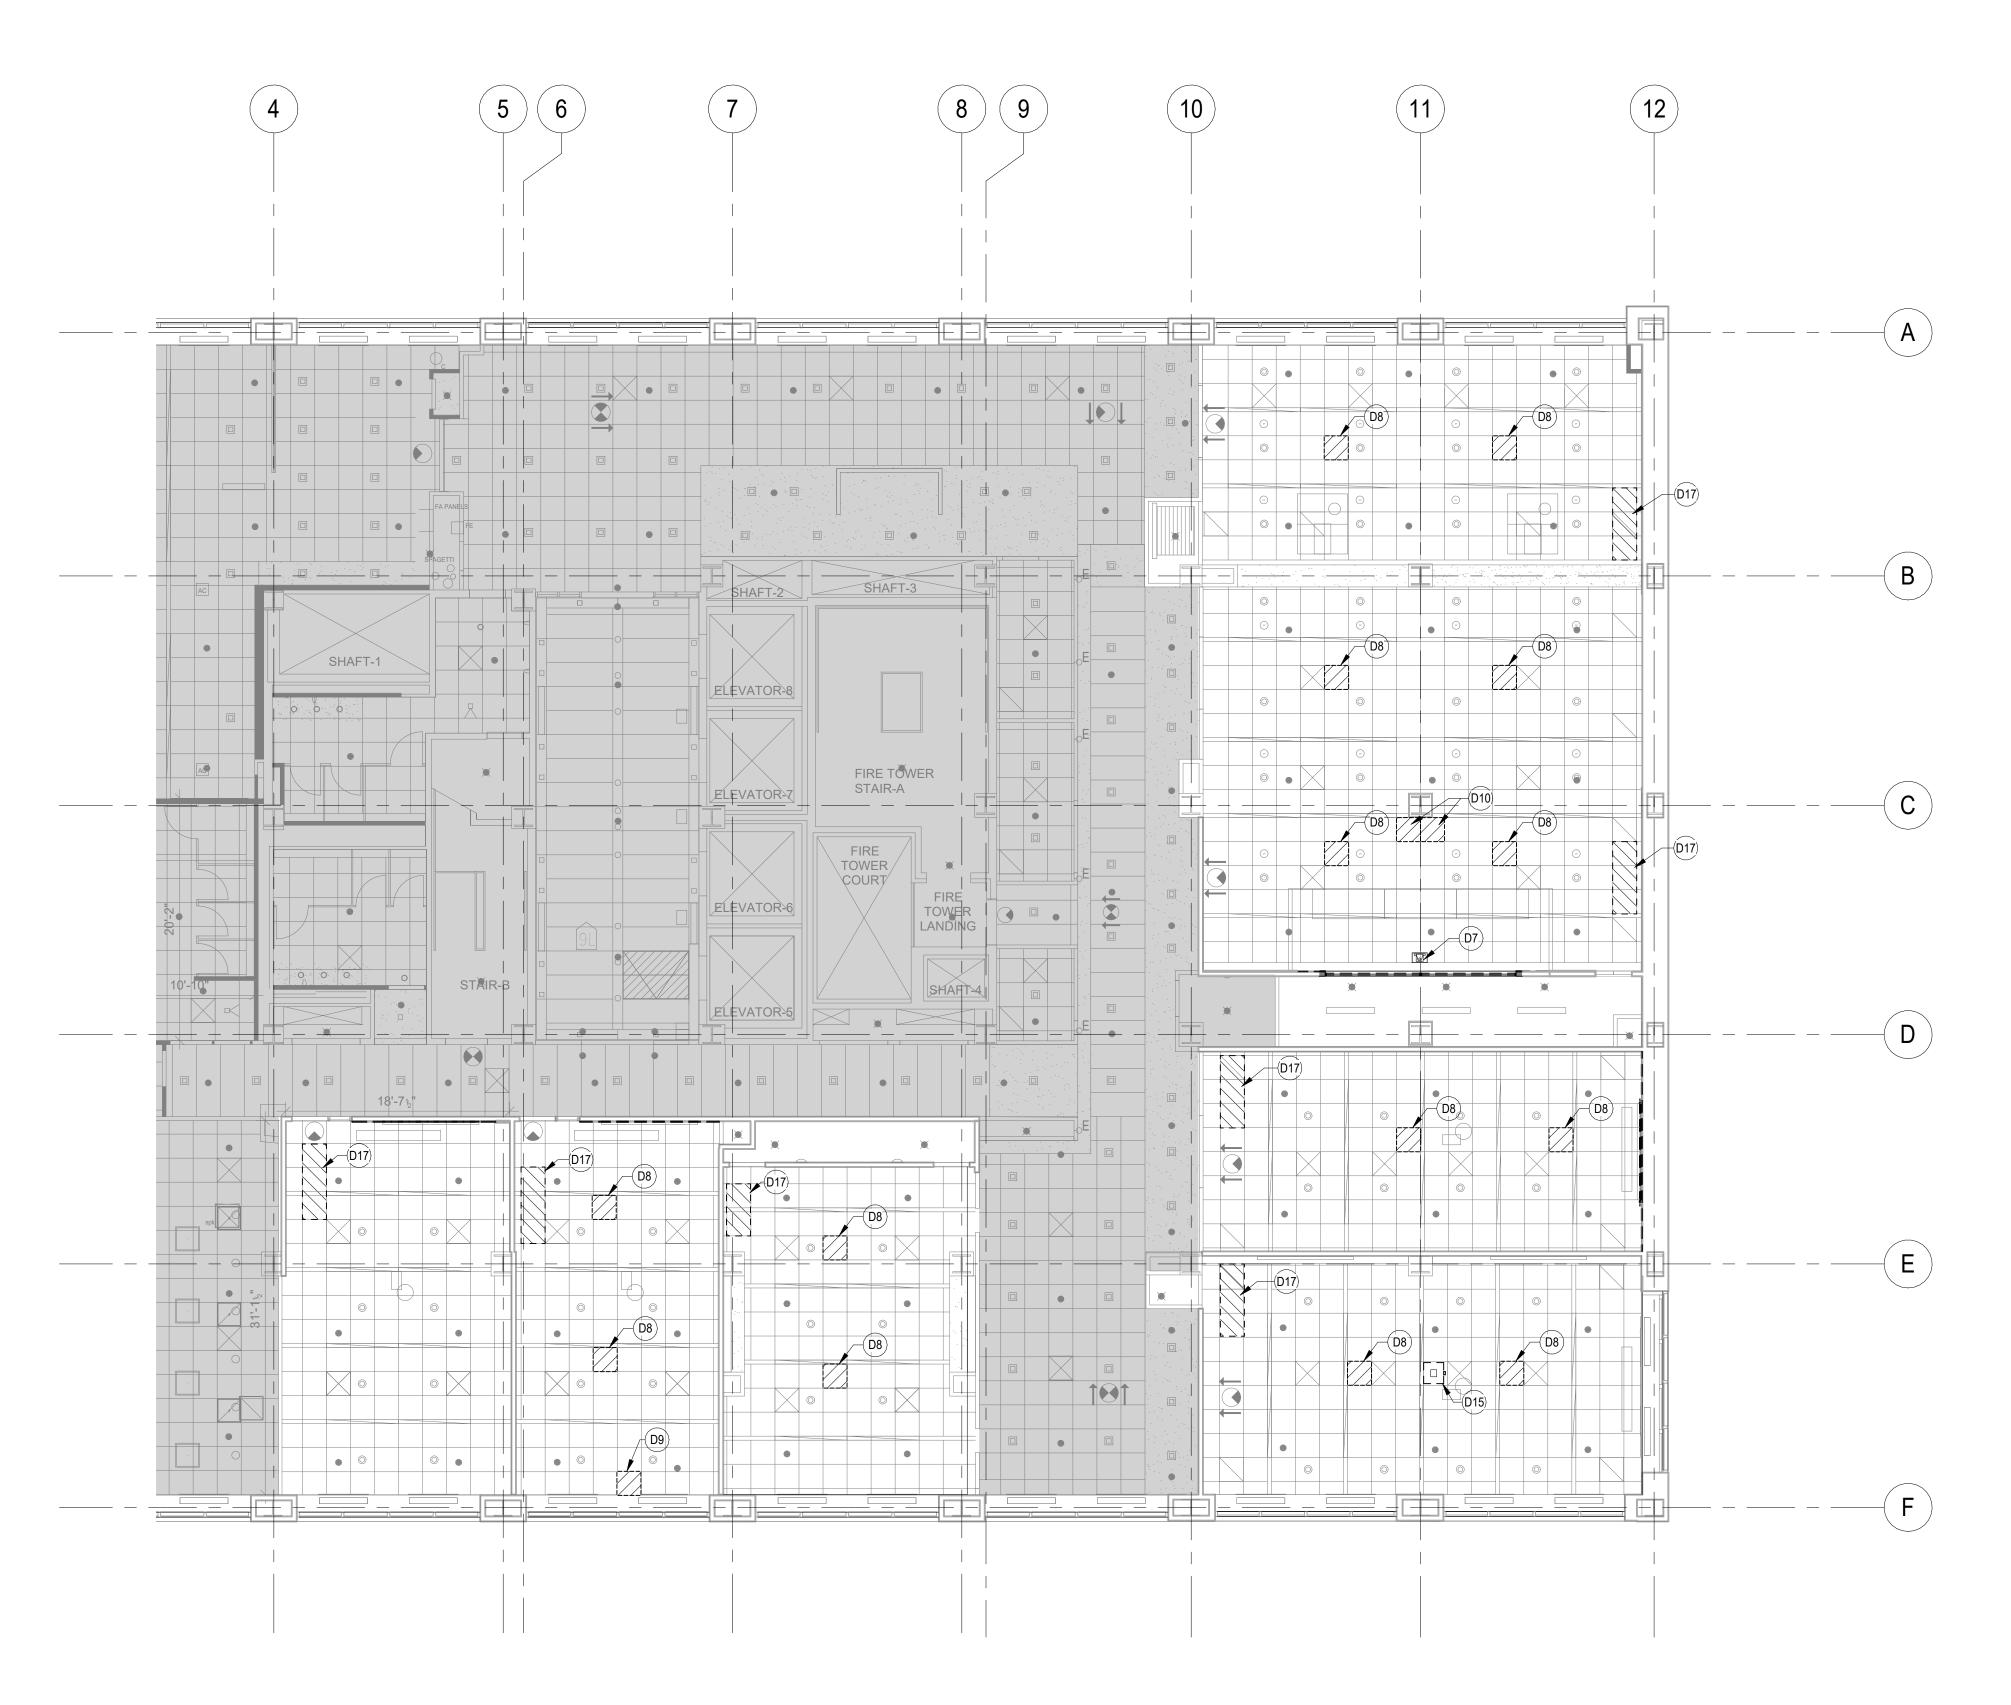

1	DEMO REFLECTED CEILING PLAN - 15TH FLOOR
	1/8" = 1'-0"



NEW YORK STATE INSURANCE FUND

199 Church Street, New York, 10007

NYSIF-AV 15th Floor Upgrades






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OGS PROJECT NO. SF760

DRAWING TITLE:
DEMOLITION RCP

ISSUE DATE:	
12/11/24	
PROJECT NO.:	SCALE:
21-048-1165.02	1/8" = 1'-0"
DRAWING NO.:	

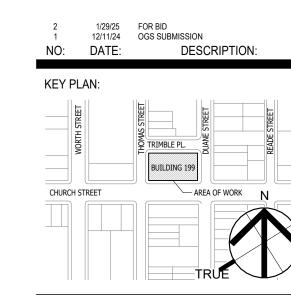DM.102

PROJECT LOCATION:

DEMOLITION KEYNOTES				
KEYNOTE	NOTE			
D1	REMOVE EXISTING SCREENS AND ASSOCIATED EQUIPMENT IN THEIR ENTIRETY.			
D2	REMOVE ACOUSTIC PANEL IN IT'S ENTIRETY. FILL AND PATCH BACKUP WALL RECEIVE NEW FINISH.			
D3	REMOVE AND SALVAGE EXISTING WHITEBOARD. TURN WHITE BOARD OVER ONWER.			
D6	REMOVE AND SALVAGE EXISTING SCREENS. TURN OVER TO OWNER.			
D7	REMOVE AND SALVAGE EXISTING CAMERA. TURN OVER TO OWNER.			
D16	CUT EXISTING GYP/STUD WALL TO RECIEVE EXTRA WALL STRUCTURE AND FLUSH IN-WALL MOUNTING SYSTEM, REFER TO AV DRAWINGS.			



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NYSIF-AV 15th Floor Upgrades






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SEAL AND SIGNATURE

CEILING 65' - 6"

LEVEL 15 15TH FLOOR 55' - 6" 55' - 6"

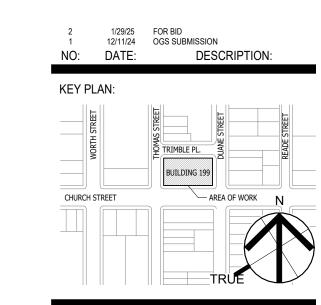CEILING
65' - 6"

PERMENANTLY ROLL UP
EXISTING PROJECTOR

SCREEN.

EXSTING WOOD BASE TO REMAIN. TYP.

15 RCF15TH FLOOR 55' - 6" 55' - 6"



OGS PROJECT NO. SF760

DRAWING TITLE:


DEMOLITION ELEVATION

ISSUE DATE:	
12/11/24	
PROJECT NO.:	SCALE:
21-048-1165.02	1/4" = 1'-0"

DRAWING NO.:

DM.103

PROJECT LOCATION:
Autodesk Docs://NYSIF A/21-048-1165.02_ARC_NYSIF_LH.rvt

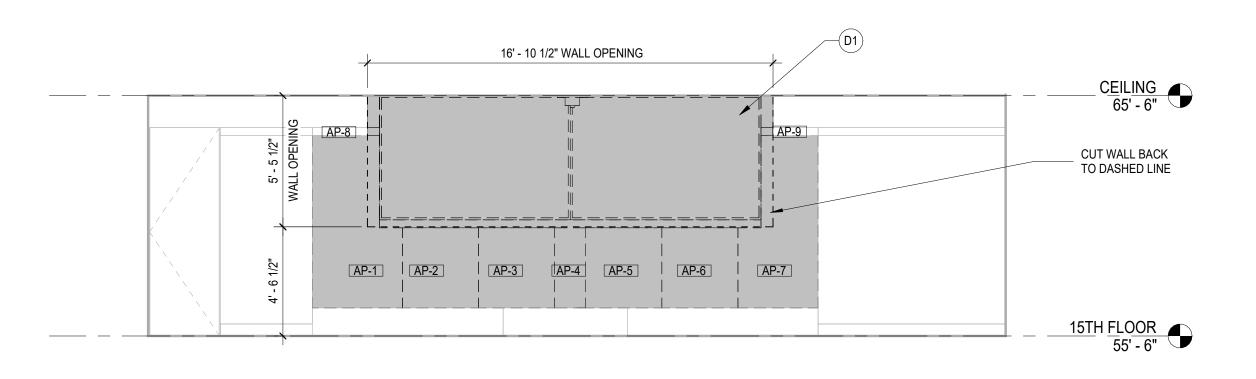

DEMO ELEVATION - CONFERENCE ROOM A - D

EQ


DEMO ELEVATION - TRAINING ROOM A - D


EQ

4' - 0" (D16)
OPENING


4 1/4" = 1'-0"



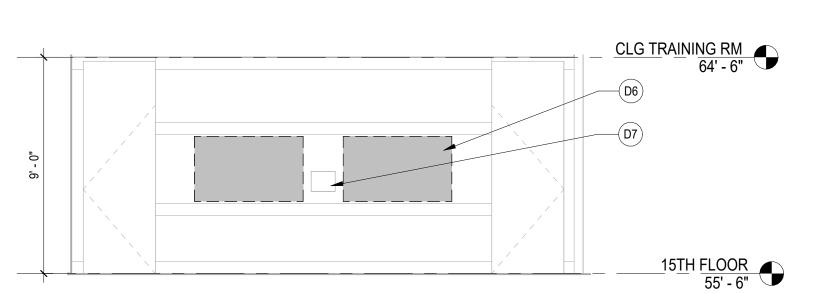

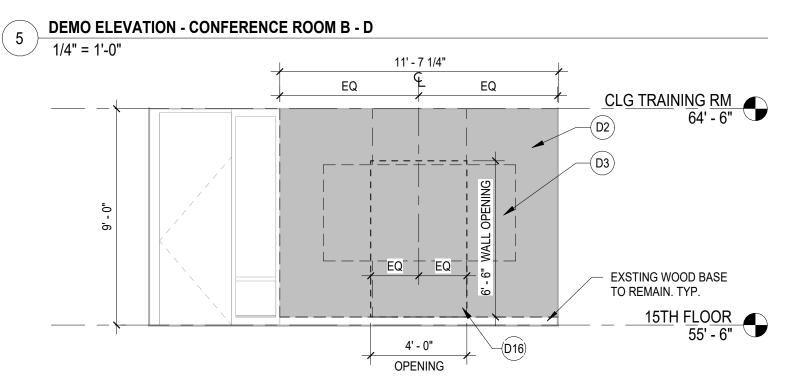

DEMO ELEVATION - TRAINING ROOM B - D

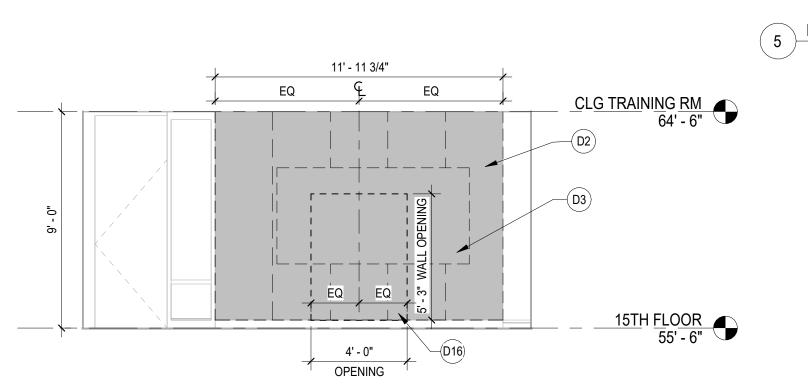

DEMO ELEVATION - TRAINING ROOM C - D 1/4" = 1'-0"

1/4" = 1'-0"

ENERGY COMPLIANCE DRAWING LIST						
SHEET NO.	SHEET NAME	REVISON NO.	REVISION DATE			
EN-001.00	ENERGY COMPLIANCE SHEET #1	0	1			
EN-002.00	ENERGY COMPLIANCE SHEET #2	0	-			

TABL	LE II - PROGRESS INSPECTION FOR EN	NERGY CODE C	COMPLIANCE -	- COMMERCIAL BUILDING
П	INSPECTION/TEST	REFERENCE	ECC OR OTHER	MIN. PERIODIC

IABL	TABLE II - PROGRESS INSPECTION FOR ENERGY CODE COMPLIANCE - COMMERCIAL BUILDINGS					
II	INSPECTION/TEST	REFERENCE STANDARDS	ECC OR OTHER CITATION	MIN. PERIODIC INSPECTION FREQUENCY		
IIC	ELECTRICAL POWER AND LIGHTING SYSTEMS					
IIC3	INTERIOR LIGHTING POWER: INSTALLED LIGHTING MUST BE VERIFIED FOR COMPLIANCE WITH THE LIGHT POWER ALLOWANCE BY VISUAL INSPECTION OF FIXTURES.	APPROVED CONSTRUCTION DOCUMENTS	NYSECC C405.3, C406	PRIOR TO FINAL ELECTRICAL AND CONSTRUCTION INSPECTION		
IIC5	LIGHTING CONTROLS: EACH TYPE OF REQUIRED LIGHTING CONTROLS, INCLUDING: AUTOMATIC INTERIOR LIGHTING CONTROLS	APPROVED CONSTRUCTION DOCUMENTS	NYSECC C405.2, C406	PRIOR TO FINAL ELECTRICAL AND CONSTRUCTION INSPECTION		
IID	OTHER					
IID1	MAINTENANCE INFORMATION: MAINTENANCE MANUAL FOR MECHANICAL, SERVICE HOT WATER AND ELECTRICAL EQUIPMENT AND SYSTEMS REQUIRING PREVENTATIVE MAINTENANCE MUST BE REVIEWED FOR APPLICABILITY TO INSTALLED EQUIPMENT AND SYSTEM BEFORE SUCH MANUALS ARE PROVIDED TO THE OWNER. LABELS REQUIRED FOR SUCH EQUIPMENT OR SYSTEMS MUST BE INSPECTED FOR ACCURACY AND COMPLETENESS.	APPROVED CONSTRUCTION DOCUMENTS, INCLUDING ELECTRICAL DRAWINGS WHERE APPLICABLE	NYSECC C408.1.1, C408.2.5, C408.3.2	PRIOR TO FINAL ELECTRICAL AND CONSTRUCTION INSPECTION		

2020 NYS ENERGY AND CONSERVATION CODE COMPLIANCE STATEMENT

TO THE BEST OF MY KNOWLEDGE, BELIEF, AND PROFESSIONAL JUDGMENT THESE PLANS AND SPECIFICATIONS ARE IN COMPLIANCE WITH THE 2020 ENERGY CONSERVATION CODE OF NEW YORK STATE.

THE DETERMINATION THAT THE PROPOSED ALTERATION MEETS NYSECC IS BASED ON THE ATTACHED TABULAR ANALYSIS.

2020 NYS ENERGY CONSERVATION CODE **INTERIOR LIGHTING NOTES**


NEW LIGHTING CONTROLS SHALL BE PROVIDED TO RENOVATED INTERIOR SPACES IN ACCORDANCE WITH THE 2020 NYS ENERGY CONSERVATION CODE. REFER TO SHEET EN-002 FOR ELECTRICAL LIGHTING PLAN.


ALL LIGHT FIXTURES ARE EXISTING TO REMAIN. FIXTURES ARE EXEMPT FROM 2020 NYSECC POWER DENSITY REQUIREMENTS BASED ON THE EXEMPTION IN C503.6: ALTERATIONS THAT REPLACE LESS THAN 10 PERCENT OF THE LUMINAIRES IN A SPACE, PROVIDED THAT SUCH ALTERATIONS DO NOT INCREASE THE INSTALLED INTERIOR LIGHTING POWER.


ZONE LIGHT MANUAL					ALITOMATIC CONTROL S
ROOM	TAG	FIXTURES	DIMMING	CONTROLS	AUTOMATIC CONTROLS
	a,b	8-ft linears, 6-ft linears	0-10V	On and up/down via wall-mounted low voltage dimmer.	Auto off after 15 minutes unoccupied via ceiling-mounted dual tech vacancy sensor. Daylight response automatic dimming by ceiling-mounted photosensor.
	c,d,k	6-inch round downlights	0-10V	On and up/down via wall-mounted low voltage dimmer.	Auto off after 15 minutes unoccupied via ceiling-mounted dual tech vacancy sensor.
Auditorium	f	Linear cove lighting	0-10V	On and up/down via wall-mounted low voltage dimmer.	Auto off after 15 minutes unoccupied via ceiling-mounted dual tech vacancy sensor.
	g	8-ft linears, 6-ft linears	0-10V	On and up/down via wall-mounted low voltage dimmer.	Auto off after 15 minutes unoccupied via ceiling-mounted dual tech vacancy sensor. Daylight response automatic dimming by ceiling-mounted photosensor.
	j	6-inch round downlights	0-10V	On and up/down via wall-mounted low voltage dimmer.	Auto off after 15 minutes unoccupied via ceiling-mounted dual tech vacancy sensor.
"Training Rooms	a,b	6-ft linears	0-10V	On and up/down via wall-mounted low voltage dimmer.	Auto off after 15 minutes unoccupied via ceiling-mounted dual tech vacancy sensor.
1,2,3"	С	6-inch round downlights	0-10V	On and up/down via wall-mounted low voltage dimmer.	Auto off after 15 minutes unoccupied via ceiling-mounted dual tech vacancy sensor.
	а	6-ft linears	0-10V	On and up/down via wall-mounted low voltage dimmer.	Auto off after 15 minutes unoccupied via ceiling-mounted dual tech vacancy sensor.
	b	6-ft linears	0-10V	On and up/down via wall-mounted low voltage dimmer.	Auto off after 15 minutes unoccupied via ceiling-mounted dual tech vacancy sensor. Daylight response automatic dimming by ceiling-mounted photosensor.
Conf Room A	С	6-inch round downlights	0-10V	On and up/down via wall-mounted low voltage dimmer.	Auto off after 15 minutes unoccupied via ceiling-mounted dual tech vacancy sensor.
	d	6-inch round downlights	0-10V	On and up/down via wall-mounted low voltage dimmer.	Auto off after 15 minutes unoccupied via ceiling-mounted dual tech vacancy sensor. Daylight response automatic dimming by ceiling-mounted photosensor.
	е	Linear cove lighting	0-10V	On and up/down via wall-mounted low voltage dimmer.	Auto off after 15 minutes unoccupied via ceiling-mounted dual tech vacancy sensor.
	a,b	6-ft linears	0-10V	On and up/down via wall-mounted low voltage dimmer.	Auto off after 15 minutes unoccupied via ceiling-mounted dual tech vacancy sensor.
Conf Room B	С	6-inch round downlights	0-10V	On and up/down via wall-mounted low voltage dimmer.	Auto off after 15 minutes unoccupied via ceiling-mounted dual tech vacancy sensor.
	d	Linear cove lighting	0-10V	On and up/down via wall-mounted low voltage dimmer.	Auto off after 15 minutes unoccupied via ceiling-mounted dual tech vacancy sensor.




Phase\Drawings\NYSIF AV Upgrade ComCheck.cck

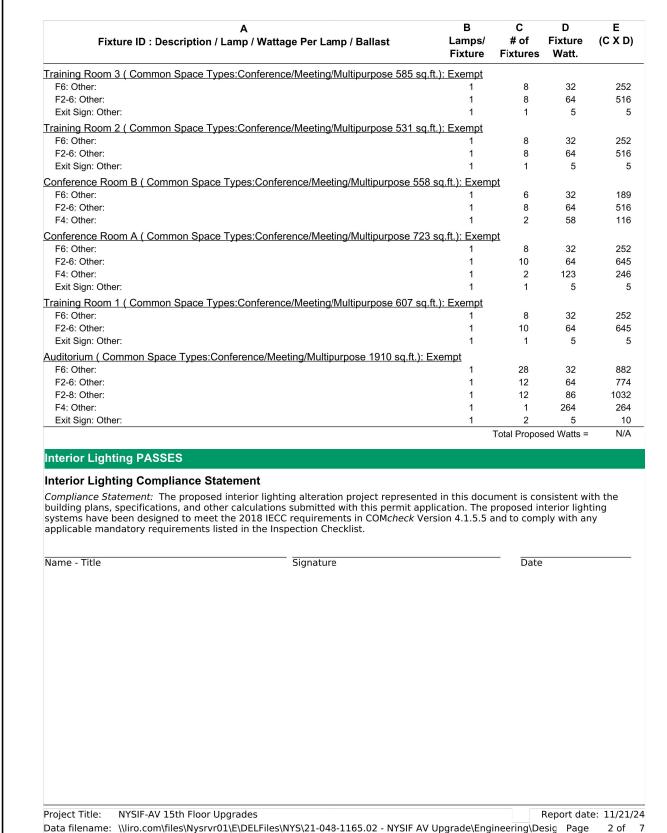

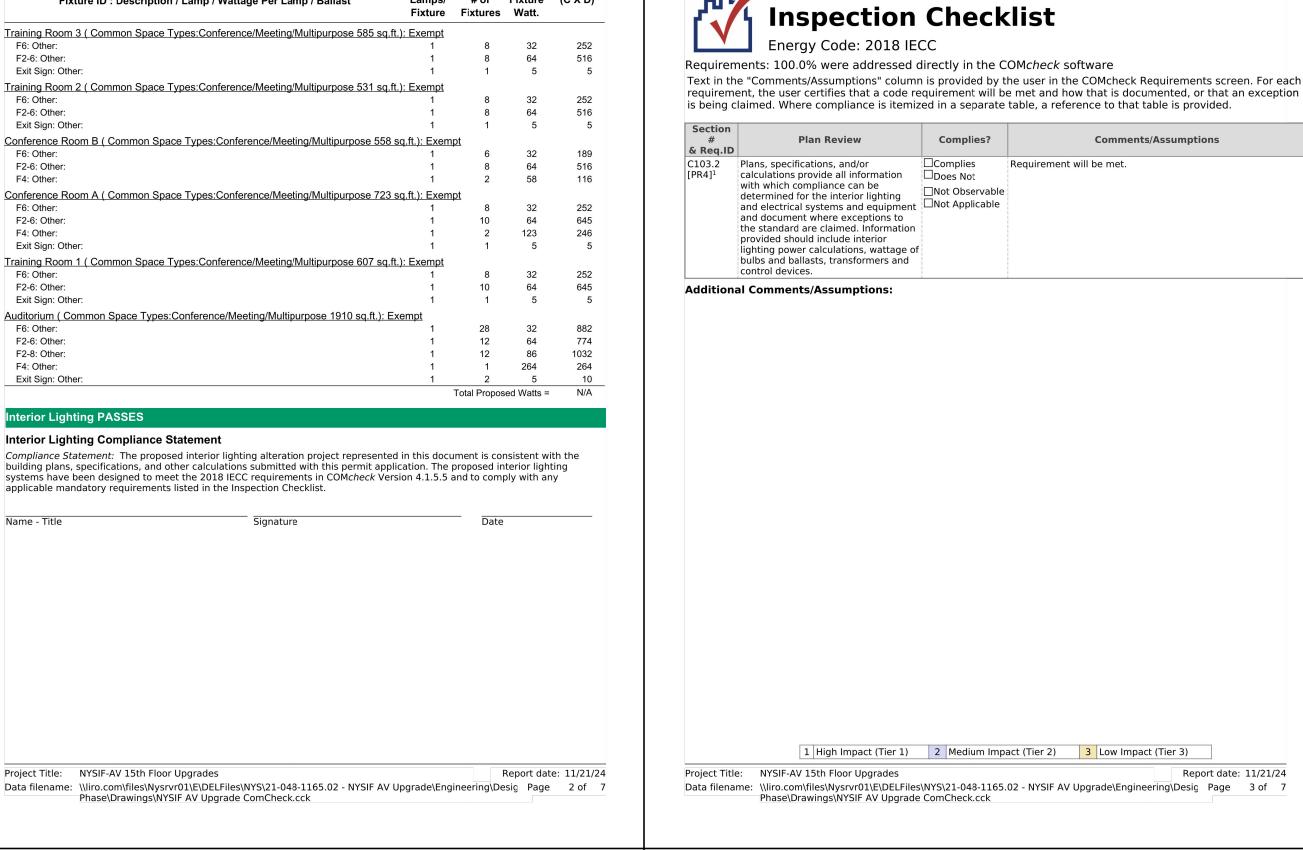

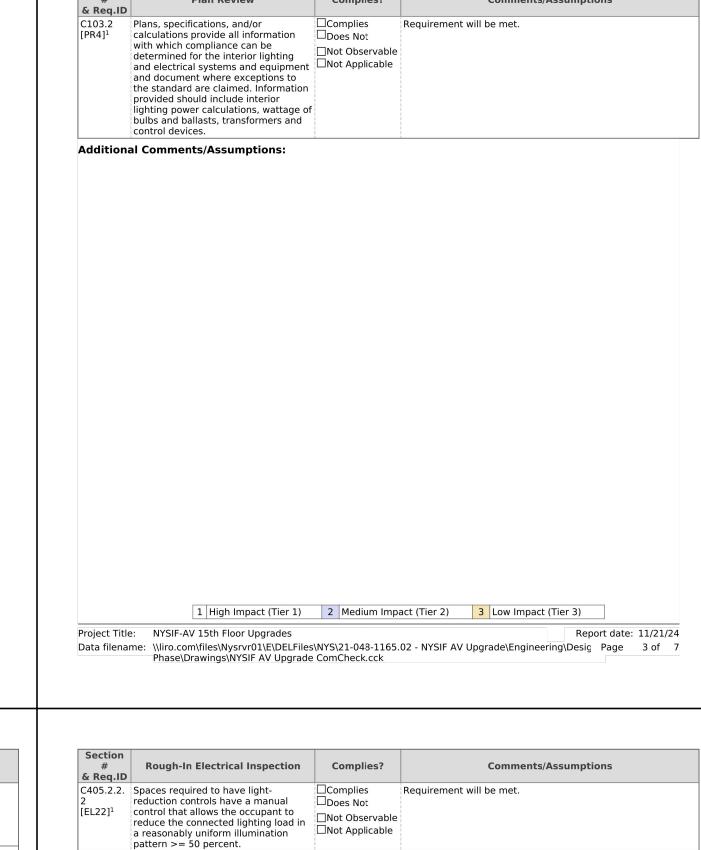

COM*check* Software Version 4.1.5.5

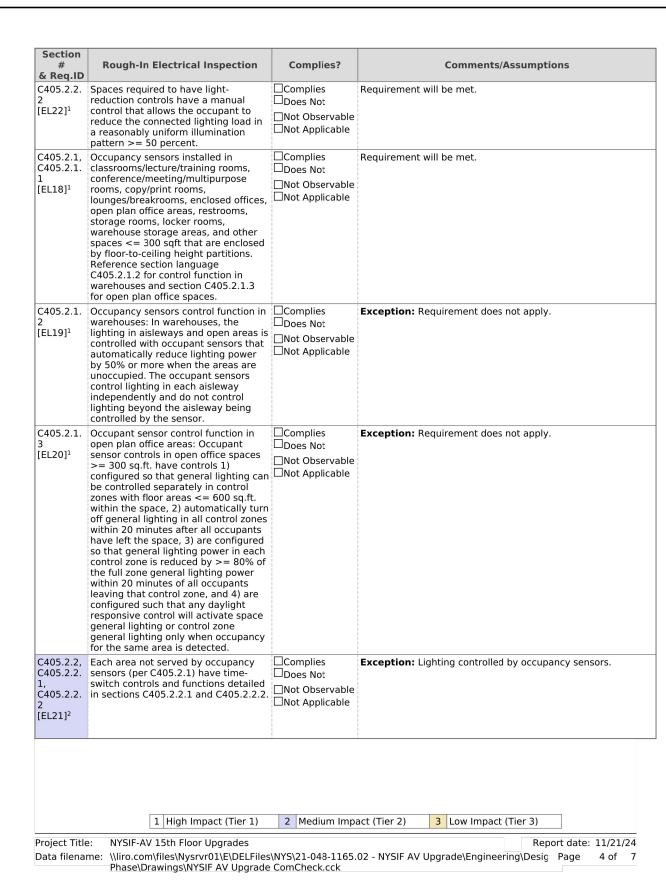



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NYSIF-AV 15th Floor Upgrades





■ NEW YORK CITY ONE STATE STREET PLAZA, 28TH FLOOR NEW YORK, NY 10004 212-563-0280 [P] 212-563-1841 [F] ARCHITECTURE

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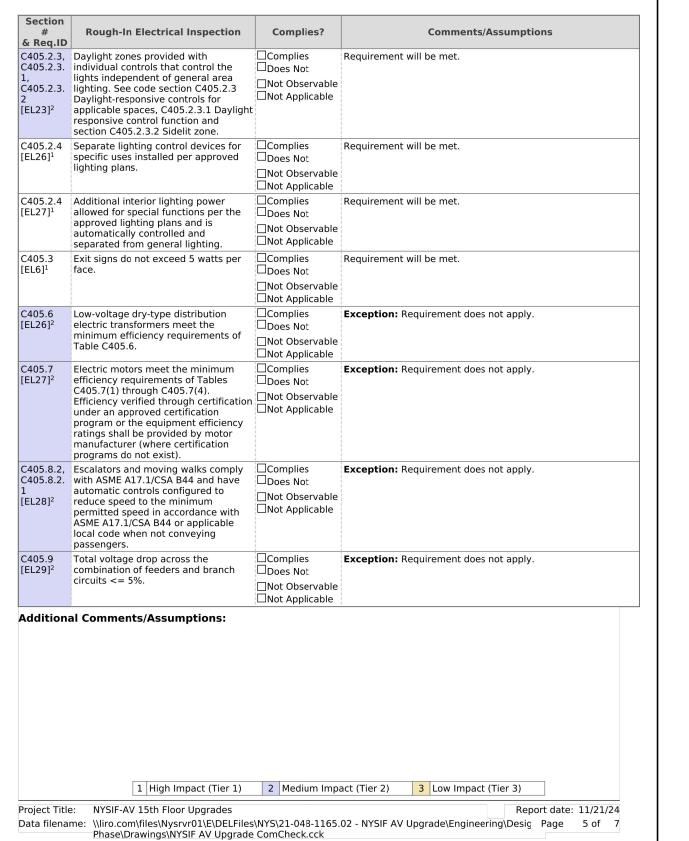



POFESSIONAL BENEFIT OF THE PROPERTY OF THE PRO
OGS PROJECT NO. SF760

DRAWING TITLE: **ENERGY COMPLIANCE SHEET #1**

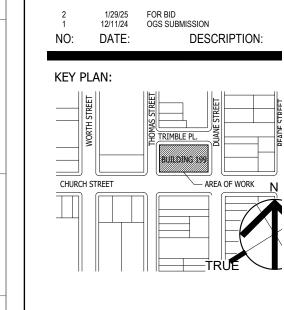
12/11/24 PROJECT NO.: NOT TO SCALE 21-048-1165.02 DRAWING NO.:

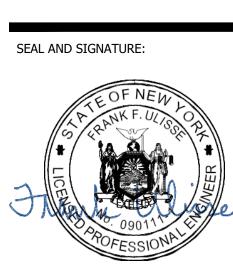Autodesk Docs://NYSIF A/21-048-1165.02_ARC_NYSIF_LH.rvt



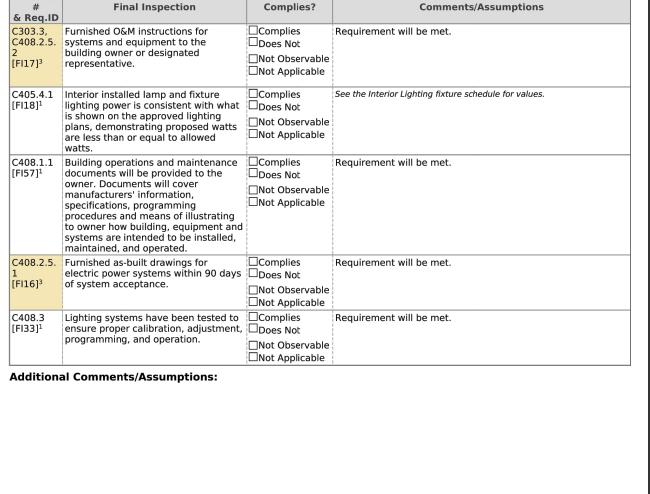

1 High Impact (Tier 1) 2 Medium Impact (Tier 2) 3 Low Impact (Tier 3) Project Title: NYSIF-AV 15th Floor Upgrades Report date: 11/21/24 Data filename: \\liro.com\files\Nysrvr01\E\DELFiles\NYS\21-048-1165.02 - NYSIF AV Upgrade\Engineering\Desig Page 6 of 7 Phase\Drawings\NYSIF AV Upgrade ComCheck.cck

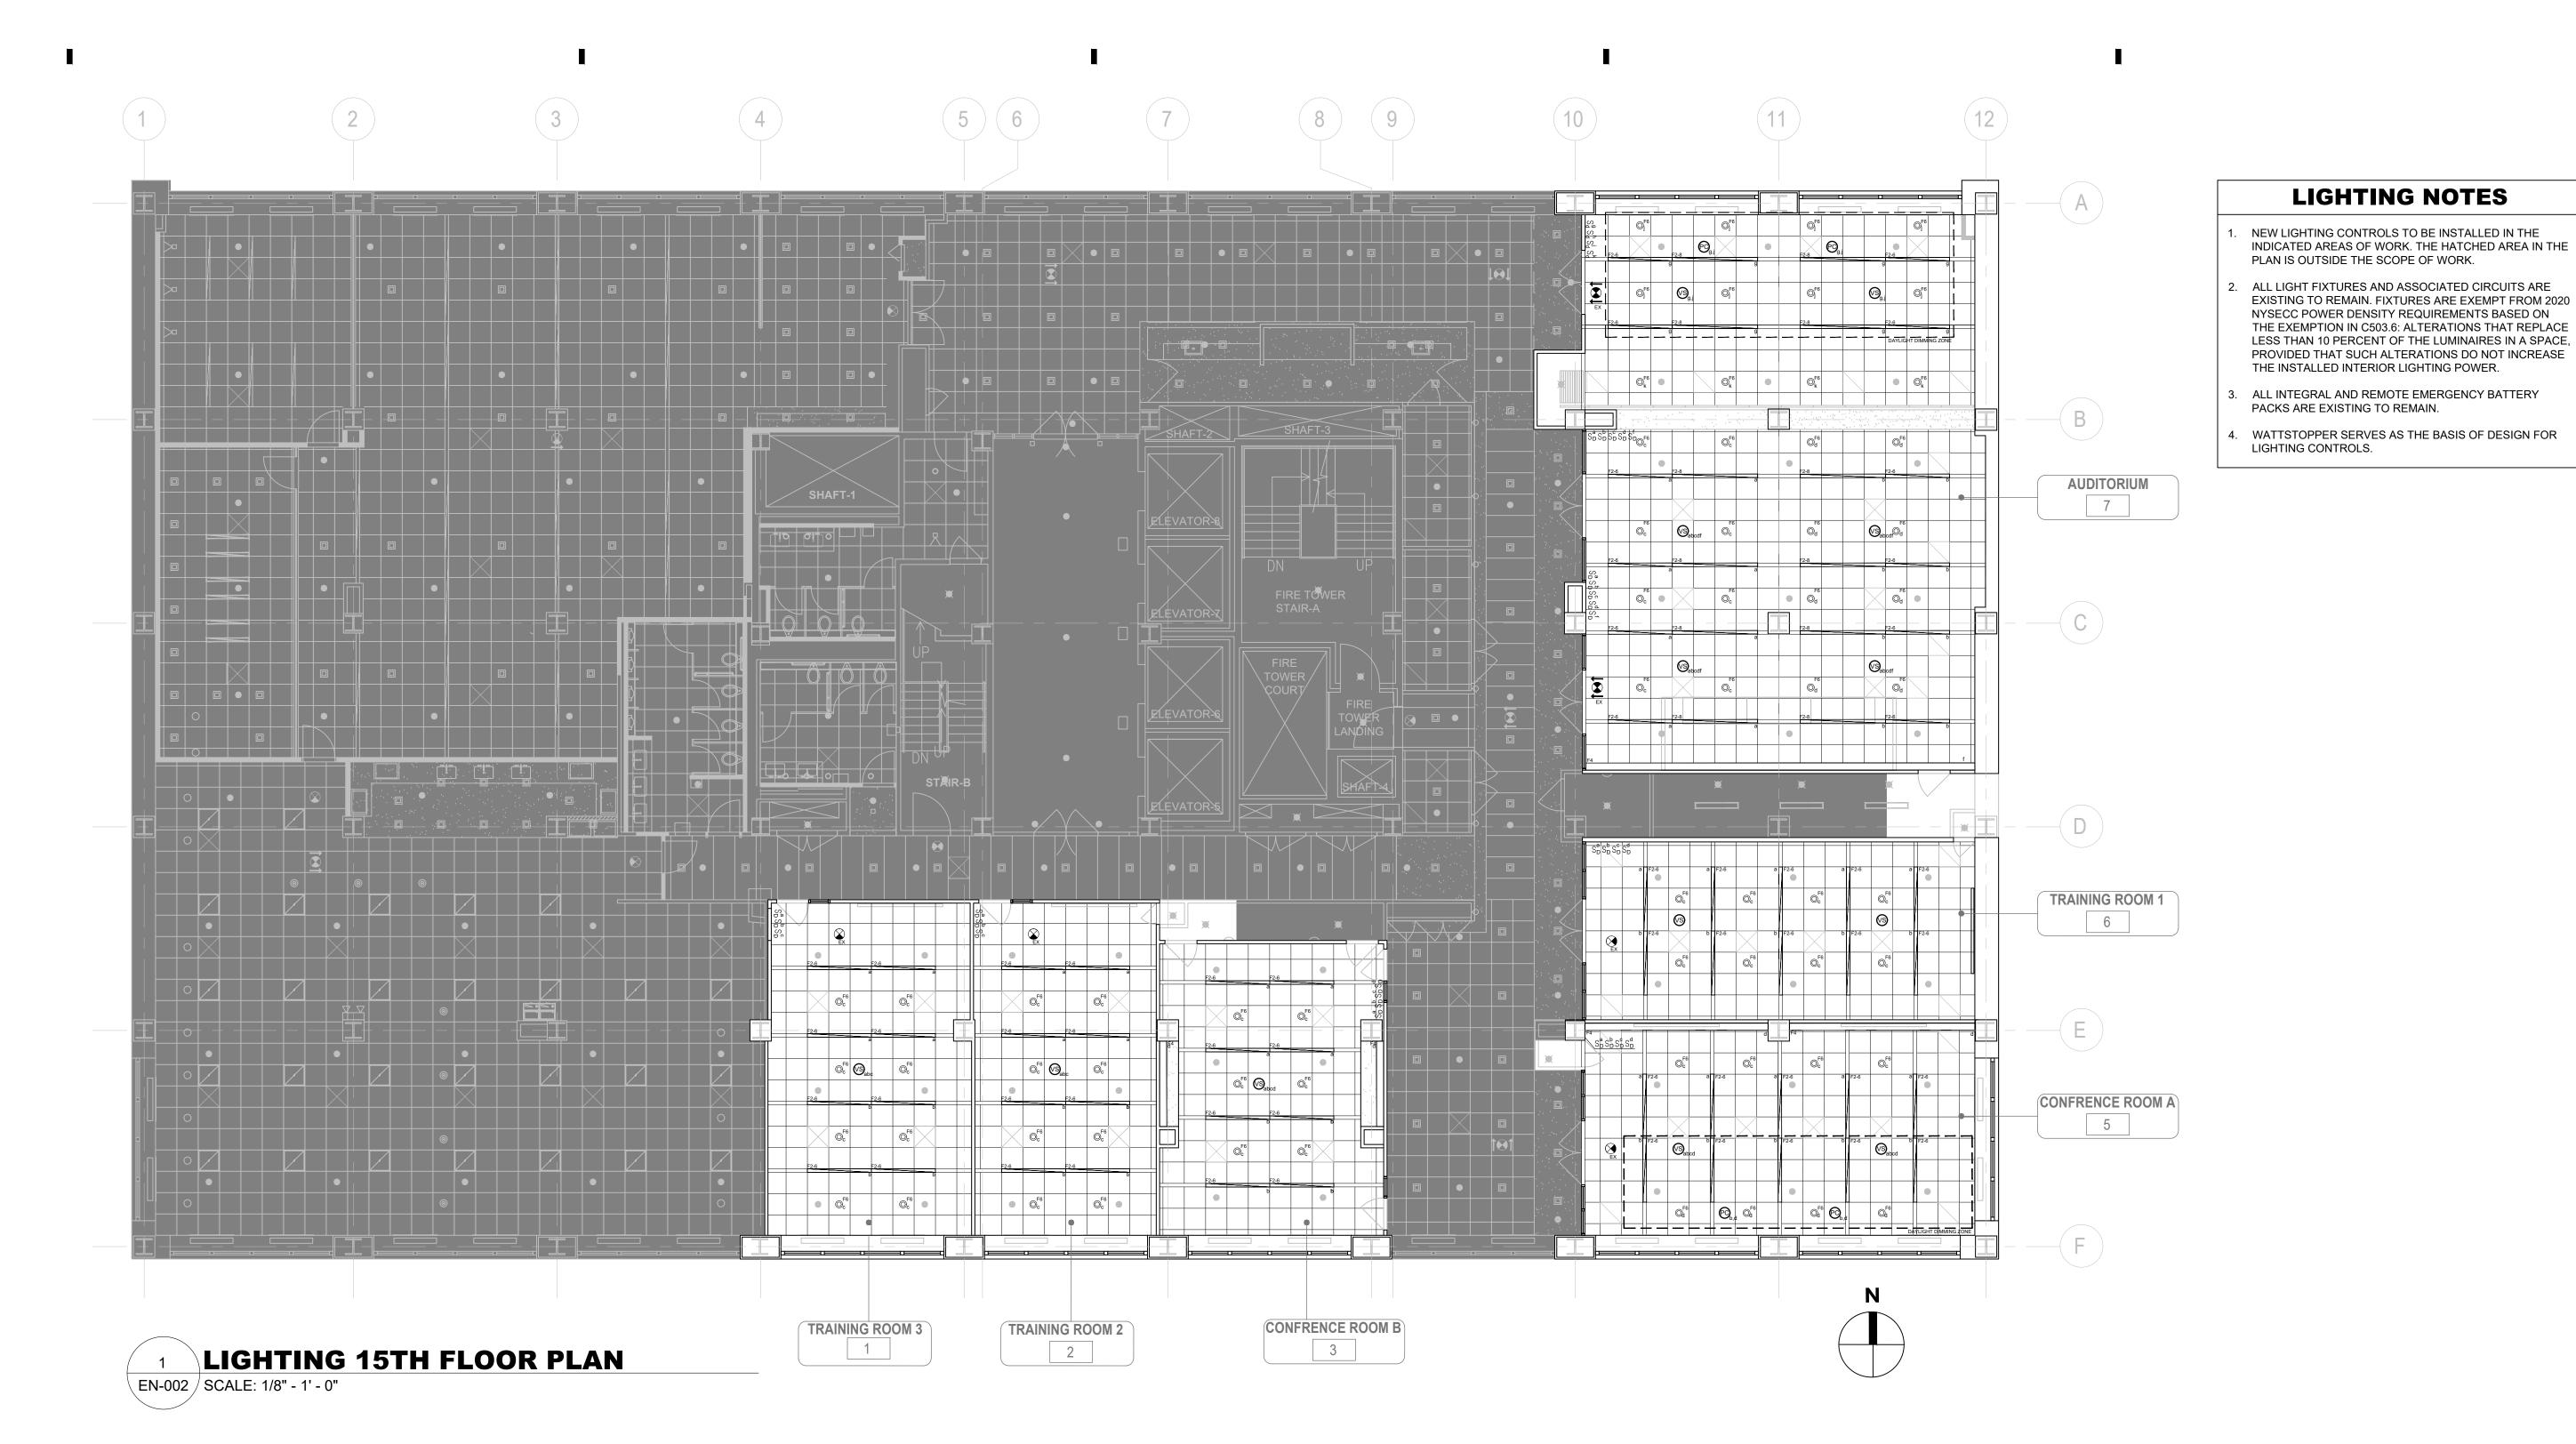



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NYSIF-AV 15th Floor Upgrades




■ NEW YORK CITY

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28TH FLOOR
NEW YORK, NY 10004
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212-563-1841 [F]

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OGS PROJECT NO. SF76


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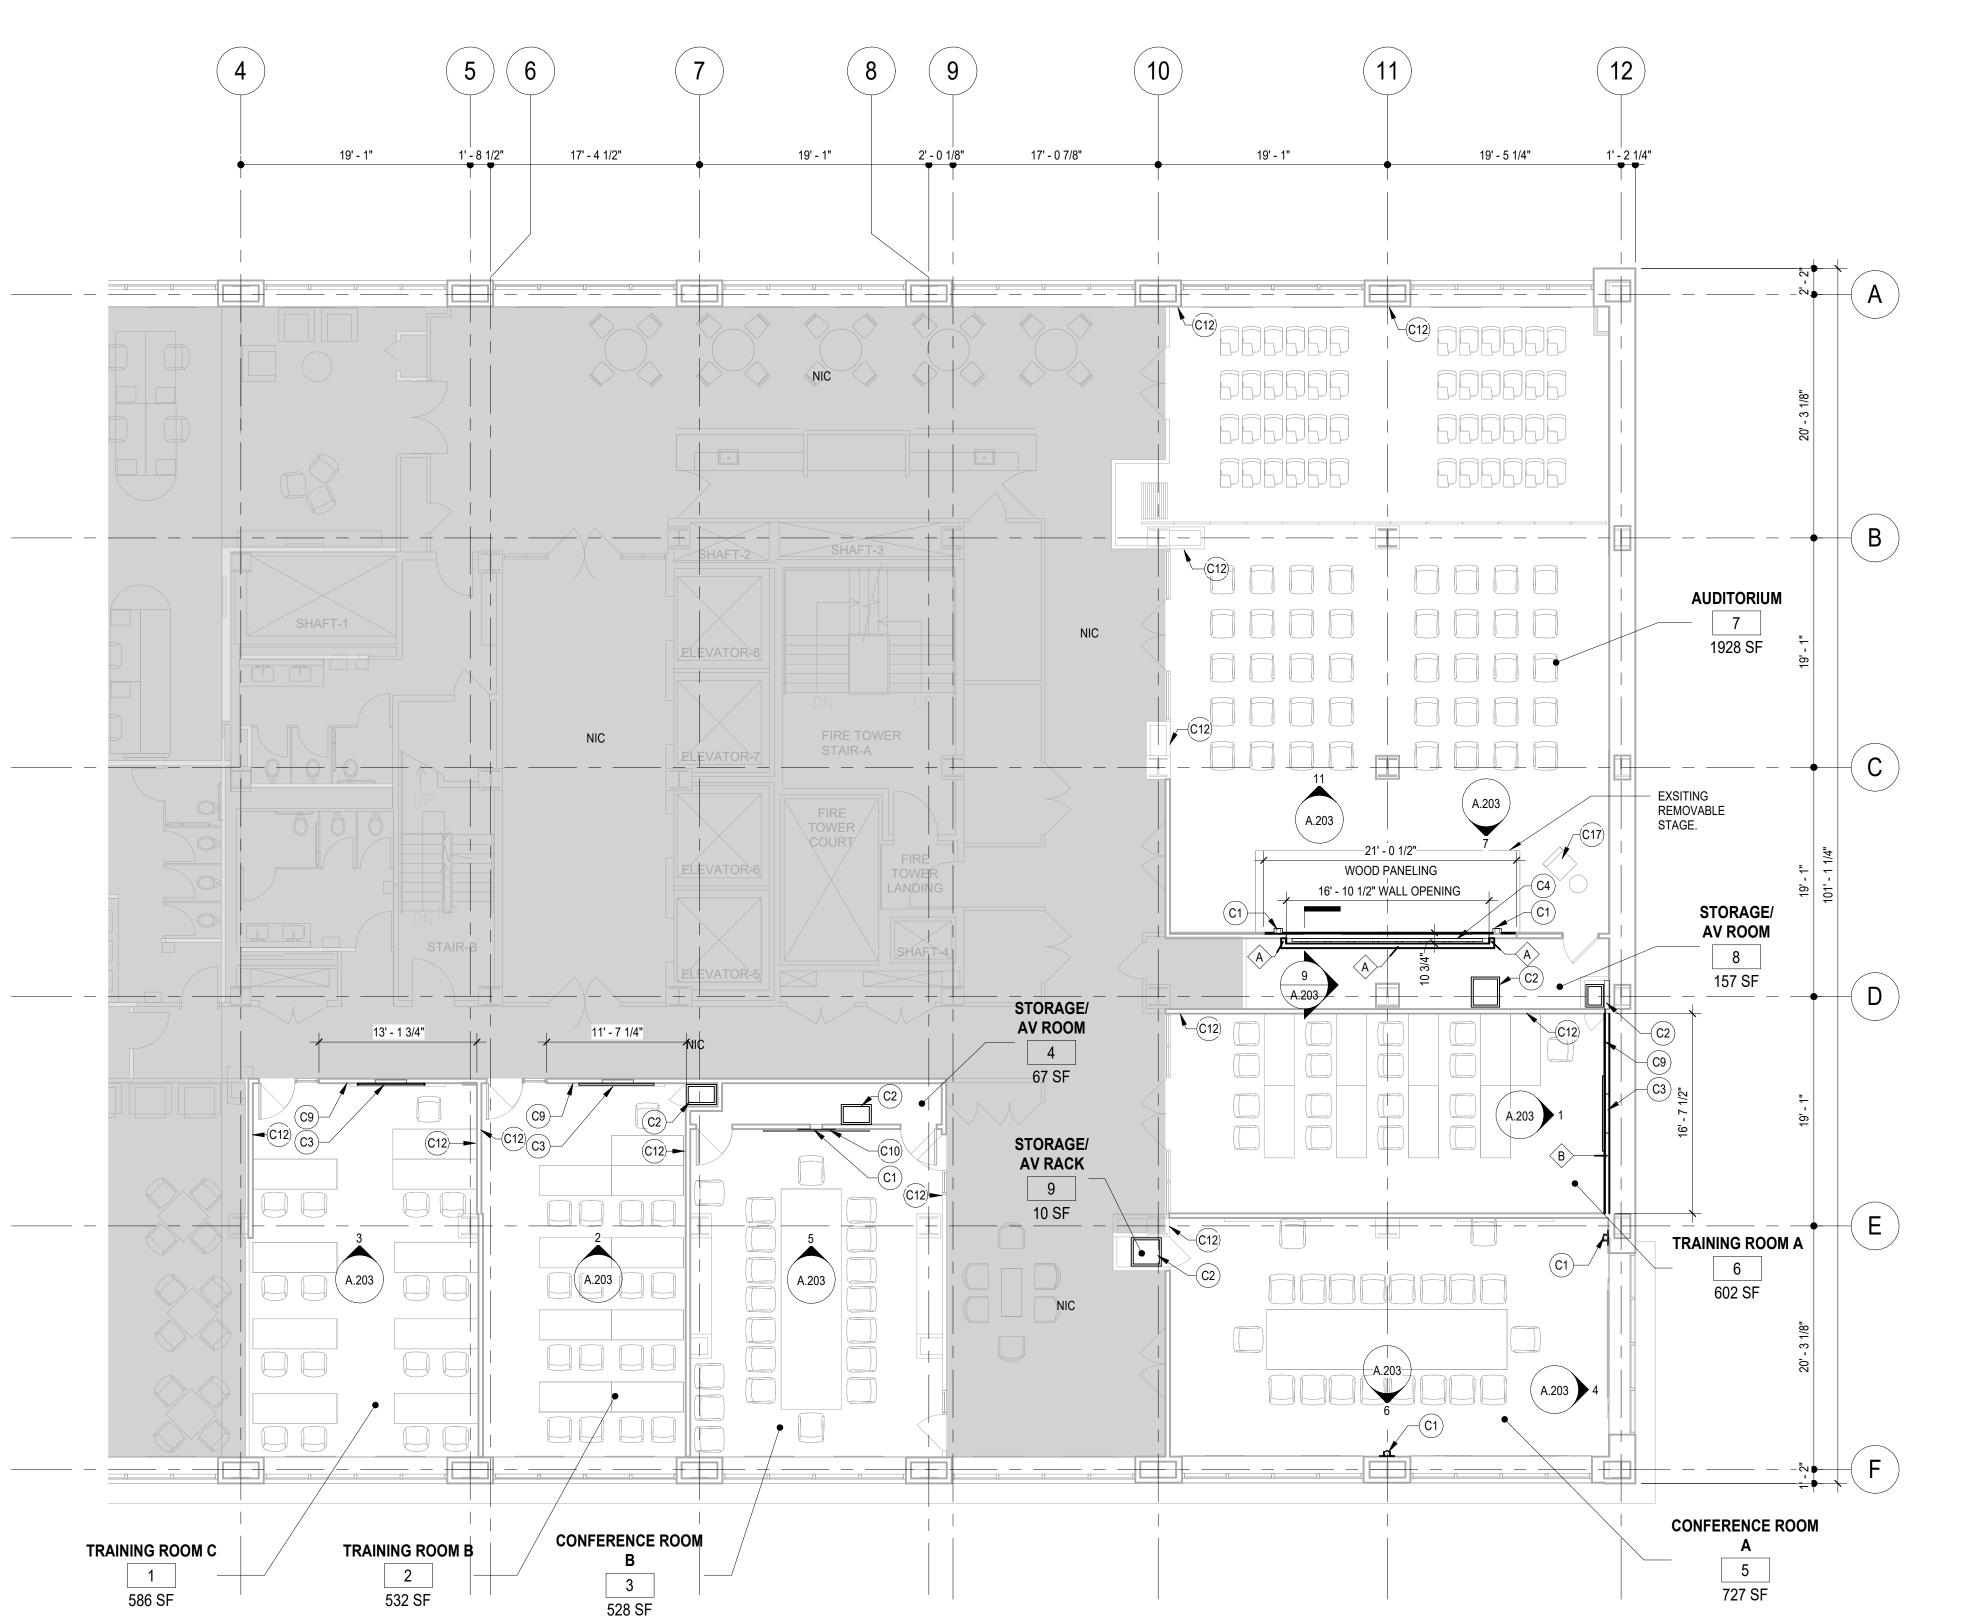
ISSUE DATE:	
12/11/24	
PROJECT NO.:	SCALE:
21-048-1165.02	1/8" = 1'-0"
DRAWING NO.:	

EN-002.00

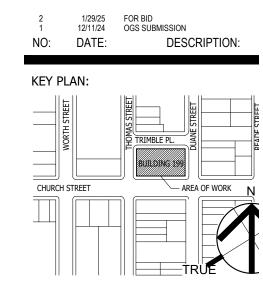PROJECT LOCATION:
Autodesk Docs://NYSIF A/21-048-1165.02_ARC_NYSIF_LH.rvt


			LIGHTING	FIXTU	JRE SCHED	ULE		
SYMBOL	TYPE	MOUNTING	DESCRIPTION	LAMPS	MFR.	FIXT. WATT	DRIVER	REMARKS
	F2-6	RECESSED	6' NEO-RAY DEFINE 4 SERIES RECESSED DIRECT LED LIGHTING FIXTURE TROFFER AS PER ARCHITECT'S SPECIFICATIONS	LED 64.5W	EATON COOPER LIGHTING	64.5W	120V LED DRIVER (0-10V CONTROL)	REFER TO ARCHITECTURAL SPECIFICATIONS FOR DETAILED LUMINAIRE SPECIFICATIONS AND CATALOG NUMBERS.
	F2-8	RECESSED	8' NEO-RAY DEFINE 4 SERIES RECESSED DIRECT LED LIGHTING FIXTURE TROFFER AS PER ARCHITECT'S SPECIFICATIONS	LED 86.0	EATON COOPER LIGHTING	86.0W	120V LED DRIVER (0-10V CONTROL)	REFER TO ARCHITECTURAL SPECIFICATIONS FOR DETAILED LUMINAIRE SPECIFICATIONS AND CATALOG NUMBERS.
•	F6	RECESSED	6" PORTFOLIO LD6A20 SERIES RECESSED ROUND LED DOWNLIGHT WITH CYLINDRICAL GLASS AS PER ARCHITECT'S SPECIFICATIONS	LED 31.5	EATON COOPER LIGHTING	31.5W	120V LED DRIVER (0-10V CONTROL)	REFER TO ARCHITECTURAL SPECIFICATIONS FOR DETAILED LUMINAIRE SPECIFICATIONS AND CATALOG NUMBERS.
	F4	RECESSED	NEO-RAY 79-PF LED PENTAFLEX SERIES RECESSED PERIMETER LED WALLWASHER AS PER ARCHITECT'S SPECIFICATIONS (2,330 LUMENS PER 4-FOOT SECTION)	LED 29W PER 4' SECTION	EATON COOPER LIGHTING	29W PER 4' SECTION	120V LED DRIVER (0-10V CONTROL)	REFER TO ARCHITECTURAL SPECIFICATIONS FOR DETAILED LUMINAIRE SPECIFICATIONS AND CATALOG NUMBERS.
\mathbf{z}	EX	AS REQUIRED	EDGE-LIT EXIT SIGN WITH 8" HIGH RED LETTERS AND NI-CAD BATTERY AS PER ARCHITECT'S SPECIFICATIONS. NUMBER OF FACES AND DIRECTIONAL ARROWS AS SHOWN ON ARCHITECT'S DRAWINGS.	LED 3W	LITHONIA LIGHTING	3W	120V LED DRIVER	REFER TO ARCHITECTURAL SPECIFICATIONS FOR DETAILED LUMINAIRE SPECIFICATIONS AND CATALOG NUMBERS.




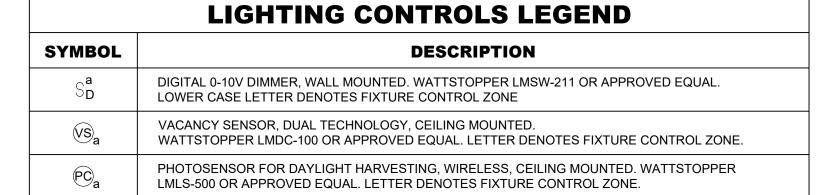


KEYNOTES INSTALL WALL MOUNTED CAMERA, REFER TO AV DRAWINGS. C2 INSTALL AV EQUIPMENT RACK, REFER TO AV DRAWINGS. C3 INSTALL WALL STRUCTURE AND FLUSH IN-WALL MOUNTING SYSTEM, REFER TO AV DRAWINGS. REINSTALL GYPSUM SUBSTRATE, AT EXPOSED WALL PRIOR TO INSTALLATION OF DISPLAYS AND ACOUSTIC WALL COVERING. INSTALL VIDEO WALL SCREENS AND ACCESSORIES THROUGH PAINTED GYPSUM WALL BOARD TO PLYWOOD SUBSTRATE, REFER TO AV DRAWINGS. INSTALL PROPOSED ACOUSTIC WALL COVERING FROM FLOOR TO CEILING PRIOR TO INSTALLATION OF DISPLAYS. REFER TO FINISH SCHEDULE. TYP. C10 RE-INSTALL VIDEO SCREENS PER AV DRAWINGS. C12 PATCH AND PAINT WALL OPENING TO MATCH EXISTING ADJACENT PAINT PRIOR TO INSTALLING AV WALL PLATE, REFER TO AV DRAWINGS. MODIFY EXISTING WOOD PODIUM TO HOUSE AV EQUIPMENT AND ACCESSORIES,

REFER TO AV DRAWINGS.

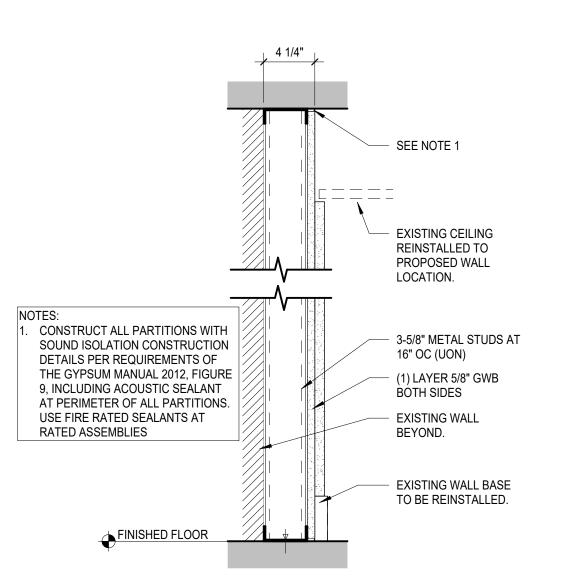

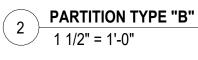

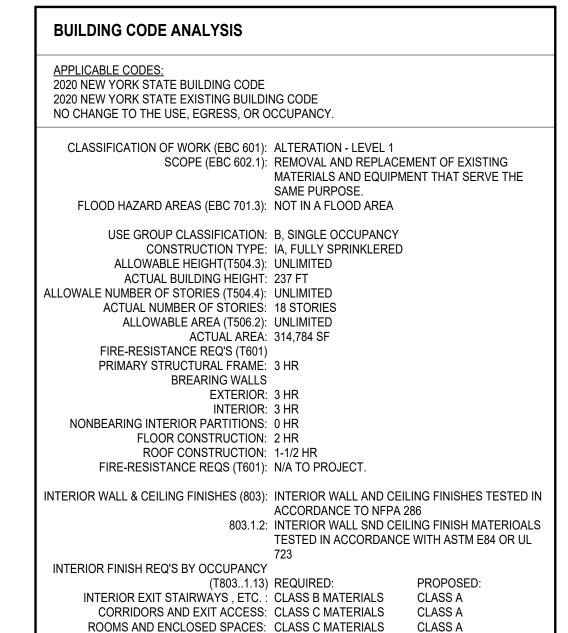



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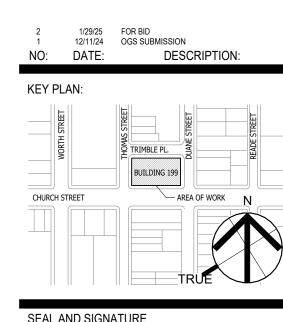
NYSIF-AV 15th Floor Upgrades





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CONSULTANT:



SEAL AND SIGNATURE



OGS PROJECT NO. SF760

DRAWING TITLE: PROPOSED FLOOR PLAN


ISSUE DATE:	
12/11/24	
PROJECT NO.:	SCALE:
21-048-1165.02	As indicated
DRAWING NO.:	

A.101

Autodesk Docs://NYSIF A/21-048-1165.02_ARC_NYSIF_LH.rvt

Level 15 - Proposed Plan

1/8" = 1'-0"

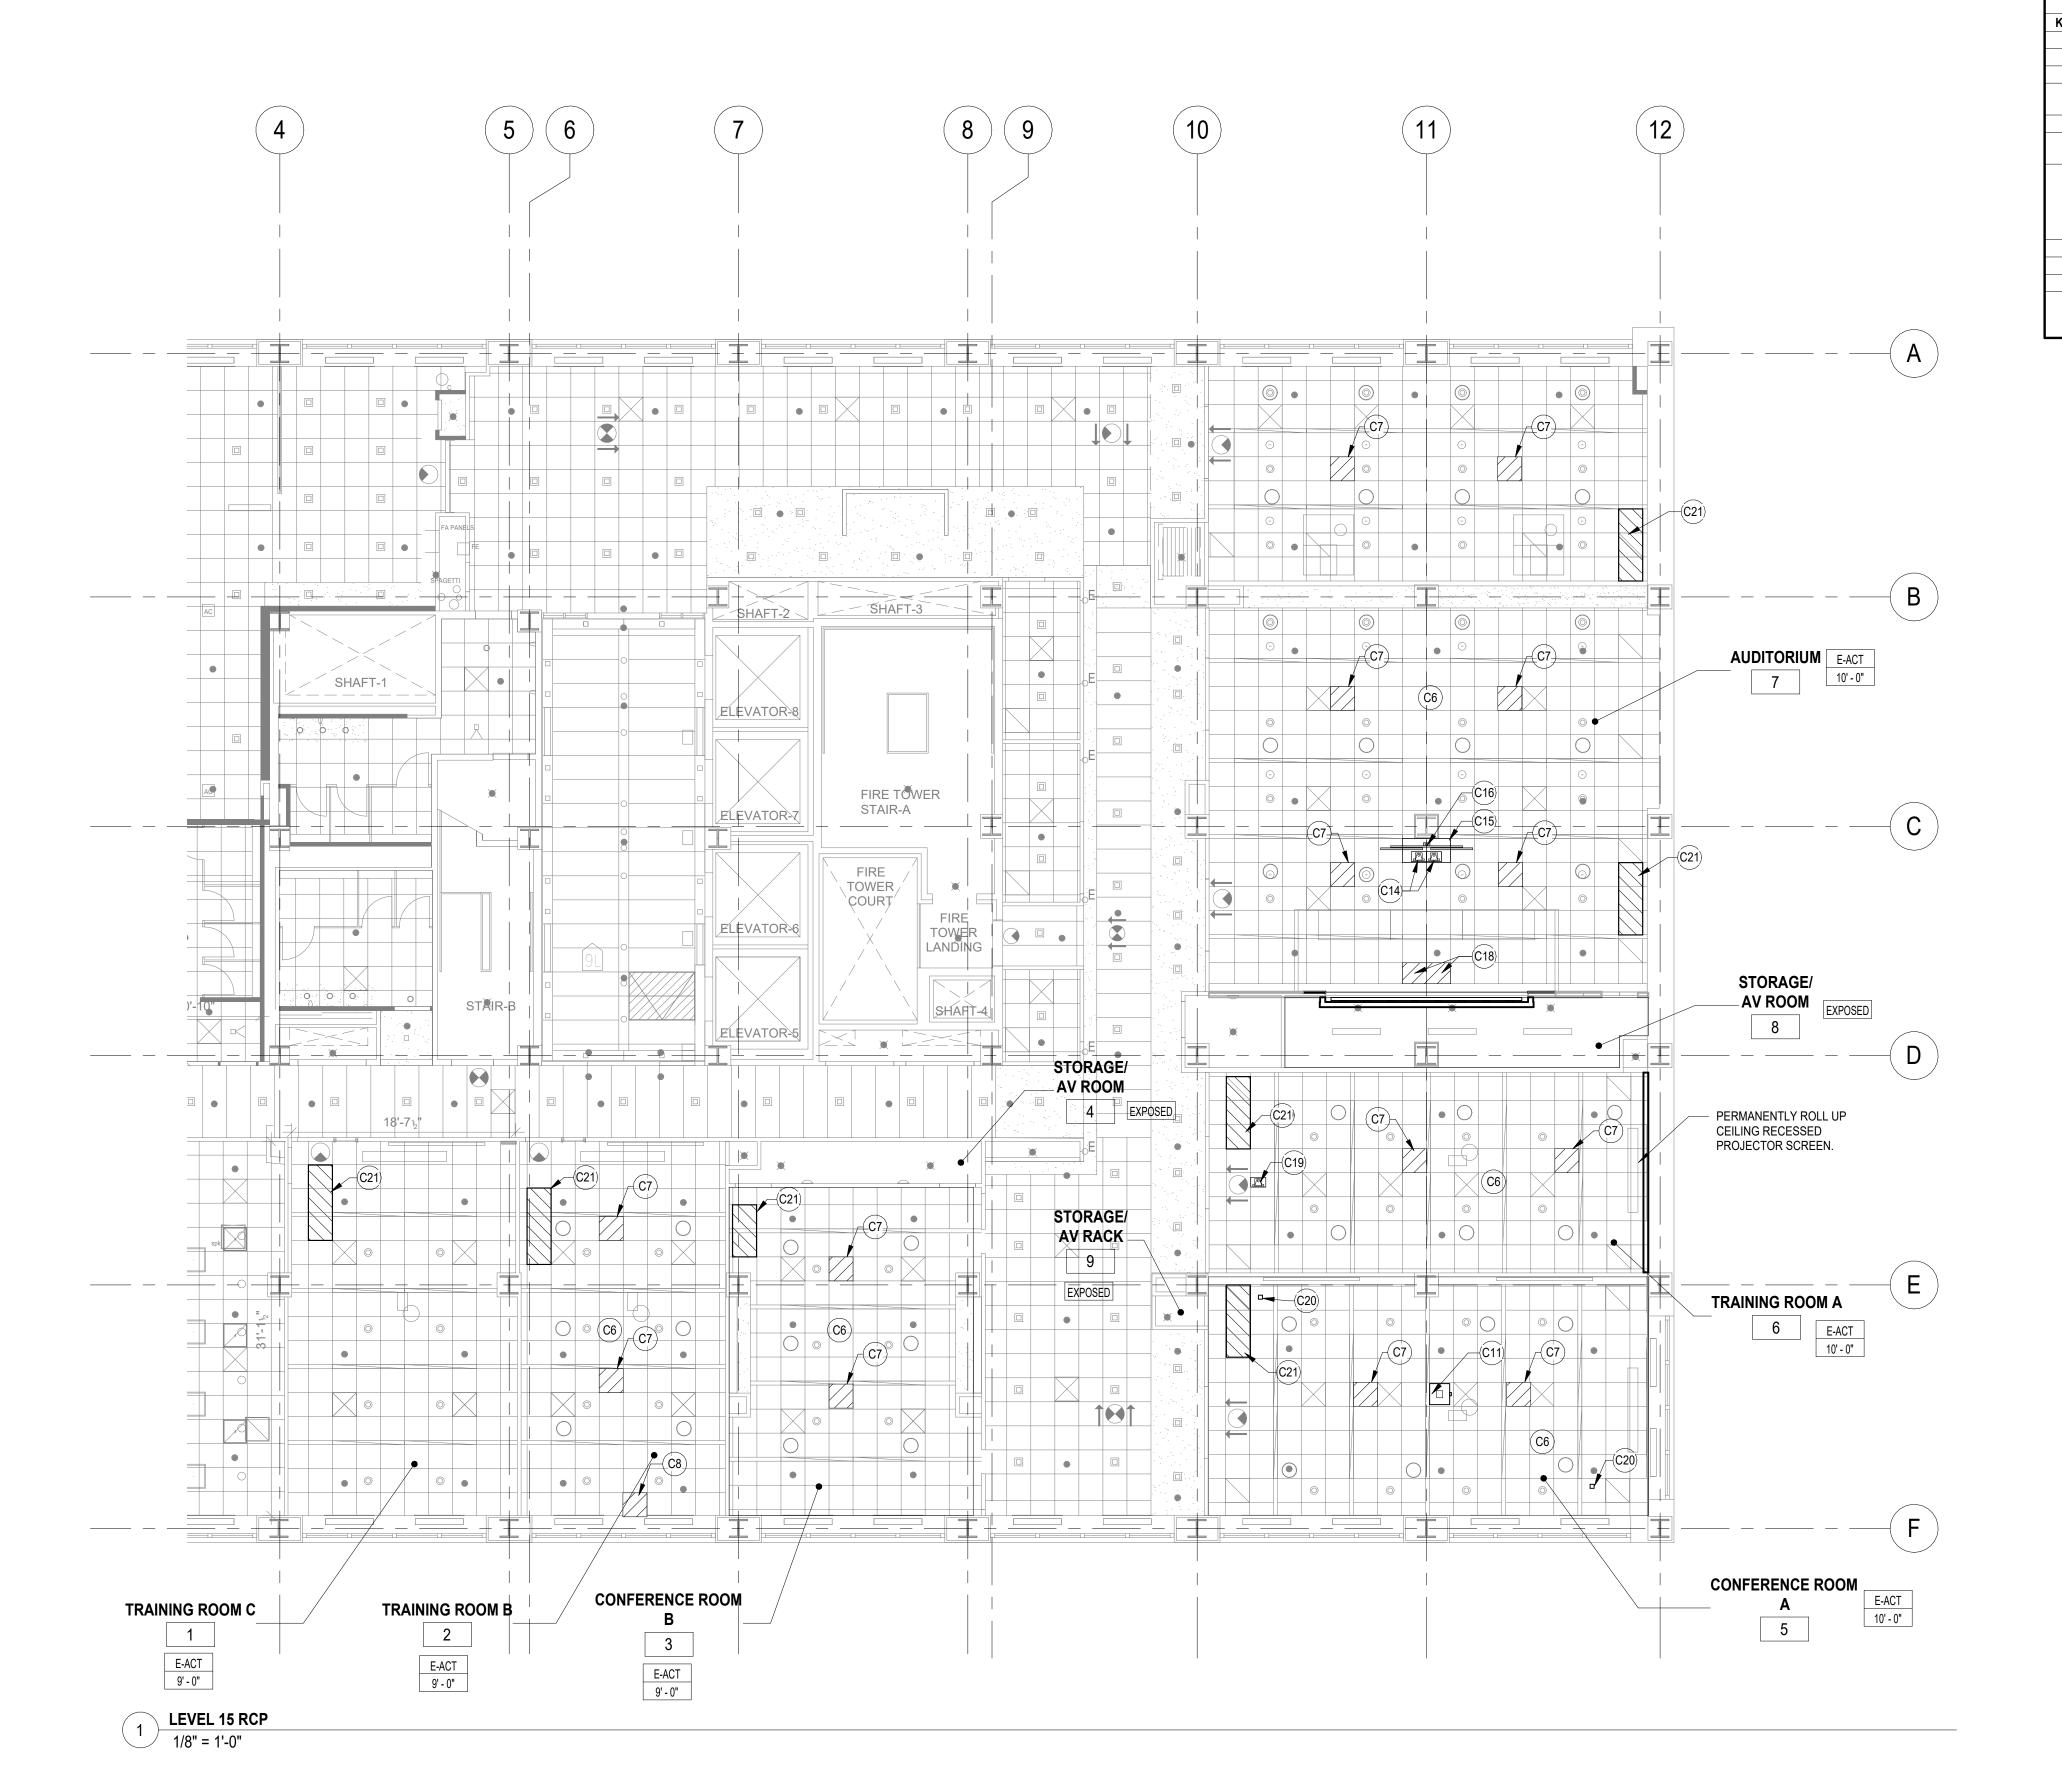

KEYNOTE

NOTE

C6 EXISTING CEILING SPEAKERS REMAIN, REFER TO AV DRAWINGS.

C7 INSTALL NEW CEILING MOUNTED MICROPHONE ARRAY, REFER TO AV DRAWINGS

C8 INSTALL NEW CEILING MOUNTED CAMERA, REFER TO AV DRAWINGS

C11 INSTALL CEILING PROJECTOR TO EXISTING PROJECTOR MOUNT, REFER TO AV DRAWINGS.

C14 INSTALL CEILING MOUNTED CAMERA(S). REFER TO AV DRAWINGS.

C15 INSTALL COMPATIBLE 2X4 CEILING PANEL COMPATIBLE WITH TV AND CAMERA INSTALLATION. REFER TO AV DRAWINGS.

C16 INSTALL MONITOR BRACKET TO EXISTING STEEL BEAM. PATCH BEAM FIRE-RESISTANCE RATED CONSTRUCTION AND ENCLOSURE SIMILAR TO EXISTING ADJACENT COVER INSTALLATION FOR 3 HOUR RATED PROTECTION, REFER TO DETAILS. FOR MONITOR(S) AND ACCESSORIES REFER TO ELECTRICAL AND AV DRAWINGS.

C18 INSTALL COMPATIBLE 2X2 CEILING PANEL(S) WITH EXISTING CEILING SYSTEM.

C19 INSTALL CEILING MOUNTED CAMERA, REFER TO AV DRAWINGS.

INSTALL CEILING MOUNTED ANTENNA, REFER TO AV DRAWINGS.

BROKEN OR DAMAGED TILES IN-KIND.

REINSTALL CEILING TILES AFTER ELECTRICAL WORK IS COMPLETE. REFER TO ELECTRICAL DRAWINGS. GENERAL CONTRACTOR IS RESPONSIBLE FOR REPLACING



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199 Church Street, New York, 10007

NYSIF-AV 15th Floor Upgrades




NEW YORK CITY

ONE STATE STREET PLAZ
28TH FLOOR
NEW YORK, NY 10004
212-582-0290 (Pl

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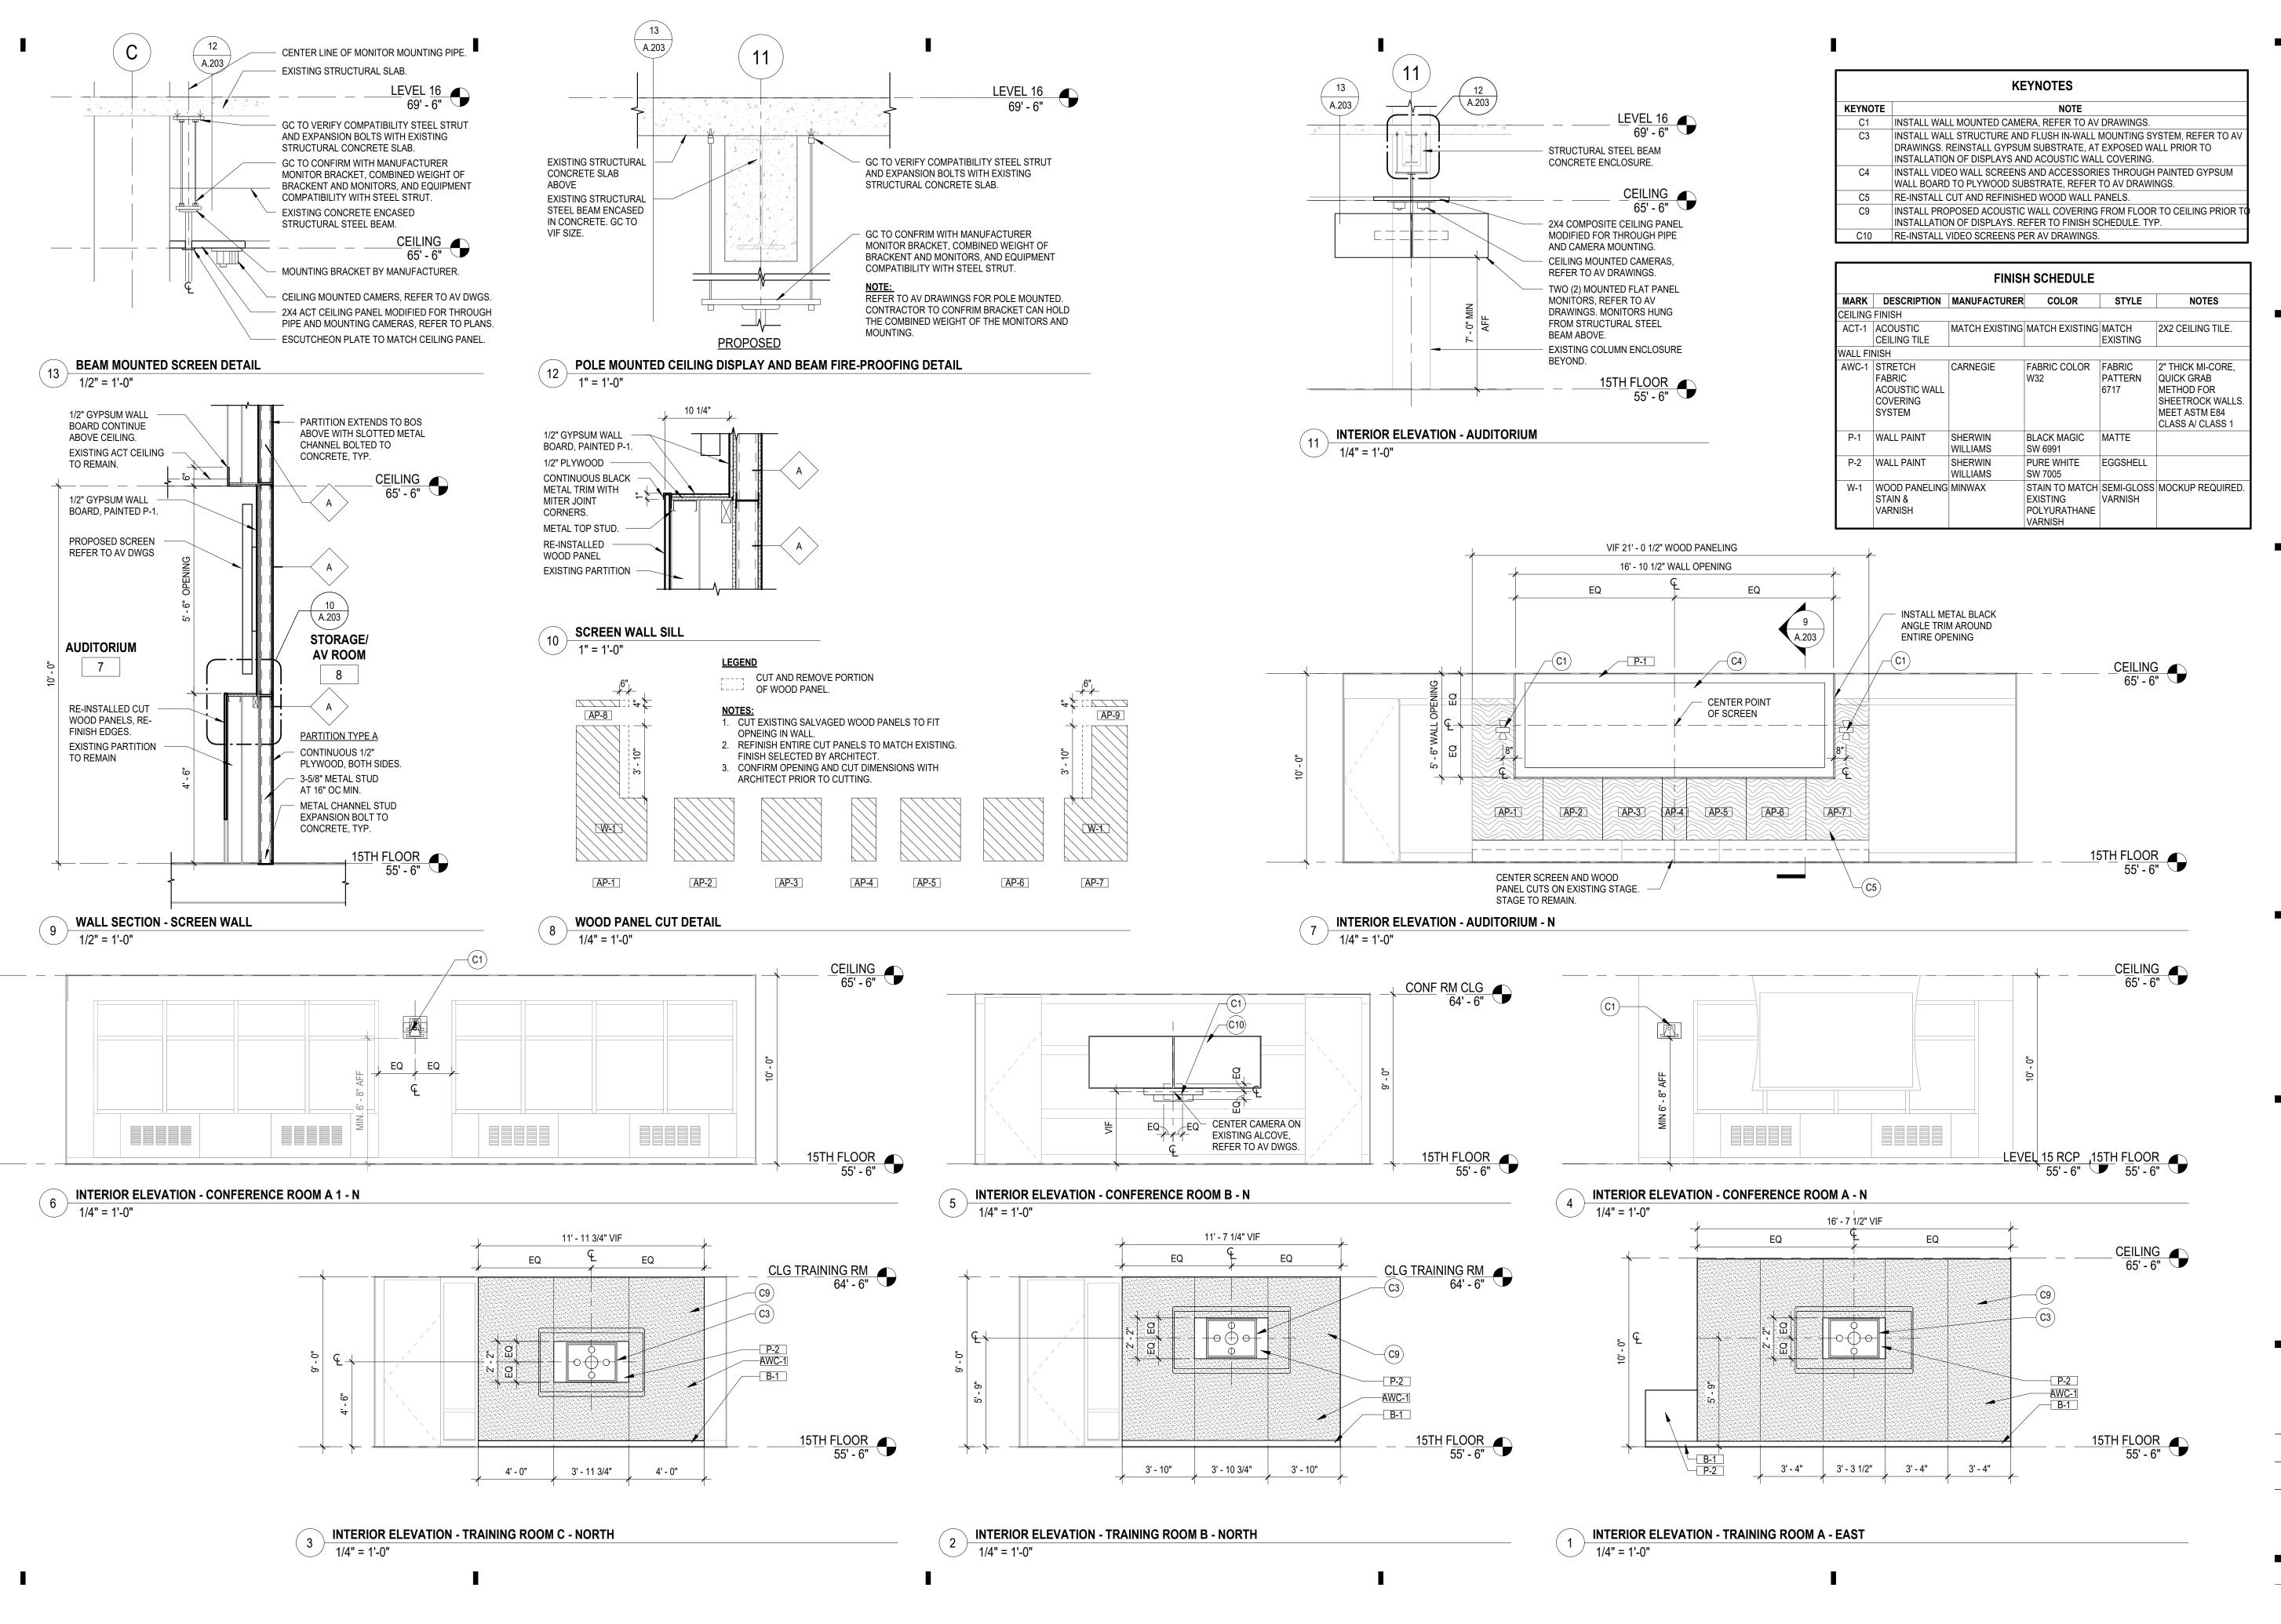
OGS PROJECT NO. SF760

DRAWING TITLE: PROPOSED RCP

ISSUE DATE:	
12/11/24	
PROJECT NO.:	SCALE:
21-048-1165.02	1/8" = 1'-0"
DRAWING NO :	•

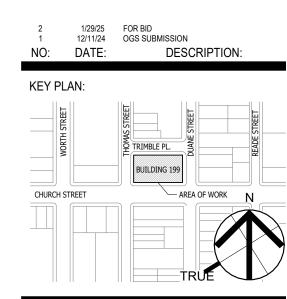A.103

OJECT LOCATION: todesk Docs://NYSIF A/21-048-1185.02_ARC_NYSIF_LH.rvt





NEW YORK STATE INSURANCE FUND

199 Church Street, New York, 10007

NYSIF-AV 15th Floor Upgrades



ARCHITECTURE

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12/11/24 OGS SUBMISSION DATE: DESCRIPTION: KEY PLAN: CHURCH STREET

SEAL AND SIGNATURE



OGS PROJECT NO. SF760

DRAWING TITLE:

PROPOSED ELEVATIONS, SECTIONS, AND

ISSUE DATE: 12/11/24 PROJECT NO.: 21-048-1165.02 As indicated

DRAWING NO.: A.203

ELECTRICAL DEMOLITION NOTES

- 1. REFER TO ARCHITECTURAL DEMOLITION DRAWINGS AND NOTES FOR ADDITIONAL INFORMATION.
- 2. IN AREAS DESIGNATED FOR DEMOLITION BY THE ARCHITECTURAL DRAWINGS, IT IS THE INTENT OF THIS CONTRACT THAT THE CONTRACTOR SHALL DISCONNECT AND REMOVE ALL EXISTING ELECTRICAL, TELECOMMUNICATION, SECURITY AND AUDIO/VISUAL EQUIPMENT INCLUDING: POWER AND LIGHTING PANELBOARDS (IF ANY) AND ASSOCIATED FEEDERS, TRANSFORMERS, PULLBOXES, FIXTURES, FLOOR RECEPTACLES, POWER AND TEL./DATA DOGHOUSE OUTLETS, WALL MOUNTED OUTLETS, CONTROL DEVICES AND LIGHT SWITCHES, POWER OUTLETS, BOXES, WIRING, RACEWAYS, CONDUITS AND CABLE TRAYS. AND ALL OTHER EQUIPMENT UNLESS OTHERWISE NOTED. WHICH IS MOUNTED ON WALLS OR PARTITIONS THAT WILL BE TAKEN OUT. REMOVE BRANCH CIRCUITRY BACK TO NEAREST DEVICE SCHEDULED TO REMAIN AND SAFELY TERMINATE ALL CONNECTIONS -- MAINTAIN CONTINUITY OF ALL EXISTING FEEDERS AND BRANCH CIRCUITRY TO EXISTING AREAS NOT BEING AFFECTED BY THIS DEMOLITION -- ALL WORK TO BE DONE IN AN APPROVED MANNER.
- PROVIDE TEMPORARY LIGHTING AND POWER FOR ALL TRADES DURING DEMOLITION AND LIGHTING, THE CONTRACTOR SHALL CLEARLY LABEL PANELS AND BREAKERS USED FOR LIGHTING. LOCATION OF PANELS TO BE SHOWN ON FLOOR PLAN POSTED AT ENTRANCE TO WORK AREA. PROPER TEMPORARY LIGHTING AND POWER MUST BE MAINTAINED IN ALL WORK AREAS. TEMPORARY LIGHT AND POWER STRINGERS SHALL UTILIZE C-TAP TERMINATIONS. LAMPHOLDERS SHALL HAVE LEFT HANDED SCREW SHELL LAMP HOLDERS AND NON-METALLIC LAMP GUARDS. CONNECTIONS TO EXISTING STAIRWELL AND EXIT SYSTEMS ARE NOT PERMITTED.
- DEMOLITION PLANS ARE INTENDED TO INDICATE MINIMUM DEMOLITION WORK. CONTRACTOR SHALL VERIFY IN FIELD THE FULL EXTENT OF THE WORK. CONTRACTOR SHALL INFORM ARCHITECT AND ELECTRICAL ENGINEER OF ANY DISCREPANCIES.
- 5. ELECTRIC PANEL COVERS ARE NOT TO BE LEFT OFF AT ANY TIME. UNLESS MEN ARE WORKING ON SAME. COVERS SHALL BE REPLACED EACH NIGHT BEFORE LEAVING JOB SITE.
- 6. BRANCH CIRCUITRY AND CONTROL WIRING FOR MECHANICAL EQUIPMENT AND DEVICES TO BE REMOVED SHALL BE DISCONNECTED AND REMOVED -- COORDINATE THESE REMOVALS WITH MECHANICAL CONTRACTOR. RELOCATE ANY CONTROL DEVICES TO TEMPORARY LOCATIONS IF REQUIRED. FOR EXISTING A/C UNITS TO BE REMOVED, DISCONNECT AND REMOVE STARTERS, DISCONNECT SWITCHES, JUNCTION BOXES, POWER AND CONTROL WIRING BACK TO SOURCE. CONTINUITY SHALL BE MAINTAINED ON ALL ELECTRICAL CIRCUITS FEEDING POWER TO A/C UNITS OR MECHANICAL EQUIPMENT NOT BEING REMOVED.
- 7. TRACE OUT ALL EXISTING CIRCUITS TO DETERMINE IF ANY CIRCUITS ALSO FEED THE FLOORS BELOW OR THE FLOORS ABOVE. IF SO, CONTACT THE BUILDING MANAGER AND ELECTRICAL ENGINEER TO DETERMINE COURSE OF ACTION TO BE TAKEN.
- ALL OTHER DEVICES THAT ARE REMOVED AND MADE SURPLUS SHALL BE REMOVED FROM THE SITE. CONTRACTOR MUST OBTAIN OWNER'S APPROVAL FOR DISPOSITION. ELECTRICAL CONTRACTOR IS RESPONSIBLE FOR PROPER DISPOSAL OF ALL ELECTRICAL EQUIPMENT NOT DEEMED SALVAGEABLE BY OWNER.
- 9. ELECTRICAL CONTRACTOR SHALL VISIT AND EXAMINE CAREFULLY THE EXISTING AREAS AFFECTED BY THIS WORK TO BECOME FAMILIAR WITH EXISTING CONDITIONS AND WITH DIFFICULTIES THAT WILL AFFECT THE EXECUTION OF THE WORK. CONTRACTOR SHALL PERFORM THIS, PRIOR TO SUBMITTING HIS PROPOSAL. SUBMISSION OF A PROPOSAL WILL BE CONSTRUED AS EVIDENCE THAT SUCH AN BEEN MADE AND LATER CLAIMS WILL NOT BE RECOGNIZED FOR EXTRA LABOR, EQUIPMENT OR MATERIALS REQUIRED BECAUSE OF DIFFICULTIES ENCOUNTERED, WHICH COULD HAVE BEEN FORESEEN HAD SUCH AN EXAMINATION BEEN MADE.
- 10. THE ELECTRICAL CONTRACTOR SHALL DETERMINE THE EXTENT OF PCB CONTAMINATED BALLASTS (IF ANY) AND SHALL PROPERLY DISPOSE OF BALLASTS. CONTRACTOR TO DOCUMENT IN WRITING THAT ALL PROPER PROCEDURES AND APPLICABLE ENVIRONMENTAL LAWS WERE ADHERED TO.
- 11. THE CONTRACTOR SHALL MAINTAIN CONTINUITY OF SERVICE ON ALL CIRCUITS AFFECTED BY THIS DEMOLITION. WHENEVER IT IS REQUIRED THAT AN EXISTING CIRCUIT BE REVISED, DISCONNECTED OR REMOVED, IT SHALL BE UNDERSTOOD THAT THE CIRCUIT SHALL BE RECONNECTED AND SERVICE RE-ESTABLISHED IN THE REMAINING PORTION OF THE CIRCUIT AFFECTED BY THIS ALTERATION.
- 12. THE CONTRACTOR SHALL CUT BACK TO THE FLOOR, WALL OR CEILING, REMOVE WIRING AND PLUG BOTH ENDS OF CONCEALED MADE OBSOLETE BY THIS ALTERATION, EXPOSED CONDUITS, CABLE TRAYS, WIREWAYS, OUTLET BOXES, PULL BOXES, HANGERS, ETC. MADE OBSOLETE BY THE ALTERATION WORK SHALL BE REMOVED, UNLESS OTHERWISE NOTED.
- 13. DURING DEMOLITION, PROVIDE ALL NECESSARY PROTECTION FOR EXISTING ELECTRICAL WORK REQUIRED FOR REUSE.
- 14. ALL POWER WIRING IN AREAS TO BE DEMOLISHED SHALL BE THOROUGHLY TRACED OUT TO DETERMINE THE DEVICES BEING FED FROM IT. ALL OBSOLETE WIRING AND CONDUIT SHALL BE REMOVED BACK TO THEIR RESPECTIVE PANELS UPON COMPLETION OF DEMOLITION, AN ACCURATE COUNT OF ALL SPARE CIRCUITS IN ALL PANELS SHALL BE MADE BY THE CONTRACTOR AND FURNISHED TO THE ARCHITECT AND ELECTRICAL ENGINEER. INFORMATION SHALL INCLUDE PANEL NAME, PANEL LOCATION, NUMBER OF SPARE CIRCUIT BREAKERS OF EACH SIZE AND TYPE. NUMBER OF EMPTY SPACES FOR FUTURE BREAKERS IN EACH PANEL.
- 15. ALL EXISTING ELECTRICAL EQUIPMENT WITHIN THE ELECTRICAL CLOSETS SHALL BE SPECIFIED UNDER THE CONSTRUCTION PHASE OF THE PROJECT.
- 16. ALL DEMOLITION WORK, WHICH CREATES DISTURBING NOISE, SHALL BE PERFORMED AS PER OWNER'S INSTRUCTIONS. THE REMOVAL OF DEBRIS AND EQUIPMENT MUST BE ARRANGED TO AVOID ANY INCONVENIENCE TO OWNER.

ELECTRICAL GENERAL NOTES

- 1. ALL ELECTRICAL WORK SHALL BE FURNISHED AND INSTALLED IN ACCORDANCE WITH THE 2020 NYS BUILDING CODE, 2017 NATIONAL ELECTRICAL CODE, AND ALL LOCAL AND MUNICIPAL CODES HAVING
- ELECTRICAL CONTRACTOR (E.C.) SHALL VISIT SITE TO SURVEY EXISTING CONDITIONS AND INCLUDE ALL NECESSARY COSTS TO COMPLETE THE INSTALLATION.
- 3. E.C. TO FURNISH AND PAY FOR ALL PERMITS AS REQUIRED AND OBTAIN FINAL CERTIFICATE OF
- 4. CATALOG NUMBERS ARE MEANT TO INDICATE TYPE DESIRED AND MAY BE SUBSTITUTED WITH AN APPROVED EQUAL DEVICE. "APPROVED EQUAL" MUST BE SUBMITTED TO THE ENGINEER FOR WRITTEN APPROVAL PRIOR TO INSTALLATION IN THE FIELD.
- WORK MUST BE COORDINATED WITH ALL OTHER TRADES TO ELIMINATE CONFLICTS AND INTERFERENCES.
- 6. E.C. SHALL BALANCE LOADS ON PARALLEL FEEDER AND ALL PANELS.
- 7. E.C. MUST PROVIDE PROPER "FIRE STOPPING" AT ALL PENETRATIONS THROUGH FIRE RATED ASSEMBLIES. SUBMIT EXACT MATERIALS AND METHODS TO THE ENGINEER FOR REVIEW AND APPROVAL PRIOR TO INSTALLATION, NO EXCEPTIONS TAKEN.
- CONTROL WIRING FOR HVAC UNITS (OTHER THAN LOW VOLTAGE POWER SUPPLY WIRING) SHALL BE DONE BY HVAC CONTRACTOR.
- 9. ALL FUSES SHALL BE CURRENT LIMITING CLASS RK1.
- 10. CONDUIT AND WIRE ON POWER AND LIGHTING PLANS IS NOT SHOWN EXCEPT FOR HOMERUNS. CONTRACTOR SHALL PROVIDE ALL NECESSARY CONDUIT, BOXES, PULL BOXES, WIRING, SWITCHES AND ACCESSORIES TO INTERCONNECT THE ELECTRICAL ITEM FOR CIRCUITING AND HOMERUNS INDICATED SYMBOLICALLY ON THE DRAWINGS. SEE LEGEND-HOMERUNS DESIGNATION FOR SYMBOLOGY APPLICABLE TO ALL SYMBOLS SHOWN.
- 11. U.O.N. ON PLANS AND SECTIONS: ALL HEAVY LINES ARE NEW EQUIPMENT CONDUIT, WIRING, ETC. ALL LIGHT LINES ARE EQUIPMENT, CONDUIT, WIRING, ETC. BY OTHERS.
- 12. E.C. MUST INCLUDE IN HIS PRICE COORDINATION OF POWER POLE (FOR POWER AND VOICE/DATA) AND WALL "IN-FEED" BOXES AND "WHIPS" (SEALTITE OR EQUAL). E.C. TO PROVIDE ALL WALL BOXES FOR POWER & VOICE.DATA. E.C. MUST PROVIDE POWER WHIP, EMPTY VOICE/DATA RACEWAYS WITH DRAG LINES, AND FINAL POWER CONNECTIONS TO FURNITURE SYSTEMS. FINAL COORDINATION WITH FURNITURE VENDOR IS THE RESPONSIBILITY OF THE E.C.
- 13. E.C. MUST INCLUDE IN HIS PRICE ALL MATERIAL AND LABOR FOR TEMPORARY POWER AND LIGHTING FOR ALL TRADES DURING DEMOLITION (IF APPLICABLE) & CONSTRUCTION.
- 14. POWER DISTRIBUTION NOTE: CONDUITS TO BE AS FOLLOWS. WHERE RUN WITHIN THE BUILDING IN DRY LOCATIONS NOT SUBJECT TO PHYSICAL DAMAGE, PROVIDE ELECTRICAL METALLIC TUBING (EMT) CONDUIT. WHERE RUN IN BUILDING WHERE SUBJECT TO PHYSICAL DAMAGE, WET OR DAMP LOCATIONS, THRU ROOFS OR CONCRETE, PROVIDE THICK-WALLED STEEL RIGID METAL CONDUIT (STEEL RMC).
- 15. PER BUILDING STANDARDS, METAL CLAD (MC) CABLE WITH GROUND WIRE IS THE ONLY ACCEPTABLE FLEXIBLE RACEWAY/WIRING METHOD, UNLESS OTHERWISE NOTED.
- 16. PER BUILDING STANDARDS, PVC CONDUIT IS NOT APPROVED FOR USE IN THIS PROJECT.
- 17. ALL NEUTRAL WIRING FOR MULTIWIRE BRANCH CIRCUITS SHALL BE INSTALLED IN COMPLIANCE WITH ARTICLE 210.4.B. OF THE NATIONAL ELECTRICAL CODE.

ELECTRICAL SCOPE OF WORK

THE BASE SCOPE OF WORK FOR THE ELECTRICAL CONTRACTOR SHALL INCLUDE THE FOLLOWING:

- 1. ALL NEUTRAL WIRING FOR MULTIWIRE BRANCH CIRCUITS SHALL BE INSTALLED IN COMPLIANCE WITH ARTICLE 210.4.B. OF THE NATIONAL ELECTRICAL CODE.
- 2. PROVIDE AND INSTALL 120V CIRCUITS FOR NEW AUDIOVISUAL EQUIPMENT IN ACCORDANCE WITH ELECTRICAL DRAWINGS. ELECTRICAL CONTRACTOR SHALL CONFIRM POWER REQUIREMENTS WITH THE AUDIOVISUAL CONSULTANT. ELECTRICAL CONTRACTOR SHALL FURNISH ALL WIRING, RACEWAY, AND ACCESSORIES THAT ARE NECESSARY TO POWER THE AUDIOVISUAL EQUIPMENT. ROUTING FOR NEW CIRCUITS IS NOT SHOWN ON PLAN AND SHALL BE COORDINATED BY THE CONTRACTOR IN THE FIELD.
- PROVIDE AND INSTALL NEW POWER, DATA, AND AV WIRING DEVICES IN ACCORDANCE WITH ELECTRICAL DRAWINGS.
- 4. PROVIDE AND INSTALL REPLACEMENT SHADE CONTROLS AT LOCATIONS INDICATED ON THE ELECTRICAL DRAWINGS. ELECTRICAL CONTRACTOR SHALL FURNISH SWITCHES, WIRING, AND ACCESSORIES. ELECTRICAL CONTRACTOR SHALL COMMISSION SHADE CONTROLS IN ACCORDANCE WITH MANUFACTURER RECOMMENDATIONS.
- ELECTRICAL CONTRACTOR SHALL COORDINATE WITH AV INSTALLER TO INTEGRATE REPLACEMENT SHADE CONTROLS WITH AV TOUCHSCREEN SYSTEMS.
- PROVIDE AND INSTALL BACKBOXES AND EMPTY CONDUIT WITH DRAGWIRES FOR AUDIOVISUAL AND DATA WIRING IN ACCORDANCE WITH ELECTRICAL AND AV DRAWNGS. THE ELECTRICAL CONTRACTOR SHALL CONFIRM POWER REQUIREMENTS WITH THE AUDIOVISUAL CONSULTANT.
- PROVIDE AND INSTALL NEW LIGHTING CONTROLS FOR ALL ROOMS IN THE SCOPE OF WORK. NEW LIGHTING CONTROLS SHALL INCLUDE OCCUPANCY/VACANCY SENSORS, DAYLIGHT SENSORS. DIMMER SWITCHES, ROOM CONTROLLERS, POWER PACKS, EMERGENCY RELAY CONTROLLERS, PARTITION SENSORS, AND INTERFACE DEVICES. CONNECT NEW LIGHTING CONTROLS TO EXISTING FIXTURES, PROVIDING ALL REQUIRED LOW VOLTAGE WIRING AND NETWORK CABLES.
- PROVIDE AND INSTALL J-HOOKS AND SUPPORTS FOR LOW VOLTAGE WIRING AND/OR NETWORK CABLES FOR THE NEW LIGHTING CONTROLS. ELECTRICAL CONTRACTOR SHALL NEATLY BUNDLE AND ROUTE CABLES IN THE ACCESSIBLE CEILING, AVOIDING EXISTING WIRING. DUCTWORK. AND PIPING.
- ELECTRICAL CONTRACTOR SHALL COORDINATE WITH AV INSTALLER TO INTEGRATE LIGHTING CONTROLS WITH AV TOUCHSCREEN SYSTEMS.
- 10. COMMISSION ALL LIGHTING CONTROLS IN ACCORDANCE WITH THE NEW YORK STATE ENERGY
- 11. CONTRACTOR SHALL PATCH AND REPAIR ALL WALLS AND CEILINGS FOLLOWING ELECTRICAL WORK.
- 12. ALL WORK SHALL COMPLY WITH THE ELECTRICAL, ARCHITECTURAL, AND AUDIOVISUAL CONSTRUCTION SPECIFICATIONS.

ELECTRICAL SYMBOL LEGEND

THIS SYMBOL LEGEND IS SHOWN FOR GENERAL REFERENCE ONLY. THE PRESENCE OF A SYMBOL ON THIS LEGEND DOES NOT IMPLY ITS USE ON THIS PROJECT. REFER TO DRAWINGS FOR SPECIFIC SYMBOLS USED.

- PANELBOARD, SURFACE MOUNTED
- PANELBOARD, RECESSED
- VOICE/DATA DUPLEX, 2 DROPS. NEMA 5-20R RECEPTACLE, DUPLEX ▼ "1"= INDICATES CIRCUIT NUMBER E = EXISTING TO REMAIN
- NEMA 5-20 RECEPTACLE,
- PROVIDE 1" EMT CONDUIT WITH DRAGWIRE TO SERVER ROOM. ▼ DATA DUPLEX, 2 DROPS.


PROVIDE 1" EMT CONDUIT WITH


DRAGWIRE TO SERVER ROOM.

- QUADRUPLEX (J) JUNCTION BOX
- 2#12 & 1#12G 3/4" C.

ALL RECEPTACLE HOME RUNS WILL BE 2#12+1#12G - 3/4"C UNLESS OTHERWISE

- WALL MOUNTED SWITCH. LIGHTING CONTROLS AND SHADE CONTROLS ARE EXISTING TO REMAIN EXCEPT WHERE NOTED.
- WALL MOUNTED POE CAMERA, TO BE SPECIFIED BY AUDIOVISUAL CONSULTANT. E.C. TO PROVIDE 2-GANG RECESSED BACK BOX WITH EMPTY CONDUIT STUB-UP AND DRAG WIRE TO CEILING.
- RECESSED WALL BOX FOR AV, 4-GANG. WIRING DEVICE TO BE SPECIFIED BY AV CONSULTANT. ELECTRICAL CONTRACTOR TO PROVIDE BACKBOX AND EMPTY CONDUIT STUB-UP WITH DRAG WIRE
- AV FLOOR BOX. FURNISH WIRING DEVICES PER ELECTRICAL AND AUDIOVISUAL DRAWINGS.

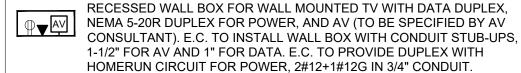

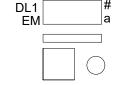

LIGHT FIXTURES, VARIOUS. SEE LIGHTING FIXTURE SCHEDULE ON DRAWING E-604.

- "DL1" INDICATES FIXTURES NAME "#" INDICATES CIRCUIT NUMBER
- "a" INDICATES FIXTURES CONTROL ZONE "EM" INDICATES EMERGENCY POWER BY BATTERY PACK

EXIT SIGN, CEILING MOUNTED; EXIT SIGN, WALL MOUNTED. ARROWS INDICATE CHEVRON DIRECTION.

(#) REFER TO SUPPLEMENTAL FIGURE OR NOTE INDICATED BY NUMBER.

XXX → DETAIL TAG/CALL OUT TAG

X-XXX ELECTRICAL SHEET NUMBER

LIGHTING CONTROLS SYMBOL LEGEND

- DIGITAL 0-10V DIMMER, WALL MOUNTED. WATTSTOPPER LMSW-211 OR APPROVED EQUAL. LOWER CASE LETTER DENOTES FIXTURE CONTROL
- VACANCY SENSOR, DUAL TECHNOLOGY, CEILING MOUNTED. WATTSTOPPER LMDC-100 OR APPROVED EQUAL. LETTER DENOTES FIXTURE CONTROL ZONE.
- ROOM CONTROLLER INSTALLED IN ACCESSIBLE CEILING.WATTSTOPPER LMRC-21X WITH 0-10V DIMMING, OR APPROVED EQUAL. LETTER DENOTES FIXTURE CONTROL ZONE.
 - PROVIDE WIRING FOR 120V POWER AND 0-10V DIMMING TO ALL FIXTURES IN ZONE. PROVIDE MULTIPLE POWER PACKS PER ZONE AS NECESSARY. PROVIDE AND INSTALL CAT5E NETWORK CABLES TO CONNECT SWITCHES, DIMMERS, AND SENSORS, E.C. SHALL COORDINATE WITH LIGHTING CONTROLS MANUFACTURER TO PROGRAM ALL DEVICES.
- EMERGENCY LIGHTING CONTROL UNIT INSTALLED IN ACCESSIBLE CEILING. SUPPLY WITH EMERGENCY AND NORMAL (SENSING) 277V/1P CIRCUITS. CONNECT OUTPUT TO "EM" LIGHT FIXTURES. INSTALL AND TEST IN ACCORDANCE WITH LIGHTING CONTROLS MANUFACTURER RECOMMENDATIONS.
- PHOTOSENSOR FOR DAYLIGHT HARVESTING, WIRELESS, CEILING MOUNTED. WATTSTOPPER LMLS-500 OR APPROVED EQUAL. LETTER DENOTES FIXTURE CONTROL ZONE.
- SERIAL DATA INTERFACE FOR INTEGRATION OF LIGHTING CONTROLS WITH AUDIOVISUAL SYSTEM VIA RS-232 CONNECTION. WATTSTOPPER LMDI-100 OR APPROVED EQUAL. COORDINATE INSTALLATION WITH AV SYSTEM MANUFACTURER.
- PARTITION SENSOR SYSTEM FOR AUDITORIUM. REFER TO DETAIL ON E-302 FOR COMPONENT SPECIFICATIONS.

NOTE: WATTSTOPPER SERVES AS THE BASIS OF DESIGN FOR ALL LIGHTING CONTROLS. REFER TO LIGHTING CONTROL DETAILS FOR DEVICE SPECIFICATIONS. WATTSTOPPER IS SPECIFIED AND APPROVED FOR THIS WORK BASED ON COMPATIBILITY WITH CRESTRON AV SYSTEMS. SUBSTITUTION WITH ANOTHER LIGHTING CONTROL MANUFACTURER MUST BE THOROUGHLY REVIEWED AND APPROVED BY THE ELECTRICAL AND AV DESIGNERS, TO ENSURE COMPATIBILITY.

TYPICAL DEVICE MOUNTING HEIGHT

RECEPTACLES (OFFICE AREA)	18" AFF
RECEPTACLES (U.O.N.) LIGHT	36" AFF
SWITCHES	48" AFF
DISCONNECT SWITCHES	NEC 404.8(A)
TELEPHONE OUTLETS	18" AFF
WALL MOUNTED TELEPHONE OUTLET	48" AFF
COMPUTER OUTLETS	18" AFF
FIRE ALARM PULL STATION	48" AFF
FIRE ALARM AUDIO/VISUAL ALARM	80" AFF
EXIT LIGHTS (WALL MOUNTED)	12" ABOVE DOOR
EMERGENCY LIGHTS (WALL MOUNTED)	7'-6" AFF
TV OUTLETS	REFER TO ARCH.
AUDIO/VIDEO OUTLETS	REFER TO ARCH.

ABBREVIATIONS

NOTE: DIMENSIONS ARE TO DEVICE CENTERLINE UNLESS NOTED OTHERWISE

A AD AFF ALT AWG BKR C CB CKT	AMP-AMPERE ACCESS DOOR ABOVE FINISHED FLOOR ALTERNATE AMERICAN WIRE GAUGE BREAKER CONDUIT/CONDUCTOR CIRCUIT BREAKER CIRCUIT	KWA KWH LP LTG MFR MCA MCB MLO MOCP	KILOWATT KILOWATT HOUR LIGHTING PANEL LIGHTING MANUFACTURER MINIMUM CIRCUIT AMPACITY MAIN CIRCUIT BREAKER MAIN LUGS ONLY MAXIMUM OVERCURRENT PROTECTION
		_	
		_	
_		_	
			MAXIMUM OVERCURRENT PROTECTION
CU	COPPER	N	NEUTRAL
DWG	DRAWING	NEC	NATIONAL ELECTRICAL CODE
EC	ELECTRICAL CONTRACTOR	NEMA	NATIONAL ELECTRICAL
ELEC	ELECTRICAL		MANUFACTURERS ASSOCIATION
E	EXISTING TO REMAIN	NIC	NOT IN CONTRACT
G	GROUND	PNL	PANEL
GFI	GROUND FAULT CURRENT INTERRUPTER	TYP	TYPICAL
HD	HAND DRYER	UON	UNLESS OTHERWISE NOTED
HP	HORSEPOWER	V	VOLT OR VOLTAGE
HUM	HUMIDIFIER	VB	VIEW BOX
JC	JANITOR'S CLOSET	WT	WEIGHT
KV	KILOVOLT	Χ	TO BE REMOVED
KVA	KILOVOLT AMPERE		

ELECTRICAL DRAWING LIST

SHEET NO.	SHEET NAME	REVISON NO.	REVISION DATE
E-001.00	ELECTRICAL NOTES, SYMBOLS, ABBREVIATIONS AND DRAWING LIST	0	-
E-101.00	ELECTRICAL 15TH FLOOR AUDIOVISUAL COORDINATION PLAN	0	-
E-102.00	ELECTRICAL 15TH FLOOR PARTIAL POWER PLAN - AUDITORIUM	0	-
E-103.00	ELECTRICAL 15TH FLOOR PARTIAL POWER PLAN - SOUTHEAST	0	-
E-104.00	ELECTRICAL 15TH FLOOR PARTIAL POWER PLAN - SOUTH	0	-
E-201.00	LIGHTING 15TH FLOOR PLAN	0	-
E-202.00	LIGHTING 15TH FLOOR PARTIAL PLAN - AUDITORIUM	0	-
E-203.00	LIGHTING 15TH FLOOR PARTIAL PLAN - SOUTHEAST	0	-
E-204.00	LIGHTING 15TH FLOOR PARTIAL PLAN - SOUTH	0	-
E-301.00	ELECTRICAL DETAILS	0	-
E-302.00	LIGHTING CONTROL DETAILS	0	-



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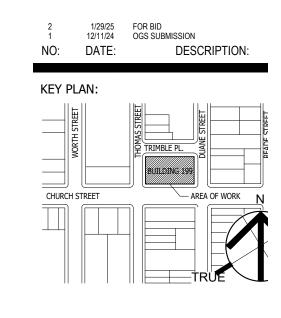


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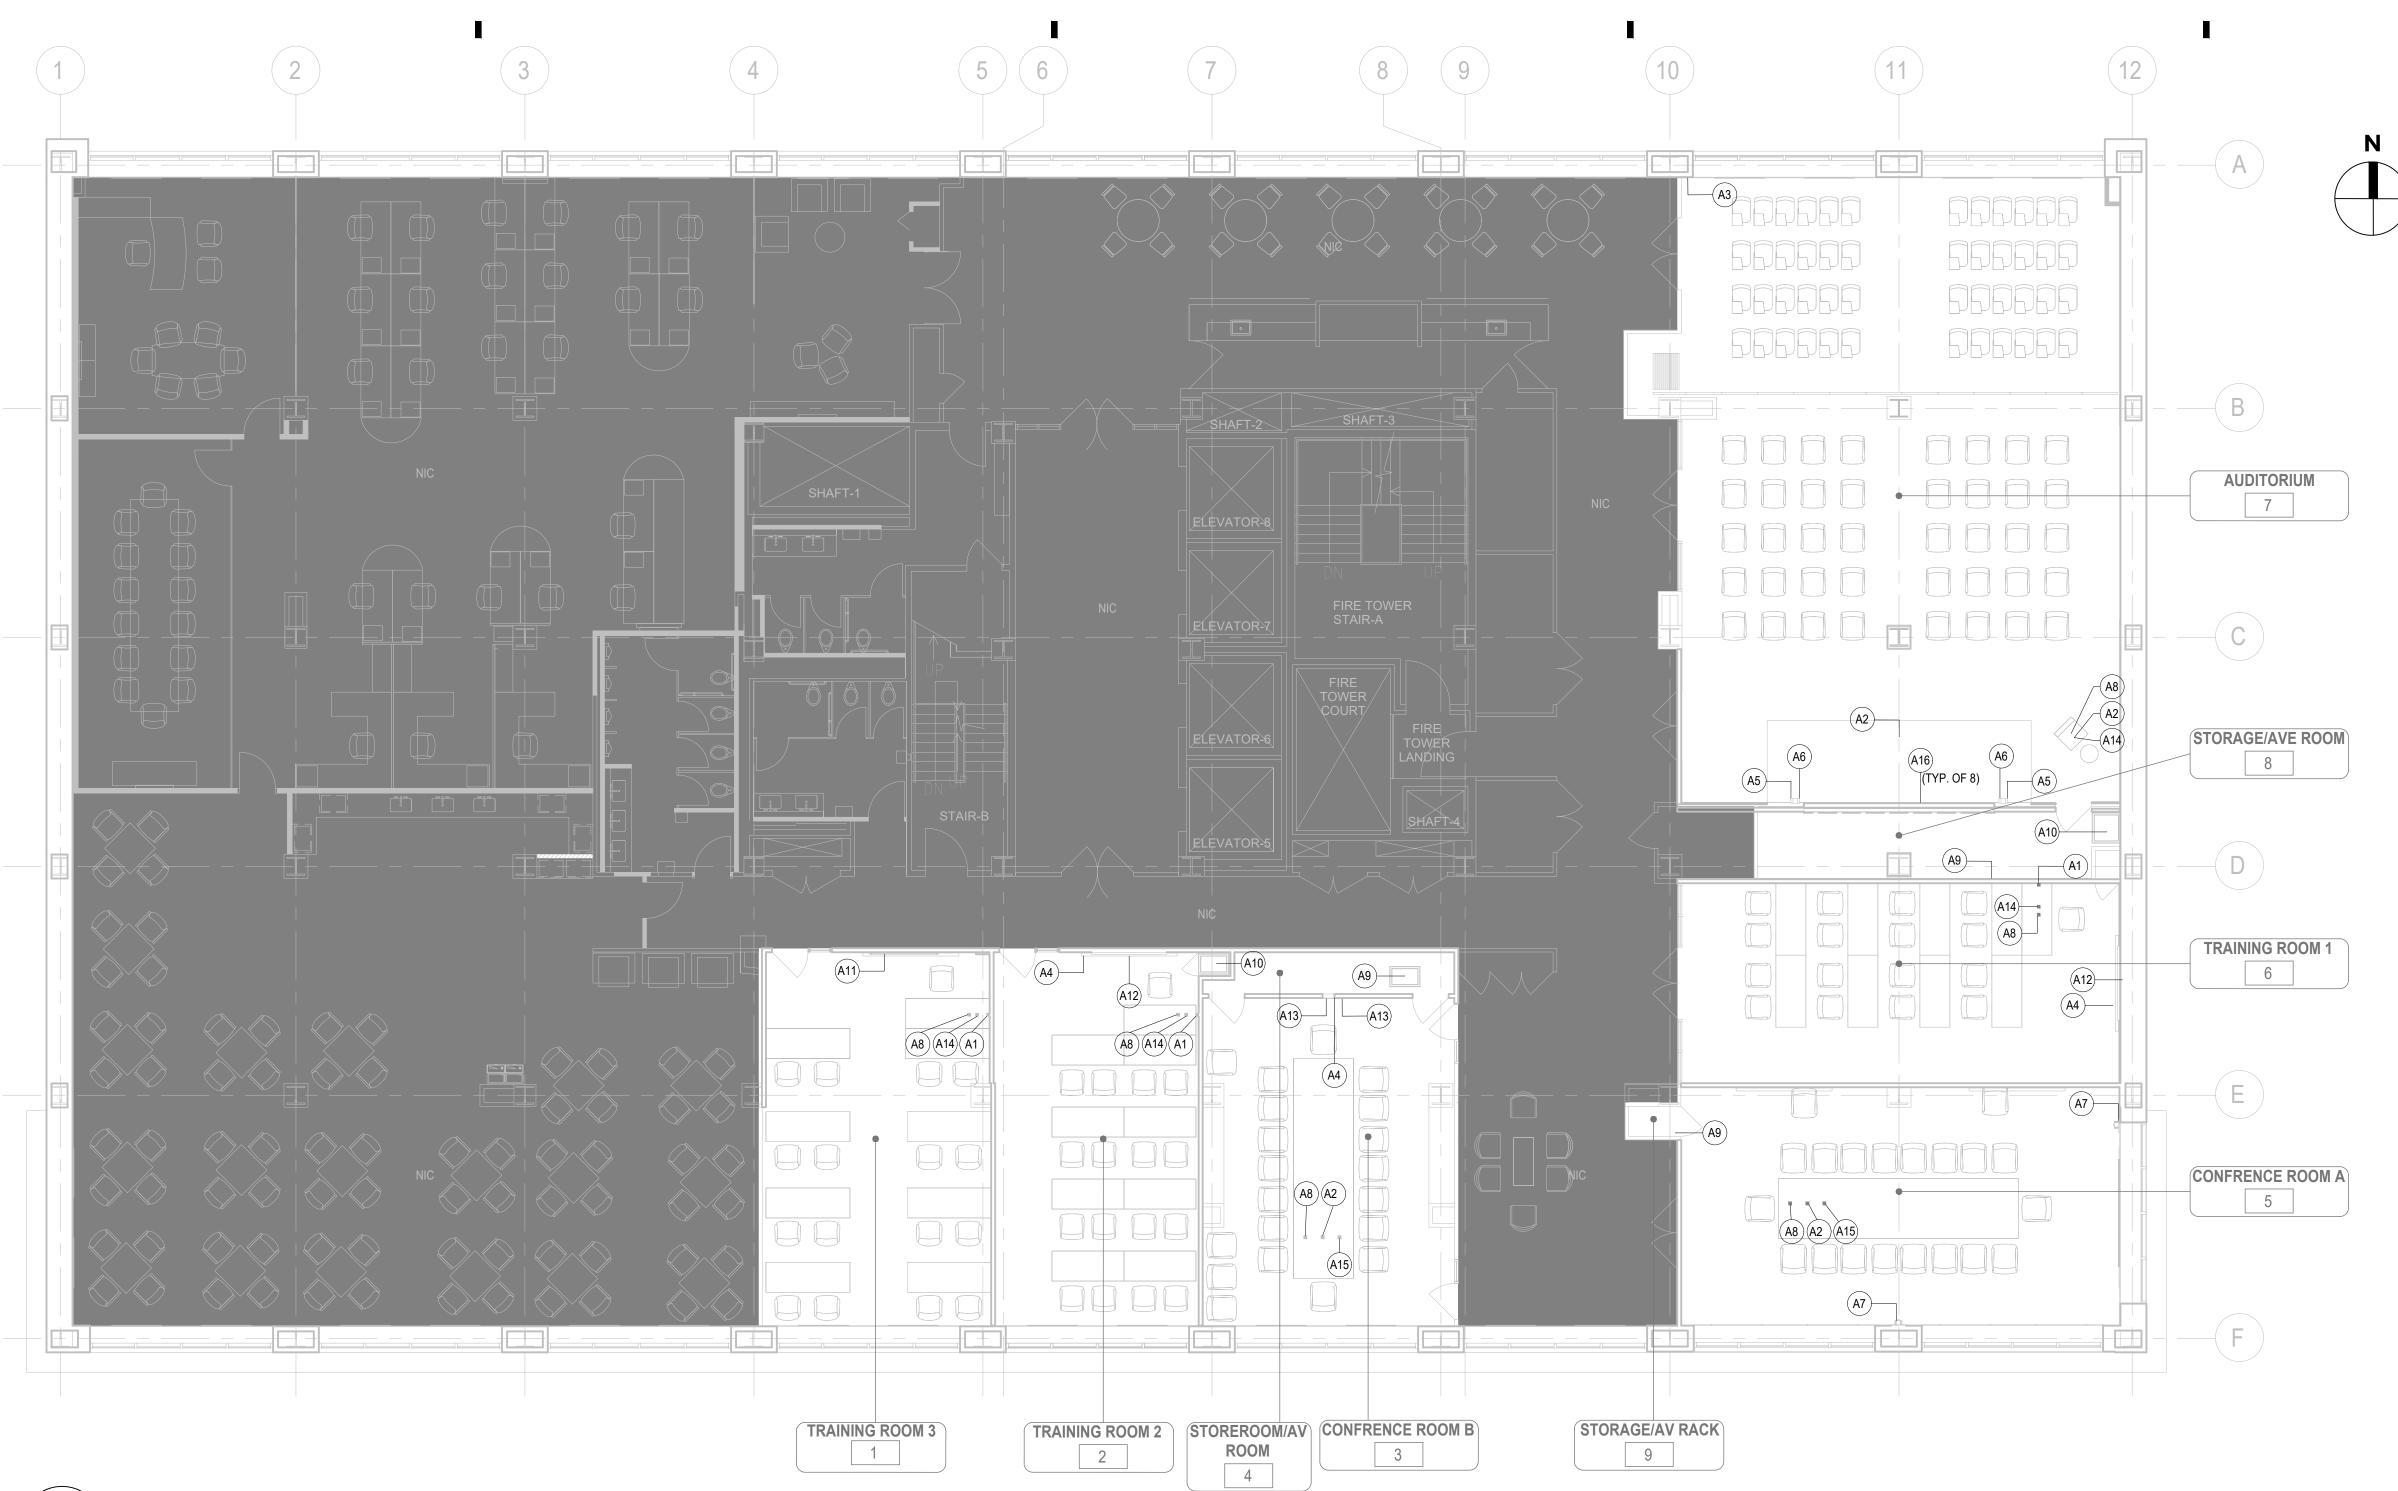
ABBREVIATIONS, AND DRAWING LIST

DRAWING TITLE: ELECTRICAL NOTES, SYMBOLS,

09/09/24 N.T.S.

DRAWING NO.:

21-048-1165.02



ELECTRICAL 15TH FLOOR AUDIOVISUAL COORDINATION PLAN E-101 / SCALE: 1/8" - 1' - 0"

				AUDIOVISUAL I	KEYNOTE SCHEDULE			
EYNOTE	DEVICE QTY	DEVICE ID	DEVICE TYPE	AV INFRASTRUCTURE	DEVICE POWER	POWER SOURCE QTY (PER LOCATION)	DATA	# OF DATA DROPS
A1	3	AVPO1	AV WALL PLATE	2-GANG	EXISTING	-	EXISTING	-
A2	4	AVPO2	AV FLOORBOX PLATE	EXISTING AV FLOOR BOX	120V/20A QUAD RECEPTACLE, 5-20R	2	EXISTING	-
А3	1	AVPO4	AV WALL PLATE	4-GANG	120V/20A DUPLEX RECEPTACLE, 5-20R	1	CATEGORY 6	2
Α4	3	CAM03	INTEGRATED VIDEO CAMERA BAR (CISCO)	-	-	-	-	-
A5	2	CAM05	PTZ VIDEO CAMERA - WALL (1BEYOND)	-	-	-	-	-
Α6	2	CAM05	PTZ VIDEO CAMERA - WALL (1BEYOND)	2-GANG	-	-	-	-
Α7	2	CAM06-W	PTZ VIDEO CAMERA - WALL (CISCO)	2-GANG	-	-	-	-
A8	6	CTP01	TABLE TOP AV CONTROL PANEL	TABLE GROMMET	-	-	-	-
Α9	3	ER01	AV EQUIPMENT RACK - FULL HEIGHT	EXISTING AV INFRASTRUCTURE	EXISTING POWER	-	EXISTING	-
A10	2	ER02	AV RACK, CREDENZA	EXISTING AV INFRASTRUCTURE	EXISTING POWER	-	EXISTING	-
A11	1	FPD05-VC	75" ALL-IN-ONE VC APPLIANCE	RPV WALLMATE 32	120V/20A DUPLEX RECEPTACLE, 5-20R	1	CATEGORY 6	2
A12	2	FPD06	FLAT PANEL DISPLAY, 85"	RPV WALLMATE 32	120V/20A DUPLEX RECEPTACLE, 5-20R	1	-	-
A13	2	FPD06-E	EXISTING FLAT PANEL DISPLAY, 80"	-	120V/20A DUPLEX RECEPTACLE, 5-20R	1	-	-
A14	4	TH01	AV TABLE HATCH	-	-	-	-	-
A15	2	TH-E	EXISTING AV TABLE HATCH	-	-	-	-	-
					RECEPTACLE, 5-20R - INSTALLED IN			
			DIRECT VIEW LED VIDEO WALL - 32:9		ARLINGTON TVBS503 RECESSED OUTLET			
A16	8	LED01	ASPECT RATIO 8X4	2-GANG	ВАСКВОХ	1	_	-



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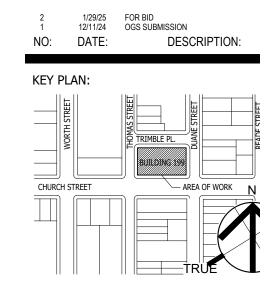
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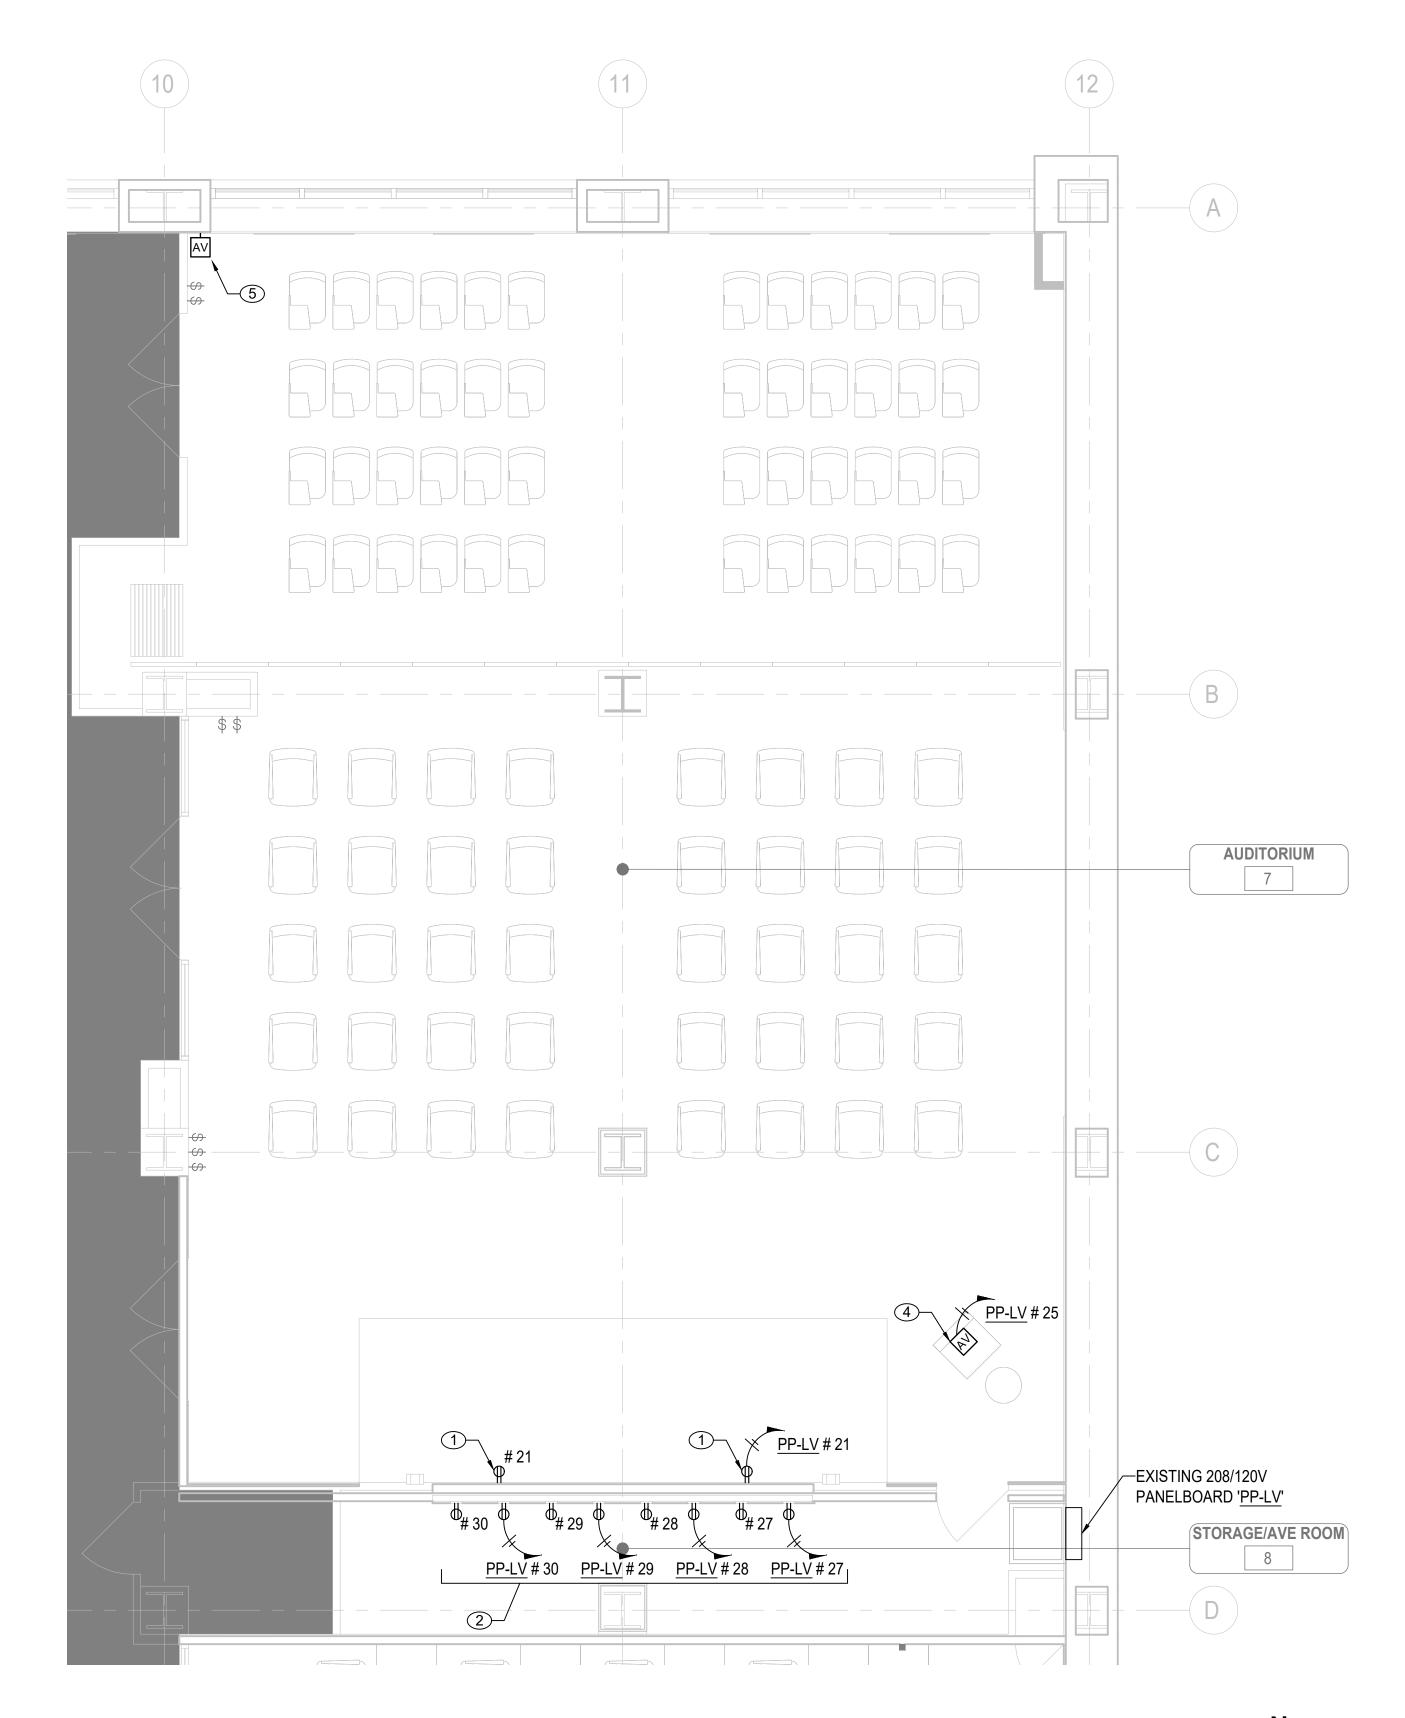


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DRAWING TITLE: ELECTRICAL 15TH FLOOR AUDIOVISUAL COORDINATION

ISSUE DATE:	
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PROJECT NO.:	SCALE:
21-048-1165.02	1/8" = 1'-0"

DRAWING NO.: E-101.00



1 ELECTRICAL 15TH FLOOR PARTIAL POWER PLAN - AUDITORIUM SCALE: 1/4" - 1' - 0"



ELECTRICAL CONSTRUCTION NOTES:

- 1 PROVIDE AND INSTALL (2) NEMA 5-20R DUPLEX RECEPTACLES, SURFACE WALL MOUNTED BELOW THE AUDITORIUM STAGE. STUB THROUGH WALL INTO AV ROOM AND HOMERUN TO EXISTING PANEL PP-LV, 2 #12 + 1 #12 GND IN 3/4" EMT CONDUIT. CONNECT TO SPARE 15A/1P BREAKER.
- 2 PROVIDE AND INSTALL (8) NEMA 5-20R DUPLEX RECEPTACLES MOUNTED TO NEW FRAME FOR VIDEO WALL. PROVIDE (4) HOMERUN CIRCUITS TO EXISTING PANEL PP-LV, (4) SETS OF 2 #12 + 1 #12 GND IN 3/4" EMT CONDUIT.
- 3 PROVIDE AND INSTALL (6) 20A/1P BREAKERS IN EXISTING PANEL PP-LV TO SERVE NEW AUDITORIUM VIDEO WALL, AUDITORIUM PODIUM FLOOR BOX, AND TRAINING ROOM TV.
- 4 EXISTING FSR-TYPE FLOOR BOX UNDER PODIUM IS DAMAGED. ELECTRICAL CONTRACTOR TO REPAIR IN PLACE WITH NEW BRACKETS AND WIRING DEVICES. FURNISH AND INSTALL (1) NEMA 5-20R DUPLEX, (1) DATA DUPLEX, AND AV DEVICES SPECIFIED BY AV CONSULTANT IN FLOOR BOX. INSTALL NEW CIRCUIT IN EXISTING CONDUIT TO THE AV ROOM, 2#12+1#12. INSTALL ADDITIONAL 3/4" EMT CONDUIT TO EXTEND CIRCUIT TO PANEL PP-LV AS NEEDED.
- 5 NEW AV WALLBOX LOCATION, REFER TO AV DRAWINGS FOR REQUIREMENTS. E.C. TO PROVIDE NEW RECESSED WALL BOX AND CONDUIT STUB-UP TO CEILING.

			EX	IST	<u>ING</u>	<u>A</u> L	JDITORIUM	POWER F	PANI	EL (PP-	LV)		
CKT NO.		UNIT V.A					LOAD PER P	HASE (V.A.)					UNIT V.A.		CKT NO.
	DESCRIPTION		POLES	TRIP	WIRE SIZE	CONDUIT SIZE	A	В	CONDUIT SIZE	WIRE SIZE	TRIP	POLES		DESCRIPTION	
1	(1) AV (RM 9)	180	1	15	-	-	360		-	-	15	1	180	(1) AV (RM 3)	16
2	(9) AV (RM 9)	1080	1	15	-	-		1,440	-	-	20	1	360	(2) VIDEO PROJ. (RM3)	17
3	(2) VIDEO PROJ. (RM8)	360	1	20	-	-	720		-	-	20	1	360	(2) CONF. DESKS (RM3)	18
4	(2) AV (RM 8)	360	1	20	-	-		540	-	-	15	1	180	(1) AV (RM 2)	19
5	(1) AV (RM 8)	180	1	15	-	-	540		-	-	20	1	360	(1) AV & (1) VIDEO PROJ. (RM 2)	20
6	(2) FSR (RM 10)	360	1	20	-	-		720	3/4"	12	15	1	360	STAGE	21
7	(2) FSR (RM 10)	360	1	20	-	-	540		-	-	15	1	180	TR #1 PROJ.	22
8	(2) FSR (RM 11)	360	1	20	-	-		360	-	-	15	٦	0	SPARE	23
9	(2) PLASMA DISPLAY (RM 11)	360	1	20	-	-	360		-	-	15	1	0	SPARE	24
10	(1) AV (RM 7)	180	1	15	-	-		360		12	20	1	180	FSR - AUDITORIUM	25
11	(1) AV & (1) VIDEO PROJ. (RM 7)	360	1	20	-	-	540		3/4"	12	20	1	180	TRAINING ROOM A TV	26
12	(1) AV (RM 6)	180	1	15	-	-		540		12	20	1	360	VIDEO WALL	27
13	(1) AV & (1) VIDEO PROJ. (RM 6)	360	1	20	-	-	720		3/4"	12	20	1	360	VIDEO WALL	28
14	(2) CONF. DESKS (RM6)	360	1	20	-	-		720	3/4"	12	20	٦	360	VIDEO WALL	29
15	(1) AV (RM 3)	180	1	15	-	-	540		3/4"	12	20	1	360	VIDEO WALL	30
							4320	4680							
	VOLTAGE	120 V							•				30	POLES	
	PANEL AMP RATING	125A				TO	TAL KVA:	9.0						KAIC RATING	
	PHASE	1	1			TOT	AL AMPS:	25.0					SURF	MOUNTING	
	WIRE	2	1											FED FROM	
	MAIN BREAKER	100A MLO)										MODEL	GE	

NOTE: ALL CIRCUITS ARE EXISTING TO REMAIN, EXCEPT NEW CIRCUITS INDICATED BY KEYNOTE.



102 SCALE: N.T.S.



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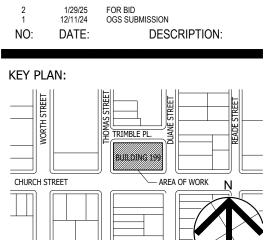
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SHEN MILSOM & WILKE, LLC

AUDIO AND VISUAL CONSULTANT
275 MADISON AVE
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SEAL AND SIGNATURE:



DRAWING TITLE:

ELECTRICAL 15TH FLOOR PARTIAL POWER PLAN - AUDITORIUM


12/11/24

PROJECT NO.: SCALE:
21-048-1165.02 1/4" = 1'-0"

DRAWING NO.:

E-102.00

PROJECT LOCATION:

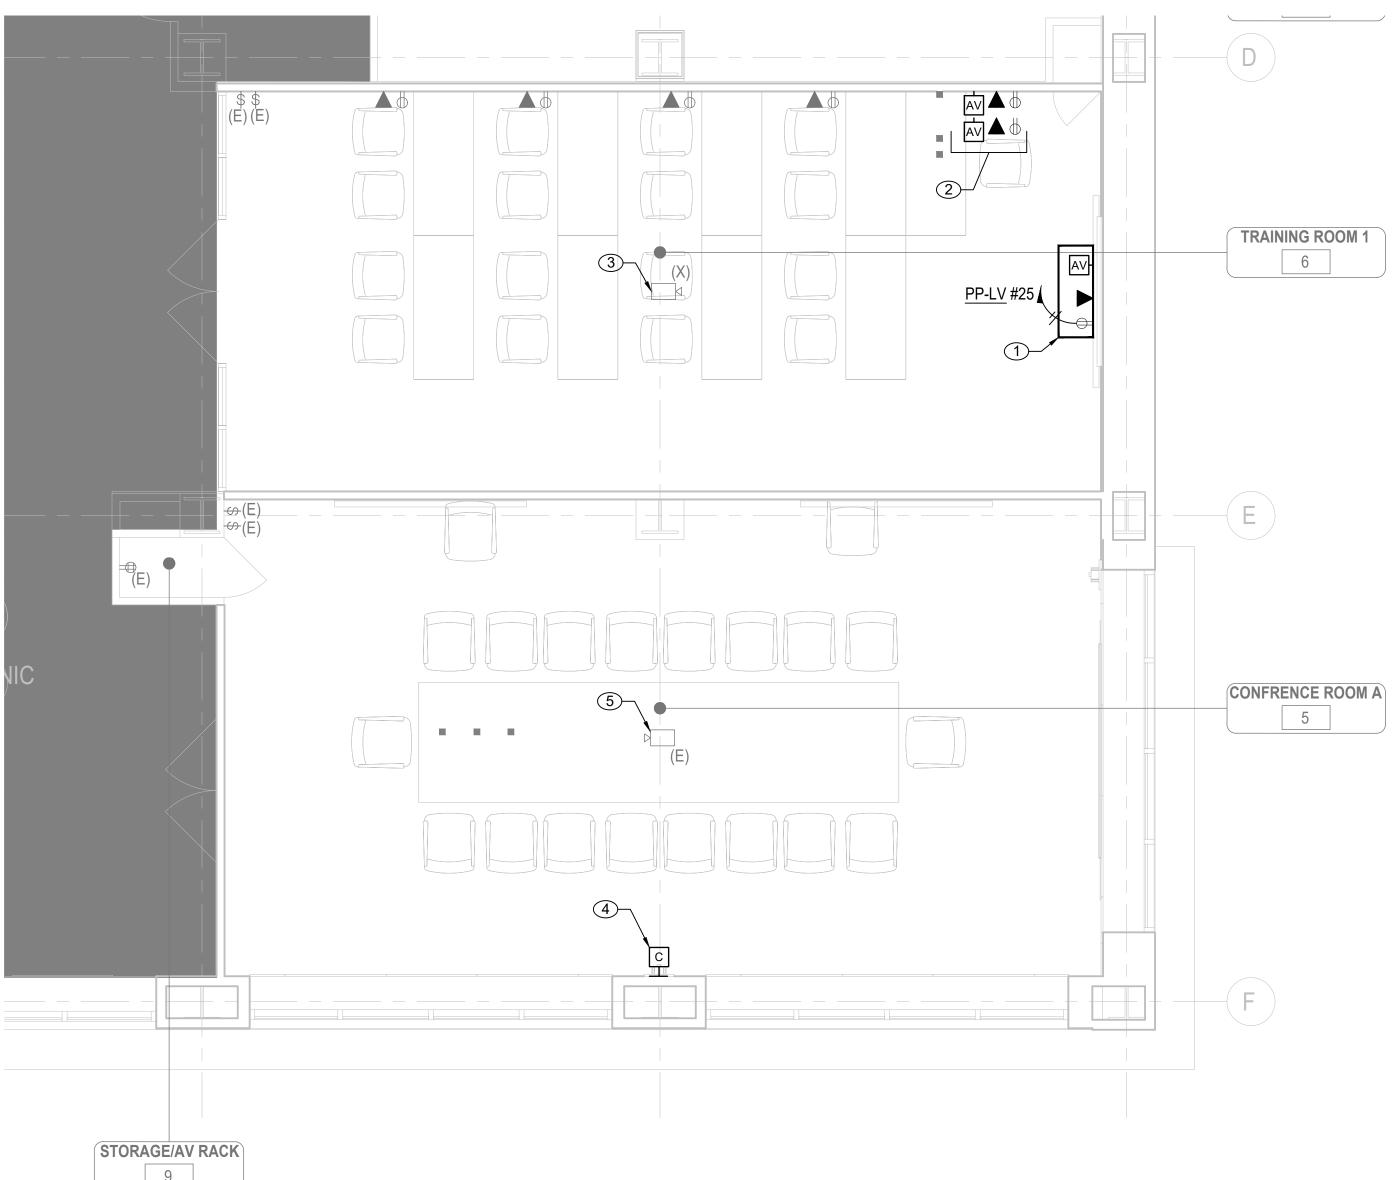

E-103 / SCALE: 1/4" - 1' - 0"



ELECTRICAL CONSTRUCTION NOTES:

- 1) RECESSED BOX FOR NEW WALL MOUNT TV, REFER TO AV DRWAING FOR SPECIFICATION. PROVIDE CONDUIT STUB-UPS FOR AV AND DATA. PROVIDE AND INSTALL NEMA 5-20R DUPLEX WITH NEW HOMERUN CICUIT AS SHOWN. 2#12+1#12G IN 3/4" EMT CONDUIT.
- 2 EXISTING WALL OUTLETS FOR POWER, AV, AND DATA IN TRAINING ROOM A ARE DAMAGED AND SHALL BE REPLACED IN-KIND. E.C. TO PROVIDE AND INSTALL NEW TAMPER-RESISTANT NEMA 5-20R RECEPTACLES, DUPLEX DATA OUTLETS, AND AV WALL BOX TO BE SPECIFIED BY AV CONSULTANT. UTILIZE EXISTING WIRING AT THESE LOCATIONS. PROVIDE AND INSTALL NEW WALL PLATES TO MATCH PREVIOUS.
- 3 EXISTING CEILING MOUNTED PROJECTOR IN TRAINING ROOM A TO BE REMOVED. DEMOLISH ALL WIRING TO SOURCE. CONTRACTOR TO REPLACE EXISTING ACT CEILING TILES AS
- 4) NEW CAMERA LOCATION IN CONFERENCE ROOM A, REFER TO AV DRAWINGS FOR REQUIREMENTS. E.C. TO PROVIDE NEW RECESSED WALL BOX AND CONDUIT STUB-UP TO
- (5) CEILING MOUNTED PROJECTOR IN CONFERENCE ROOM A IS EXISTING TO REMAIN.



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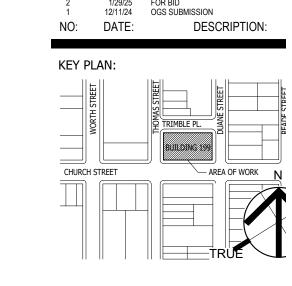
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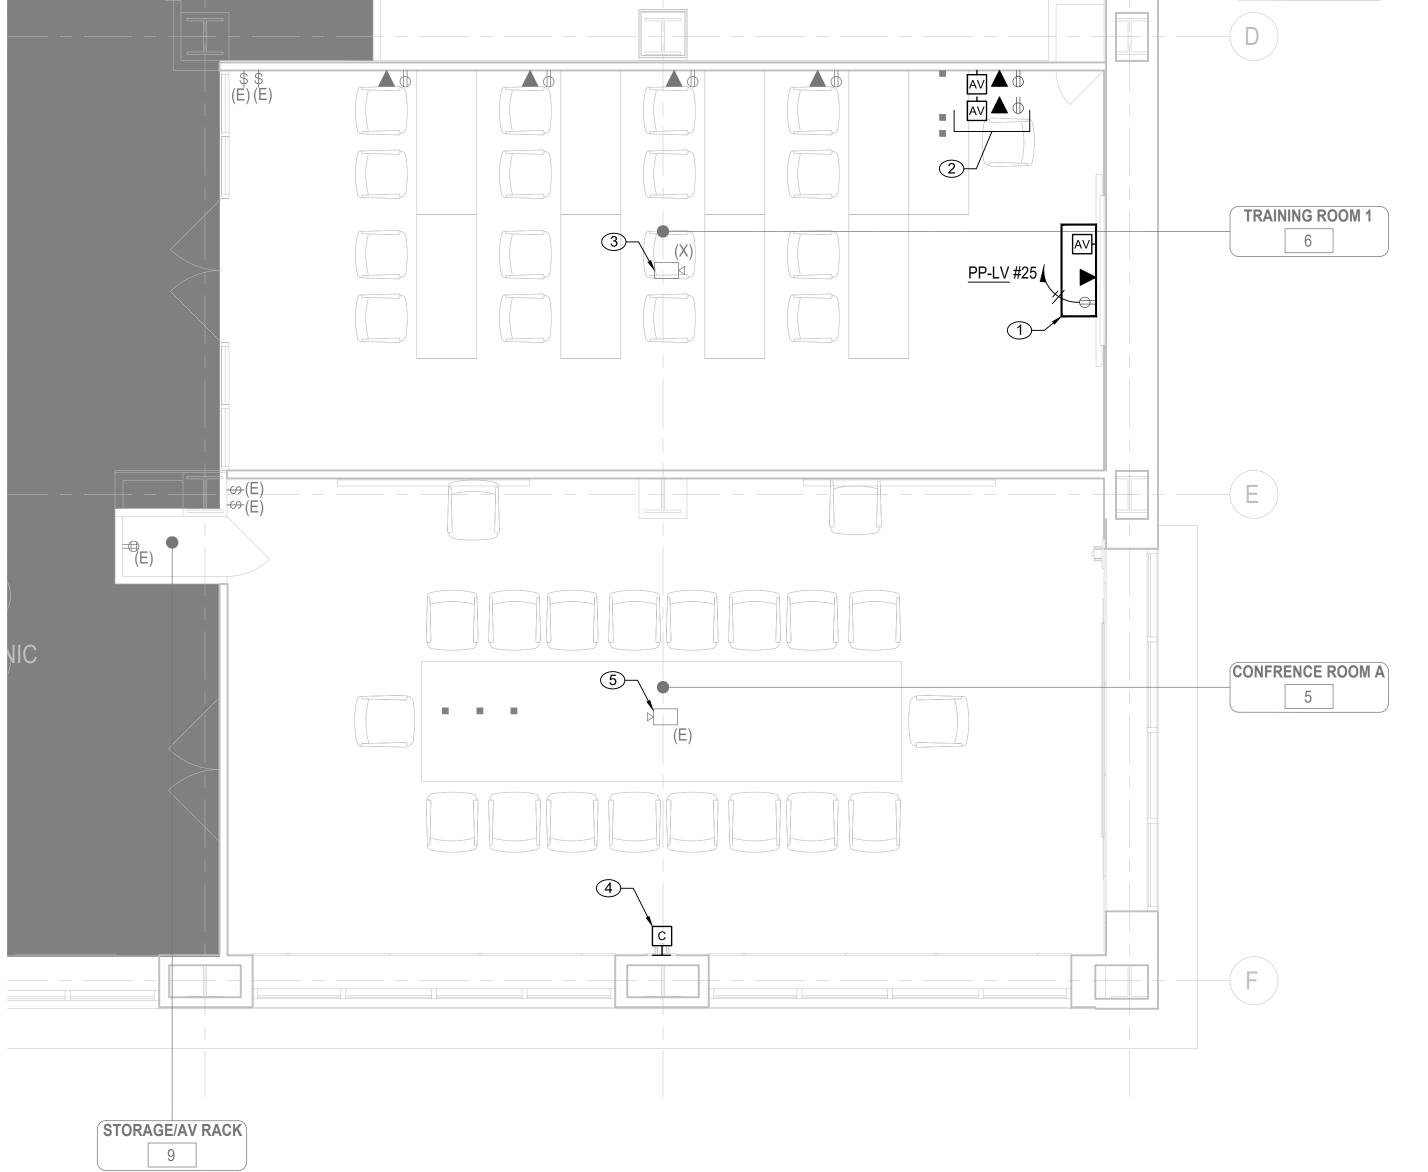
OGS PROJECT NO. SF760

DRAWING TITLE: ELECTRICAL 15TH FLOOR PLAN


12/11/24 1/4" = 1'-0" 21-048-1165.02 DRAWING NO.:

E-103.00

PROJECT LOCATION:
Autodesk Docs://NYSIF A/21-048-1165.02_ARC_NYSIF_LH.rvt



ELECTRICAL 15TH FLOOR PARTIAL POWER PLAN - SOUTHEAST

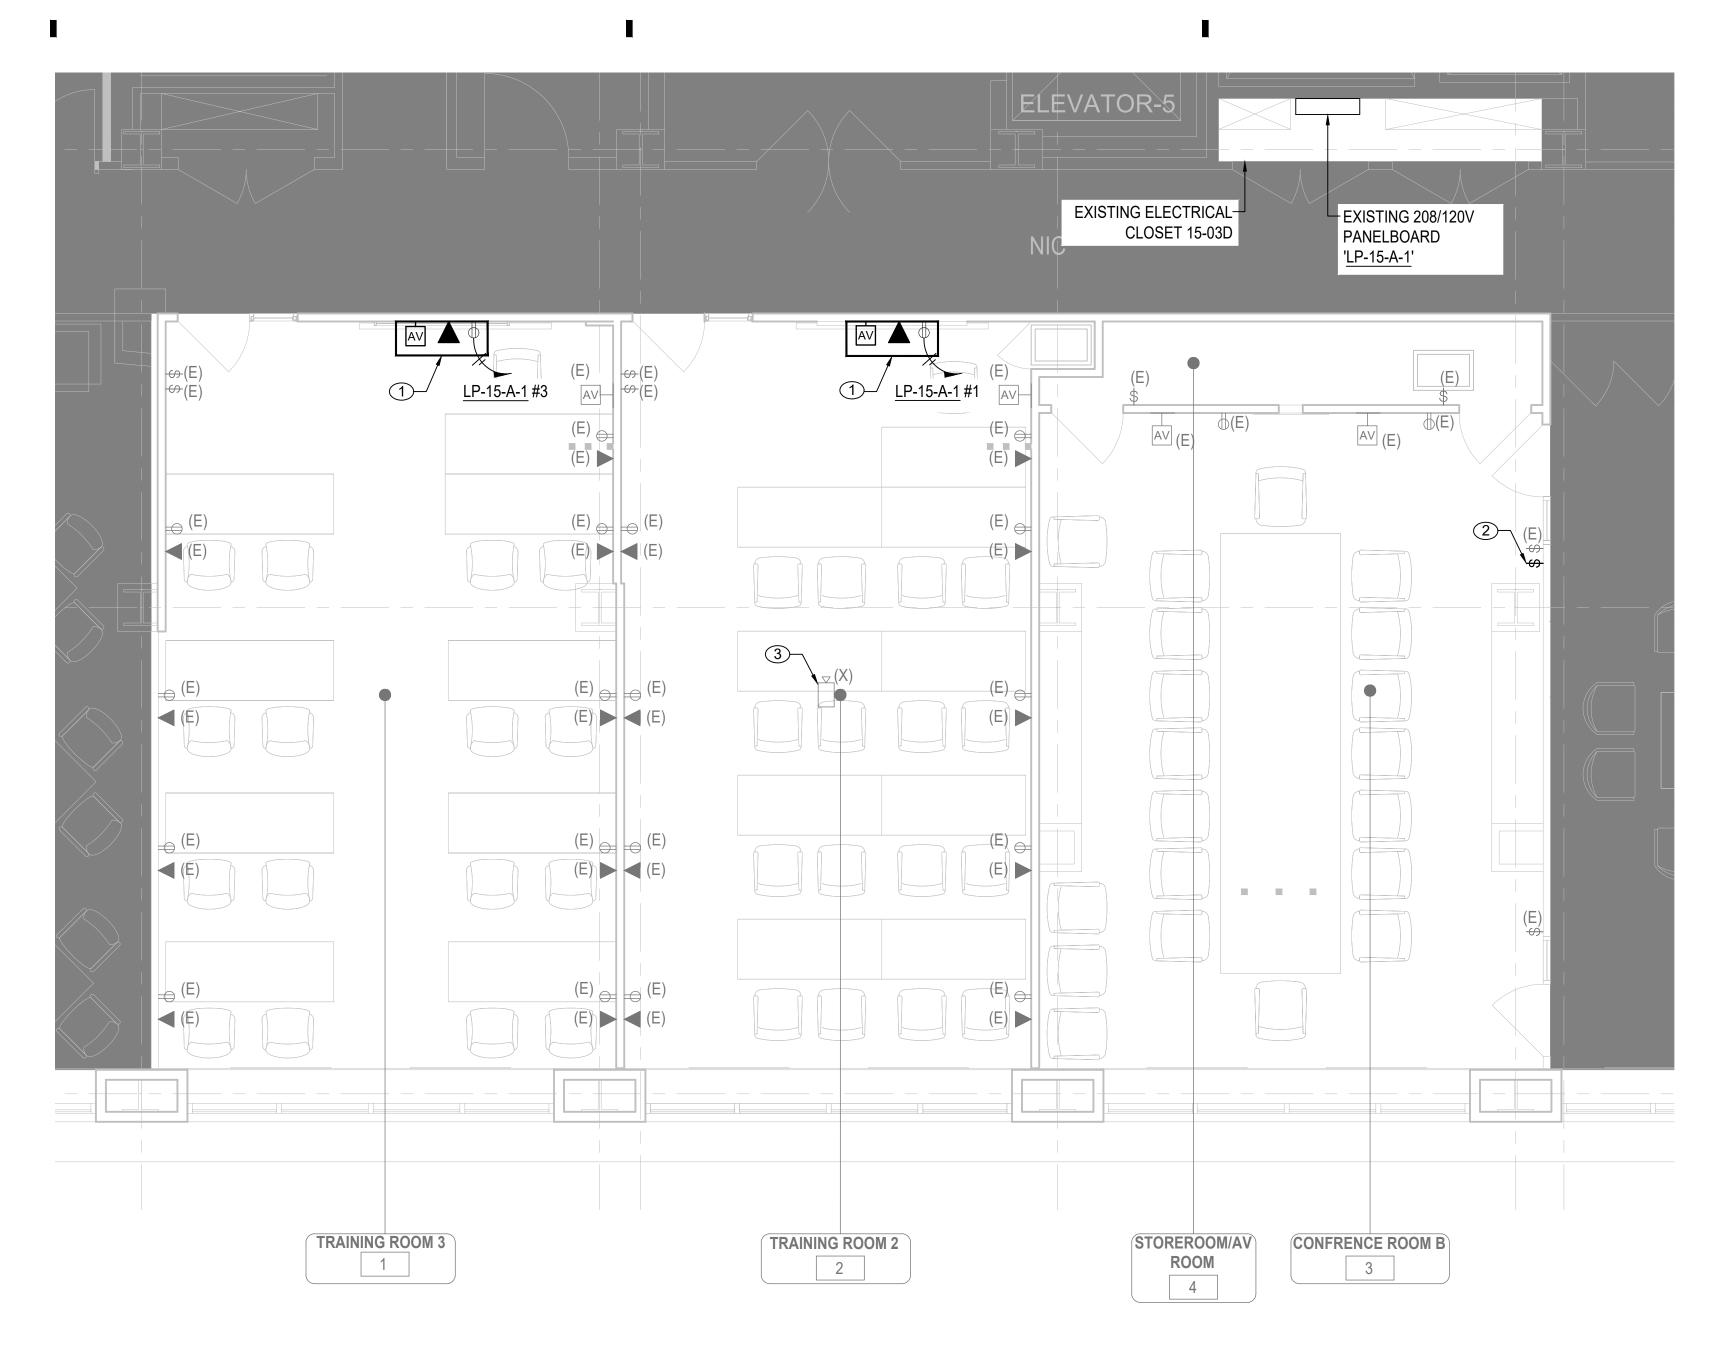

1 ELECTRICAL 15TH FLOOR PARTIAL POWER PLAN - SOUTH
E-104 SCALE: 1/4" - 1' - 0"



ELECTRICAL CONSTRUCTION NOTES:

- 1 RECESSED BOX FOR NEW WALL MOUNT TV, REFER TO AV DRWAING FOR SPECIFICATION.
 PROVIDE CONDUIT STUB-UPS FOR AV AND DATA. PROVIDE AND INSTALL NEMA 5-20R DUPLEX
 WITH NEW HOMERUN CICUIT AS SHOWN. 2#12+1#12G IN 3/4" EMT CONDUIT.
- 2 SHADE RAISE/LOWER SWITCH AT THE INDICATED LOCATION IS NOT FUNCTIONING, TO BE REPLACED BY E.C. ELECTRICAL CONTRACTOR SHALL PROVIDE AND INSTALL NEW WIRING TO SHADE ROLLER MOTOR AND REPLACEMENT SWITCH AND WALL PLATE, MATCHING PREVIOUS.
- 3 EXISTING CEILING MOUNTED PROJECTOR TO BE REMOVED. DEMOLISH ALL WIRING TO SOURCE. CONTRACTOR TO REPLACE EXISTING ACT CEILING TILES AS NEEDED.



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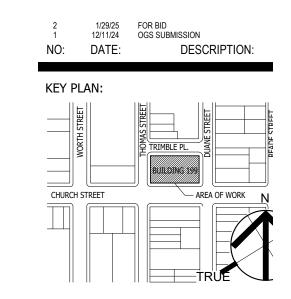
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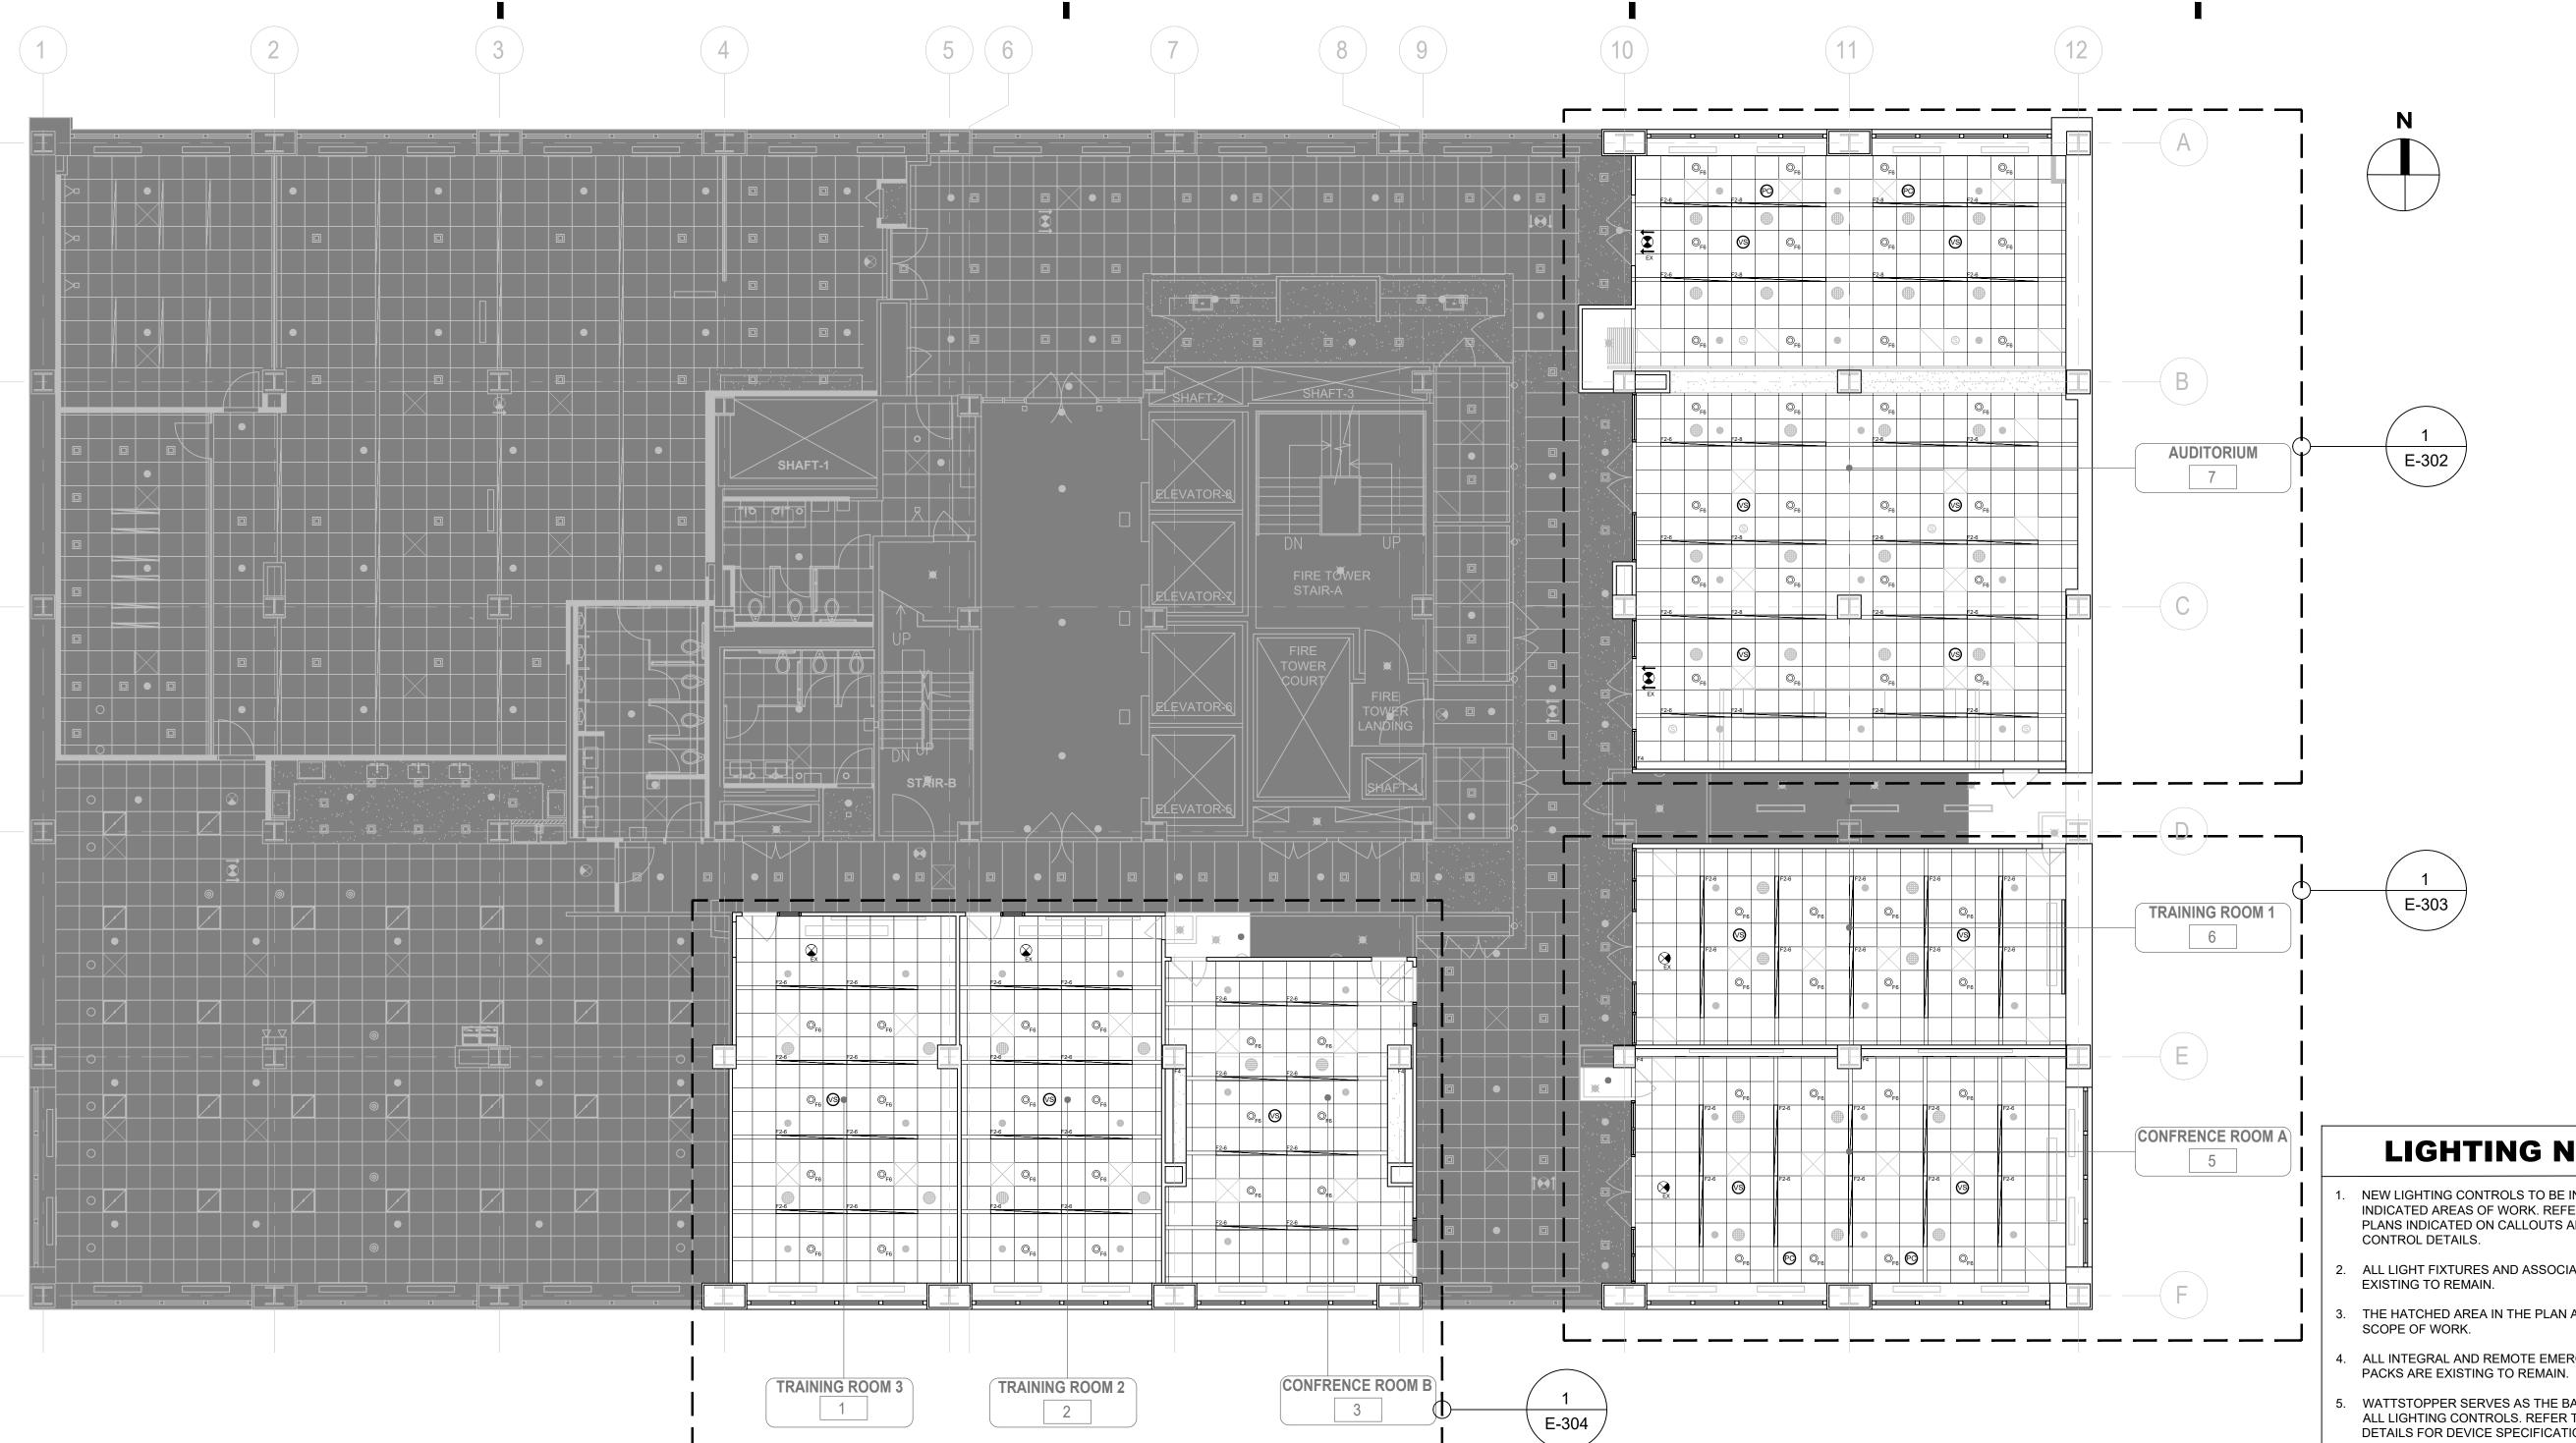
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DRAWING TITLE: ELECTRICAL 15TH FLOOR PLAN

	DDAWING NO :	
	21-048-1165.02	1/4" = 1'-0"
,	PROJECT NO.:	SCALE:
	12/11/24	
	ISSUE DATE:	

E-104.00

ROJECT LOCATION: utodesk Docs://NYSIF A/21-048-1165.02_ARC_NYSIF_LH.rvt



CONSULTANT:

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KEY PLAN:

CHURCH STREET

LIGHTING NOTES:

- NEW LIGHTING CONTROLS TO BE INSTALLED IN THE INDICATED AREAS OF WORK. REFER TO THE LIGHTING PLANS INDICATED ON CALLOUTS AND LIGHTING
- ALL LIGHT FIXTURES AND ASSOCIATED CIRCUITS ARE EXISTING TO REMAIN.
- THE HATCHED AREA IN THE PLAN ABOVE IS OUTSIDE THE
- 4. ALL INTEGRAL AND REMOTE EMERGENCY BATTERY
- WATTSTOPPER SERVES AS THE BASIS OF DESIGN FOR ALL LIGHTING CONTROLS. REFER TO LIGHTING CONTROL DETAILS FOR DEVICE SPECIFICATIONS. WATTSTOPPER IS SPECIFIED AND APPROVED FOR THIS WORK BASED ON COMPATIBILITY WITH CRESTRON AV SYSTEMS. SUBSTITUTION WITH ANOTHER LIGHTING CONTROL MANUFACTURER MUST BE THOROUGHLY REVIEWED AND APPROVED BY THE ELECTRICAL AND AV DESIGNERS, TO ENSURE COMPATIBILITY.

SEAL AND SIGNATURE:



OGS PROJECT NO. SF760

DRAWING TITLE:

LIGHTING 15TH FLOOR PLAN


ISSUE DATE: 12/11/24 PROJECT NO.: 21-048-1165.02 1/8" = 1'-0"

DRAWING NO.: E-201.00


LIGHTING 15TH FLOOR PLAN

E-201 / SCALE: 1/8" - 1' - 0"

			LIGHTING	FIXTU	RE SCHEE	ULE		
SYMBOL	TYPE	MOUNTING	DESCRIPTION	LAMPS	MFR.	FIXT. WATT	DRIVER	REMARKS
	F2-6	RECESSED	6' NEO-RAY DEFINE 4 SERIES RECESSED DIRECT LED LIGHTING FIXTURE TROFFER AS PER ARCHITECT'S SPECIFICATIONS	LED 64.5W	EATON COOPER LIGHTING	64.5W	120V LED DRIVER (0-10V CONTROL)	REFER TO ARCHITECTURAL SPECIFICATIONS FOR DETAILED LUMINAIRE SPECIFICATIONS AND CATALOG NUMBERS.
	F2-8	RECESSED	8' NEO-RAY DEFINE 4 SERIES RECESSED DIRECT LED LIGHTING FIXTURE TROFFER AS PER ARCHITECT'S SPECIFICATIONS	LED 86.0	EATON COOPER LIGHTING	86.0W	120V LED DRIVER (0-10V CONTROL)	REFER TO ARCHITECTURAL SPECIFICATIONS FOR DETAILED LUMINAIRE SPECIFICATIONS AND CATALOG NUMBERS.
•	F6	RECESSED	6" PORTFOLIO LD6A20 SERIES RECESSED ROUND LED DOWNLIGHT WITH CYLINDRICAL GLASS AS PER ARCHITECT'S SPECIFICATIONS	LED 31.5	EATON COOPER LIGHTING	31.5W	120V LED DRIVER (0-10V CONTROL)	REFER TO ARCHITECTURAL SPECIFICATIONS FOR DETAILED LUMINAIRE SPECIFICATIONS AND CATALOG NUMBERS.
	F4	RECESSED	NEO-RAY 79-PF LED PENTAFLEX SERIES RECESSED PERIMETER LED WALLWASHER AS PER ARCHITECT'S SPECIFICATIONS (2,330 LUMENS PER 4-FOOT SECTION)	LED 29W PER 4' SECTION	EATON COOPER LIGHTING	29W PER 4' SECTION	120V LED DRIVER (0-10V CONTROL)	REFER TO ARCHITECTURAL SPECIFICATIONS FOR DETAILED LUMINAIRE SPECIFICATIONS AND CATALOG NUMBERS.
℟	EX	AS REQUIRED	EDGE-LIT EXIT SIGN WITH 8" HIGH RED LETTERS AND NI-CAD BATTERY AS PER ARCHITECT'S SPECIFICATIONS. NUMBER OF FACES AND DIRECTIONAL ARROWS AS SHOWN ON ARCHITECT'S DRAWINGS.	LED 3W	LITHONIA LIGHTING	3W	120V LED DRIVER	REFER TO ARCHITECTURAL SPECIFICATIONS FOR DETAILED LUMINAIRE SPECIFICATIONS AND CATALOG NUMBERS.

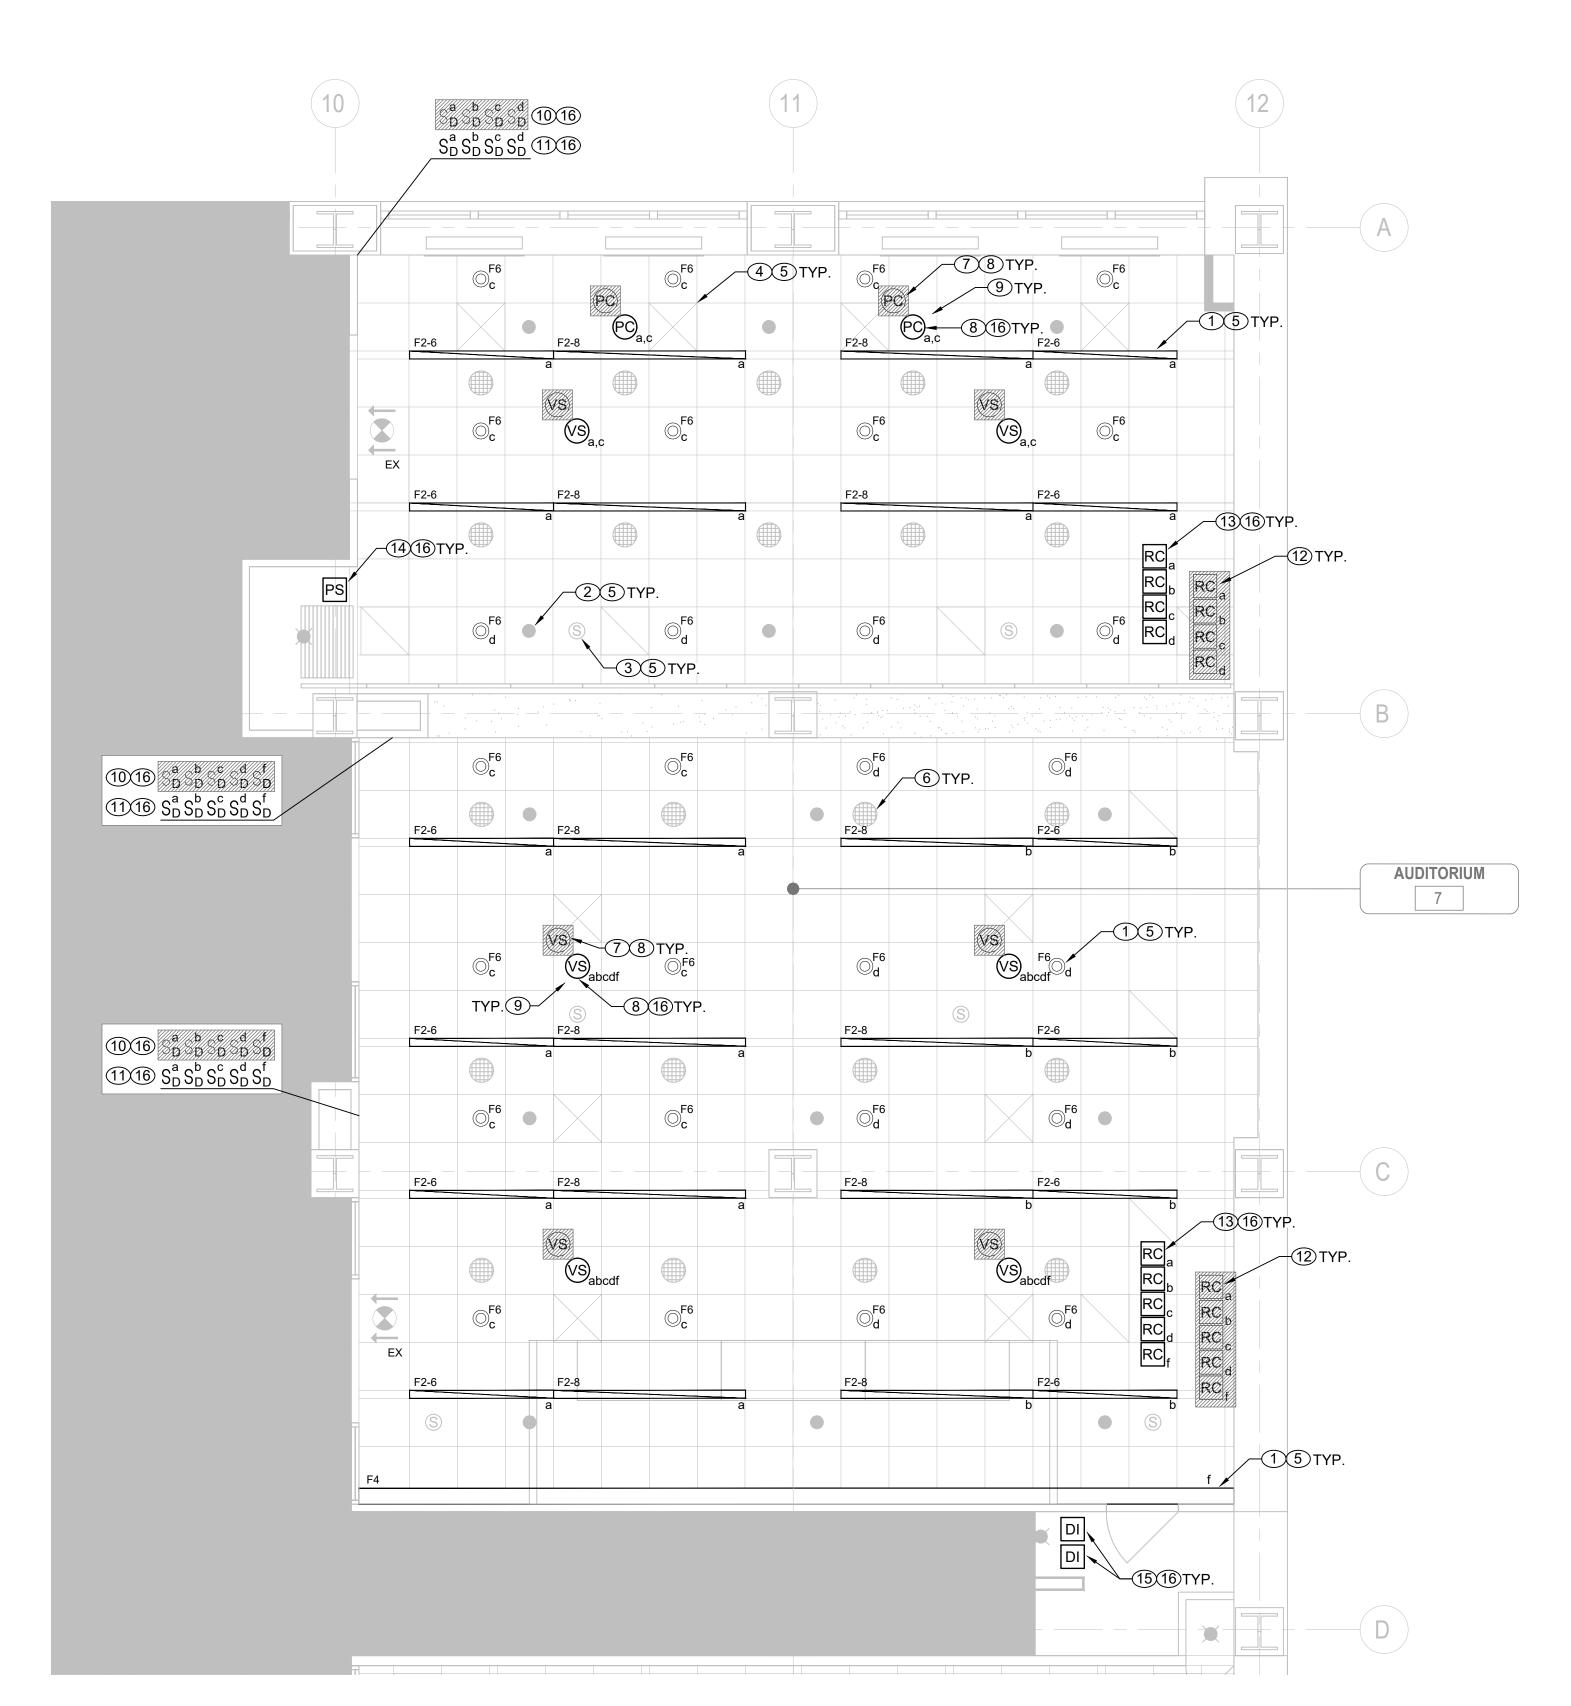

LIGHTING 15TH FLOOR PARTIAL PLAN - AUDITORIUM E-202 / SCALE: 1/4" - 1' - 0"

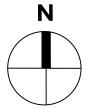

LIGHTING CONTROL KEYNOTES:

- 1 ALL LIGHT FIXTURES, ASSOCIATED 120V POWER CIRCUITS, AND 0-10V DIMMING CONTROL WIRING BETWEEN LIGHT FIXTURES AND ROOM CONTROLLERS ARE EXISTING TO
- 2 ALL SPRINKLER HEADS AND SPRINKLER PIPING ARE EXISTING TO REMAIN.
- 3 ALL SMOKE DETECTORS AND FIRE ALARM WIRING ARE EXISTING TO REMAIN.
- 4 ALL CEILING DIFFUSERS AND DUCT WORK ARE EXISTING TO REMAIN.
- 5 FOR ALL ITEMS LISTED AS EXISTING TO REMAIN, THE CONTRACTOR SHALL TAKE ALL NECESSARY MEASURES TO PROTECT THESE ITEMS FROM DAMAGE AND DEBRIS DURING THE REPLACEMENT OF LIGHTING CONTROLS.
- (6) REFER TO AV DRAWINGS FOR ALL SCOPE RELATED TO REPLACEMENT OF EQUIPMENT, INCLUDING SPEAKERS, CAMERAS, AND PROJECTORS.
- 7) DISCONNECT LOW VOLTAGE CONTROL WIRING FROM EXISTING CEILING MOUNTED SENSOR, PULL BACK TO ROOM CONTROLLER, AND REMOVE.
- 8 EXISTING CEILING MOUNTED SENSORS TO BE REMOVED AND REPLACED WITH NEW IN SAME LOCATIONS. REFER TO LEGEND AND LIGHTING CONTROL DETAILS FOR DEVICE SPECIFICATIONS.

- 9) IF NECESSARY, PROVIDE AND INSTALL REPLACEMENT CEILING TILE FOR CEILING MOUNTED DEVICE. COORDINATE WITH MANAGEMENT TO MATCH EXISTING CEILING TILES.
- (10) REMOVE EXISTING WALL MOUNTED DIMMERS AND DEMOLISH LOW VOLTAGE WIRING BACK TO ROOM CONTROLLER. PULL DRAGWIRE THROUGH EXISTING RACEWAY TO ROOM CONTROLLER LOCATION FOR FUTURE
- (11) INSTALL NEW LOW VOLTAGE DIMMERS AT EXISTING LOCATIONS. REFER TO LEGEND AND LIGHTING CONTROL DETAILS FOR DEVICE SPECIFICATIONS. UTILIZE EXISTING BACKBOXES AND CONDUIT. PULL NEW NETWORK CABLE TO LOCATION OF NEW ROOM CONTROLLER. PROVIDE NEW FACEPLATES.
- (12) DISCONNECT AND REMOVE EXISTING ROOM CONTROLLERS. LOCATION SHOWN IS APPROXIMATE. CONTRACTOR SHALL VERIFY LOCATIONS IN FIELD. CAP EXISTING 120V LIGHTING POWER CIRCUITS AND 0-10V DIMMING CONTROL WIRING FOR FUTURE USE. LABEL THE DISCONNECTED DIMMING CONTROL WIRES WITH THEIR CORRESPONDING ZONE TAGS.
- (13) INSTALL NEW ROOM CONTROLLERS TO REPLACE THE REMOVED UNITS, AT SAME LOCATION. REFER TO LEGEND AND LIGHTING CONTROL DETAILS FOR DEVICE SPECIFICATIONS. RE-CONNECT ROOM CONTROLLERS TO EXISTING 120V LIGHTING CIRCUITS AND 0-10V DIMMING CONTROL WIRING.

- (14) INSTALL PARTITION SENSORS AND ALL REQUIRED ACCESSORIES AND INTERFACE DEVICES TO ENSURE POSITION OF SLIDING PARTITION IS INTEGRATED WITH THE NEW LIGHTING CONTROLS. REFER TO LIGHTING CONTROL DETAILS FOR SCOPE OF PARTITION SENSOR SYSTEM.
- (15) INSTALL NETWORK INTERFACE DEVICES TO CONNECT NEW LIGHTING CONTROLS WITH NEW AV SERVER. UTILIZE EXISTING STUBS BETWEEN AUDITORIUM AND STORAGE/AV ROOM TO ROUTE NETWORK CABLES. COORDINATE WITH AV SYSTEM VENDOR TO ENSURE LIGHTING CONTROLS

ARE INTEGRATED WITH AV TOUCHSCREEN DEVICES.

(16) INSTALL NEW CABLES BETWEEN ALL NEW NETWORKED LIGHTING CONTROL DEVICES TO ACHIEVE LIGHTING CONTROL INTENT. REFER TO LIGHTING CONTROL DETAILS FOR CABLE REQUIREMENTS. PROVIDE AND INSTALL J-HOOKS AND SUPPORTS FOR CABLES AND ROUTE IN DROP CEILING. COORDINATE ROUTING WITH EXISTING CONDITIONS.



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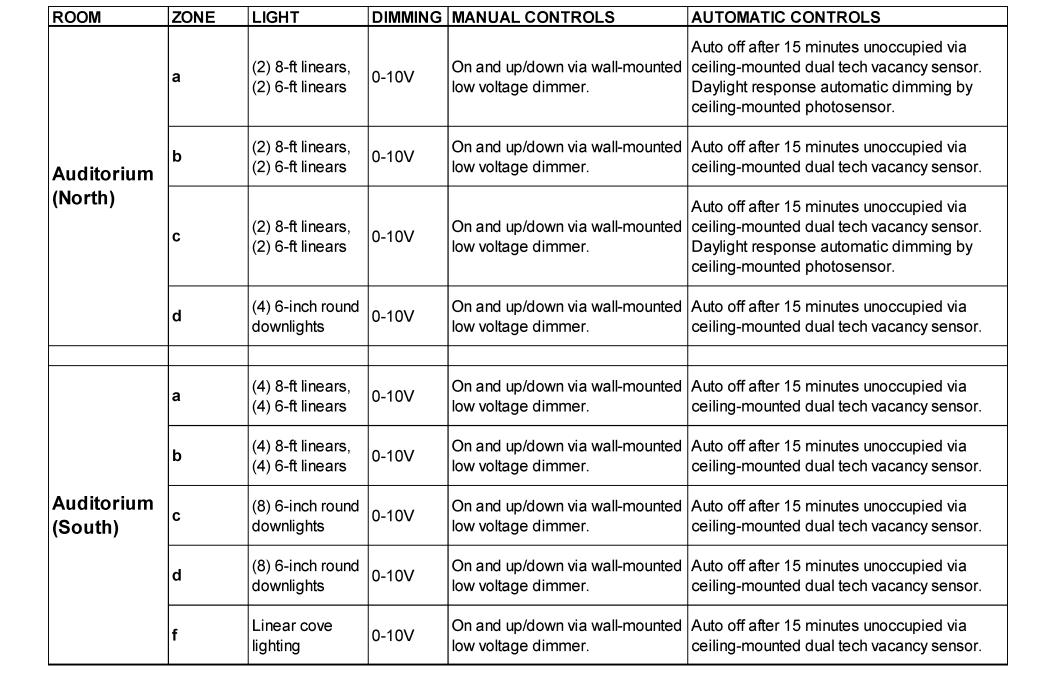
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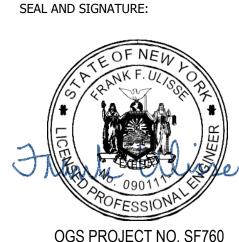
KEY PLAN:

DESCRIPTION:



LIGHTING CONTROL NARRATIVE - AUDITORIUM

E-202 / SCALE: N.T.S.




OGS PROJECT NO. SF760

DRAWING TITLE:

LIGHTING 15TH FLOOR PARTIAL PLAN **AUDITORIUM**


ISSUE DATE:	
12/11/24	
PROJECT NO.:	SCALE:
21-048-1165.02	1/4" = 1'-0"
DRAWING NO.:	

E-202.00

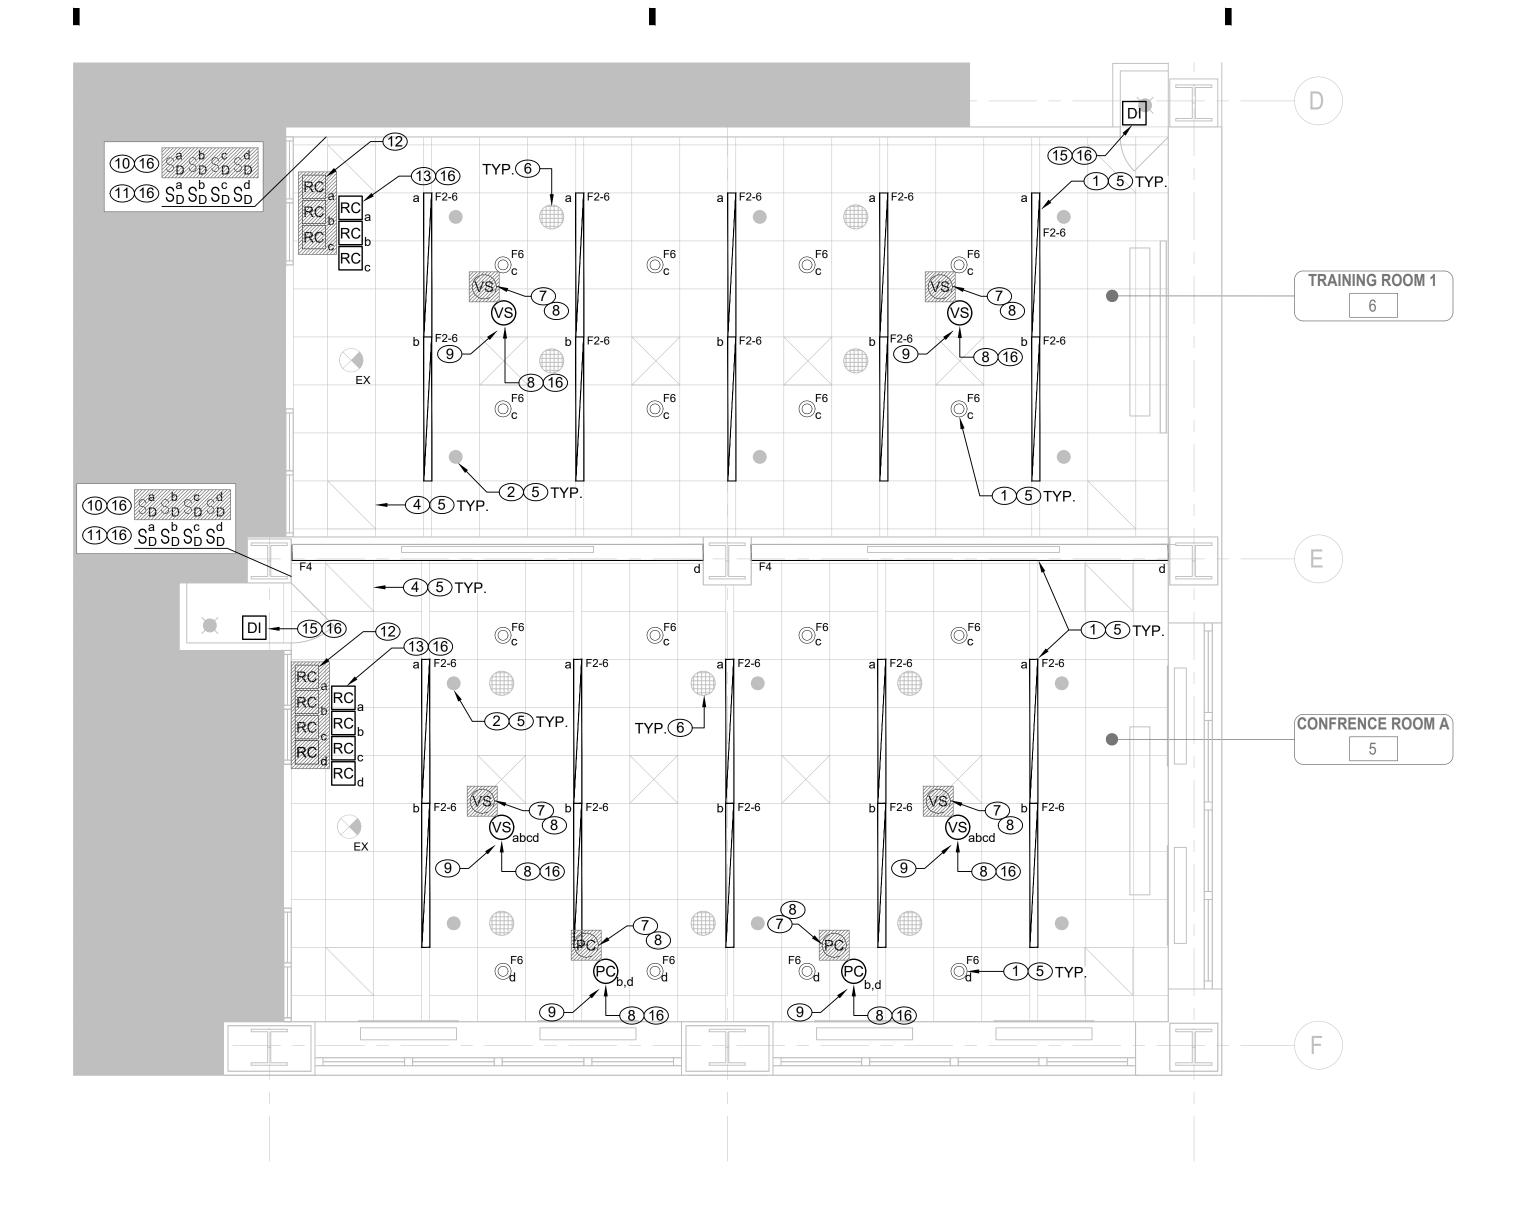

LIGHTING 15TH FLOOR PARTIAL PLAN - SOUTHEAST

E-203 / SCALE: 1/4" - 1' - 0"

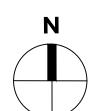

LIGHTING CONTROL KEYNOTES:

- 1) ALL LIGHT FIXTURES, ASSOCIATED 120V POWER CIRCUITS, 9) IF NECESSARY, PROVIDE AND INSTALL REPLACEMENT AND 0-10V DIMMING CONTROL WIRING BETWEEN LIGHT FIXTURES AND ROOM CONTROLLERS ARE EXISTING TO
- 2 ALL SPRINKLER HEADS AND SPRINKLER PIPING ARE EXISTING TO REMAIN.
- (NOT USED)
- 4 ALL CEILING DIFFUSERS AND DUCT WORK ARE EXISTING TO REMAIN.
- 5 FOR ALL ITEMS LISTED AS EXISTING TO REMAIN, THE CONTRACTOR SHALL TAKE ALL NECESSARY MEASURES TO PROTECT THESE ITEMS FROM DAMAGE AND DEBRIS DURING THE REPLACEMENT OF LIGHTING CONTROLS.
- (6) REFER TO AV DRAWINGS FOR ALL SCOPE RELATED TO REPLACEMENT OF EQUIPMENT, INCLUDING SPEAKERS, CAMERAS, AND PROJECTORS.
- 7 DISCONNECT LOW VOLTAGE CONTROL WIRING FROM EXISTING CEILING MOUNTED SENSOR, PULL BACK TO ROOM CONTROLLER, AND REMOVE.
- (8) EXISTING CEILING MOUNTED SENSORS TO BE REMOVED AND REPLACED WITH NEW IN SAME LOCATIONS. REFER TO LEGEND AND LIGHTING CONTROL DETAILS FOR DEVICE SPECIFICATIONS.

ZONE LIGHT

- CEILING TILE FOR CEILING MOUNTED DEVICE. COORDINATE WITH MANAGEMENT TO MATCH EXISTING CEILING TILES.
- (10) REMOVE EXISTING WALL MOUNTED DIMMERS AND DEMOLISH LOW VOLTAGE WIRING BACK TO ROOM CONTROLLER. PULL DRAGWIRE THROUGH EXISTING RACEWAY TO ROOM CONTROLLER LOCATION FOR FUTURE
- 11) INSTALL NEW LOW VOLTAGE DIMMERS AT EXISTING LOCATIONS. REFER TO LEGEND AND LIGHTING CONTROL DETAILS FOR DEVICE SPECIFICATIONS. UTILIZE EXISTING BACKBOXES AND CONDUIT. PULL NEW NETWORK CABLE TO LOCATION OF NEW ROOM CONTROLLER. PROVIDE NEW FACEPLATES.
- (12) DISCONNECT AND REMOVE EXISTING ROOM CONTROLLERS. LOCATION SHOWN IS APPROXIMATE. CONTRACTOR SHALL VERIFY LOCATIONS IN FIELD. CAP EXISTING 120V LIGHTING POWER CIRCUITS AND 0-10V DIMMING CONTROL WIRING FOR FUTURE USE. LABEL THE DISCONNECTED DIMMING CONTROL WIRES WITH THEIR CORRESPONDING ZONE TAGS.
- (13) INSTALL NEW ROOM CONTROLLERS TO REPLACE THE REMOVED UNITS, AT SAME LOCATION. REFER TO LEGEND AND LIGHTING CONTROL DETAILS FOR DEVICE SPECIFICATIONS. RE-CONNECT ROOM CONTROLLERS TO EXISTING 120V LIGHTING CIRCUITS AND 0-10V DIMMING CONTROL WIRING.

DIMMING MANUAL CONTROLS

- (14) (NOT USED)
- (NOT USED)

AUTOMATIC CONTROLS

(16) INSTALL NEW CABLES BETWEEN ALL NEW NETWORKED LIGHTING CONTROL DEVICES TO ACHIEVE LIGHTING CONTROL INTENT. REFER TO LIGHTING CONTROL DETAILS FOR CABLE REQUIREMENTS. PROVIDE AND INSTALL J-HOOKS AND SUPPORTS FOR CABLES AND ROUTE IN DROP CEILING. COORDINATE ROUTING WITH EXISTING CONDITIONS.



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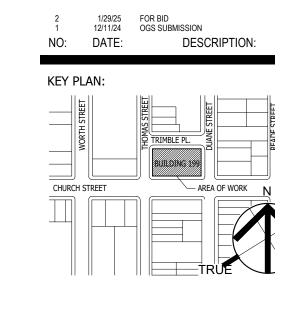
CONSULTANT:



Training Room 1	а	(6) 6-ft linears	0-101/	•	Auto off after 15 minutes unoccupied via ceiling-mounted dual tech vacancy sensor.
	b	(4) 6-ft linears	U=TUV I	-	Auto off after 15 minutes unoccupied via ceiling-mounted dual tech vacancy sensor.
	C	(8) 6-inch round downlights	0-100	•	Auto off after 15 minutes unoccupied via ceiling-mounted dual tech vacancy sensor.

ROOM	ZONE	LIGHT	DIMMING	MANUAL CONTROLS	AUTOMATIC CONTROLS
	а	(5) 6-ft linears	0-10V	On and up/down via wall-mounted low voltage dimmer.	Auto off after 15 minutes unoccupied via ceiling-mounted dual tech vacancy sensor.
	b	(5) 6-ft linears	0-10V	On and up/down via wall-mounted low voltage dimmer.	Auto off after 15 minutes unoccupied via ceiling-mounted dual tech vacancy sensor. Daylight response automatic dimming by ceiling-mounted photosensor.
Conf Room A	С	(4) 6-inch round downlights	0-10V	On and up/down via wall-mounted low voltage dimmer.	Auto off after 15 minutes unoccupied via ceiling-mounted dual tech vacancy sensor.
	d	(4) 6-inch round downlights	0-10V	On and up/down via wall-mounted low voltage dimmer.	Auto off after 15 minutes unoccupied via ceiling-mounted dual tech vacancy sensor. Daylight response automatic dimming by ceiling-mounted photosensor.
	е	Linear cove	0-10V	On and up/down via wall-mounted low voltage dimmer.	Auto off after 15 minutes unoccupied via ceiling-mounted dual tech vacancy sensor.





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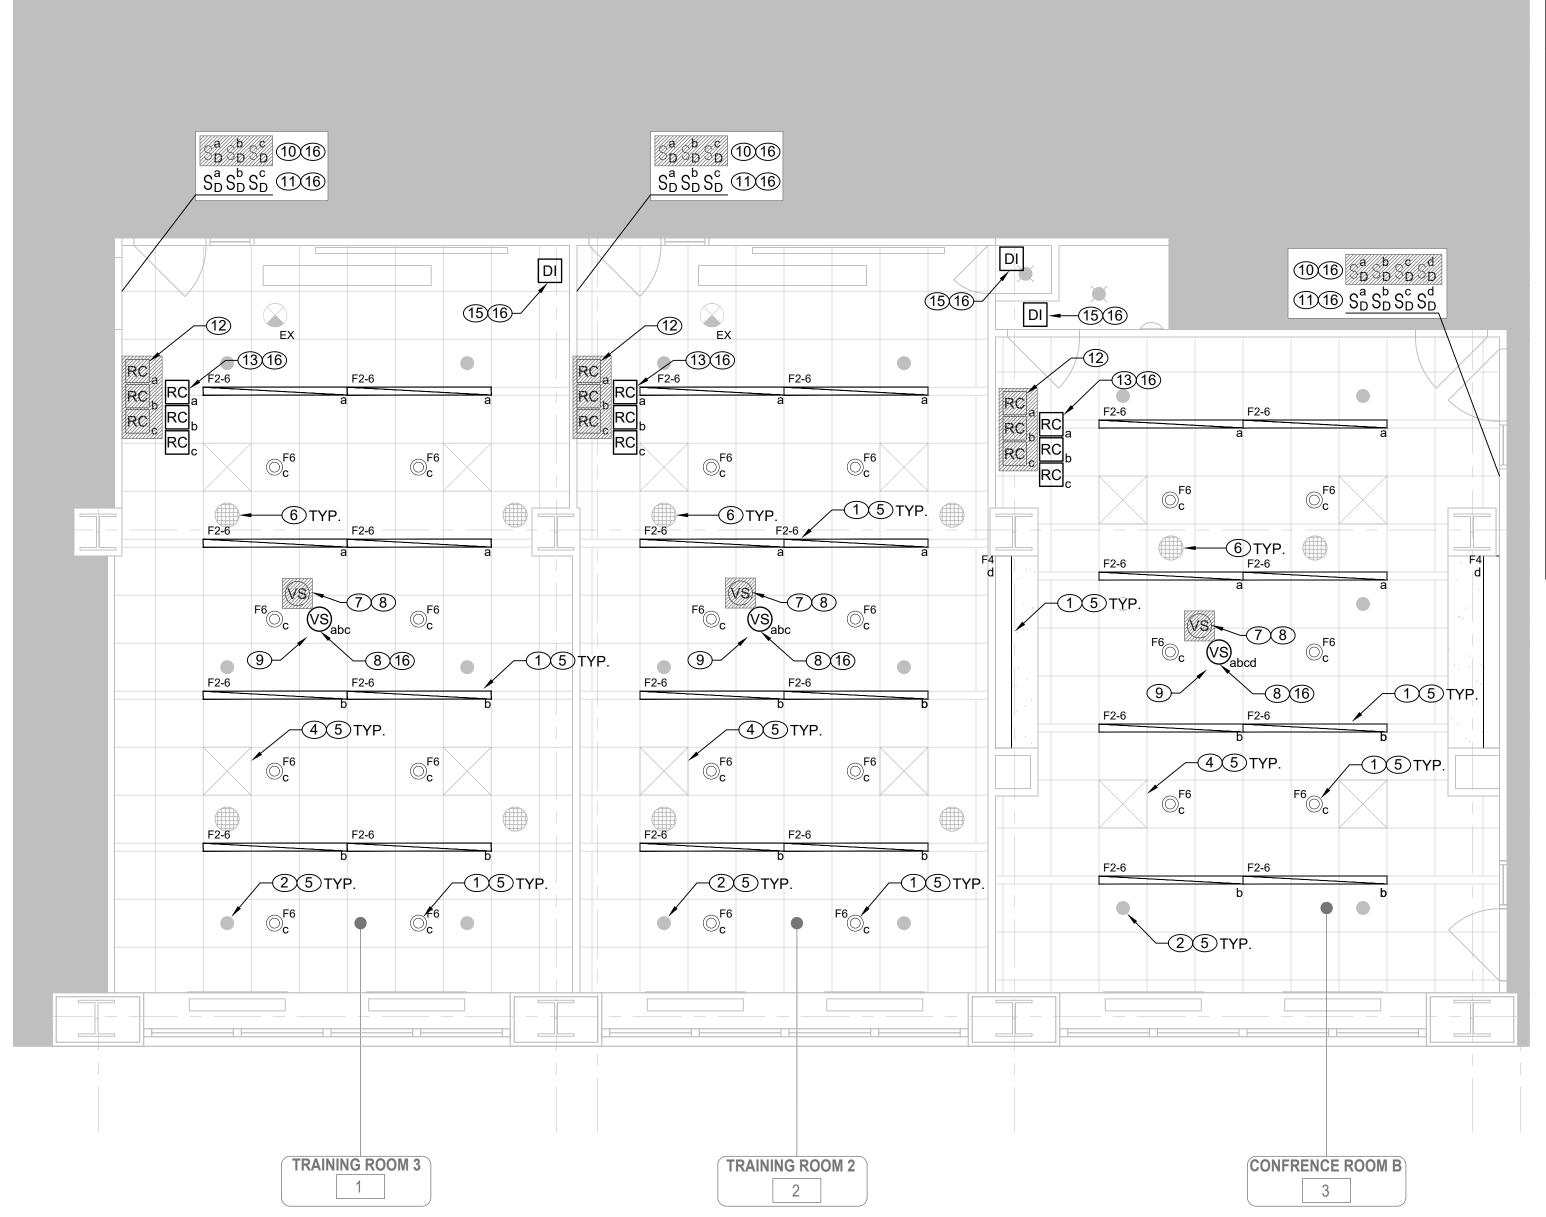


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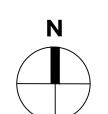
LIGHTING 15TH FLOOR PARTIAL PLAN -SOUTHEAST

12/11/24 21-048-1165.02 1/4" = 1'-0" DRAWING NO.:

E-203.00



ELECTRICAL 15TH FLOOR PARTIAL POWER PLAN - SOUTH E-204 / SCALE: 1/4" - 1' - 0"



LIGHTING CONTROL KEYNOTES:

- 1 ALL LIGHT FIXTURES, ASSOCIATED 120V POWER CIRCUITS, 9 IF NECESSARY, PROVIDE AND INSTALL REPLACEMENT AND 0-10V DIMMING CONTROL WIRING BETWEEN LIGHT FIXTURES AND ROOM CONTROLLERS ARE EXISTING TO
- 2 ALL SPRINKLER HEADS AND SPRINKLER PIPING ARE EXISTING TO REMAIN.
- (NOT USED)
- 4 ALL CEILING DIFFUSERS AND DUCT WORK ARE EXISTING TO REMAIN.
- 5 FOR ALL ITEMS LISTED AS EXISTING TO REMAIN, THE CONTRACTOR SHALL TAKE ALL NECESSARY MEASURES TO PROTECT THESE ITEMS FROM DAMAGE AND DEBRIS DURING THE REPLACEMENT OF LIGHTING CONTROLS.
- (6) REFER TO AV DRAWINGS FOR ALL SCOPE RELATED TO REPLACEMENT OF EQUIPMENT, INCLUDING SPEAKERS, CAMERAS, AND PROJECTORS.
- 7 DISCONNECT LOW VOLTAGE CONTROL WIRING FROM EXISTING CEILING MOUNTED SENSOR, PULL BACK TO ROOM CONTROLLER, AND REMOVE.
- 8 EXISTING CEILING MOUNTED SENSORS TO BE REMOVED AND REPLACED WITH NEW IN SAME LOCATIONS. REFER TO LEGEND AND LIGHTING CONTROL DETAILS FOR DEVICE SPECIFICATIONS.

- CEILING TILE FOR CEILING MOUNTED DEVICE. COORDINATE WITH MANAGEMENT TO MATCH EXISTING CEILING TILES.
- (10) REMOVE EXISTING WALL MOUNTED DIMMERS AND DEMOLISH LOW VOLTAGE WIRING BACK TO ROOM CONTROLLER. PULL DRAGWIRE THROUGH EXISTING RACEWAY TO ROOM CONTROLLER LOCATION FOR FUTURE
- (11) INSTALL NEW LOW VOLTAGE DIMMERS AT EXISTING LOCATIONS. REFER TO LEGEND AND LIGHTING CONTROL DETAILS FOR DEVICE SPECIFICATIONS. UTILIZE EXISTING BACKBOXES AND CONDUIT. PULL NEW NETWORK CABLE TO LOCATION OF NEW ROOM CONTROLLER. PROVIDE NEW FACEPLATES.
- CONTROLLERS. LOCATION SHOWN IS APPROXIMATE. CONTRACTOR SHALL VERIFY LOCATIONS IN FIELD. CAP EXISTING 120V LIGHTING POWER CIRCUITS AND 0-10V DIMMING CONTROL WIRING FOR FUTURE USE. LABEL THE DISCONNECTED DIMMING CONTROL WIRES WITH THEIR CORRESPONDING ZONE TAGS. (13) INSTALL NEW ROOM CONTROLLERS TO REPLACE THE

REMOVED UNITS, AT SAME LOCATION. REFER TO LEGEND

SPECIFICATIONS. RE-CONNECT ROOM CONTROLLERS TO EXISTING 120V LIGHTING CIRCUITS AND 0-10V DIMMING

AND LIGHTING CONTROL DETAILS FOR DEVICE

CONTROL WIRING.

- (12) DISCONNECT AND REMOVE EXISTING ROOM
- (14) (NOT USED)
- (NOT USED)
- (16) INSTALL NEW CABLES BETWEEN ALL NEW NETWORKED LIGHTING CONTROL DEVICES TO ACHIEVE LIGHTING CONTROL INTENT. REFER TO LIGHTING CONTROL DETAILS FOR CABLE REQUIREMENTS. PROVIDE AND INSTALL J-HOOKS AND SUPPORTS FOR CABLES AND ROUTE IN DROP CEILING. COORDINATE ROUTING WITH EXISTING CONDITIONS.



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199 Church Street, New York,

NYSIF-AV 15th Floor Upgrades



■ NEW YORK CITY 28TH FLOOR NEW YORK, NY 10004 212-563-0280 [P] 212-563-1841 [F]

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CONSULTANT:




ROOM	ZONE	LIGHT	DIMMING	MANUAL CONTROLS	AUTOMATIC CONTROLS
Training Room 2	а	(4) 6-ft linears	0-10V	·	Auto off after 15 minutes unoccupied via ceiling-mounted dual tech vacancy sensor.
	b	(4) 6-ft linears	0-10V	On and up/down via wall-mounted low voltage dimmer.	Auto off after 15 minutes unoccupied via ceiling-mounted dual tech vacancy sensor.
	С	(8) 6-inch round downlights	0-10V	On and up/down via wall-mounted low voltage dimmer.	Auto off after 15 minutes unoccupied via ceiling-mounted dual tech vacancy sensor.

ROOM	ZONE	LIGHT	DIMMING	MANUAL CONTROLS AUTOMATIC CONTROLS	
Training Room 3	а	(4) 6-ft linears	0-10V	On and up/down via wall-mounted low voltage dimmer.	Auto off after 15 minutes unoccupied via ceiling-mounted dual tech vacancy sensor.
	b	(4) 6-ft linears	0-10V	On and up/down via wall-mounted low voltage dimmer.	Auto off after 15 minutes unoccupied via ceiling-mounted dual tech vacancy sensor.
	С	(8) 6-inch round downlights	0-10V	On and up/down via wall-mounted low voltage dimmer.	Auto off after 15 minutes unoccupied via ceiling-mounted dual tech vacancy sensor.

ROOM	ZONE	LIGHT	DIMMING	MANUAL CONTROLS	AUTOMATIC CONTROLS
Conf Room B	а	(4) 6-ft linears	0-10V	On and up/down via wall-mounted low voltage dimmer.	Auto off after 15 minutes unoccupied via ceiling-mounted dual tech vacancy sensor.
	b	(4) 6-ft linears	0-10V	On and up/down via wall-mounted low voltage dimmer.	Auto off after 15 minutes unoccupied via ceiling-mounted dual tech vacancy sensor.
	С	(6) 6-inch round downlights	0-10V	On and up/down via wall-mounted low voltage dimmer.	Auto off after 15 minutes unoccupied via ceiling-mounted dual tech vacancy sensor.
	d	Linear cove lighting	0-10V	On and up/down via wall-mounted low voltage dimmer.	Auto off after 15 minutes unoccupied via ceiling-mounted dual tech vacancy sensor.

LIGHTING CONTROL NARRATIVE - TRAINING ROOM 2,3, CONF ROOM B E-204 / SCALE: N.T.S.

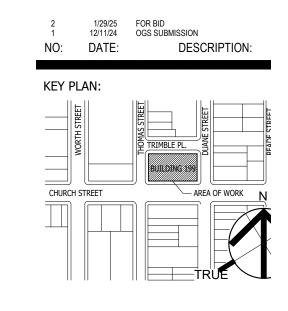

SEAL AND SIGNATURE:




DRAWING TITLE:

LIGHTING 15TH FLOOR PARTIAL PLAN


21-048-1165.02 1/4" = 1'-0" DRAWING NO.:

E-204.00

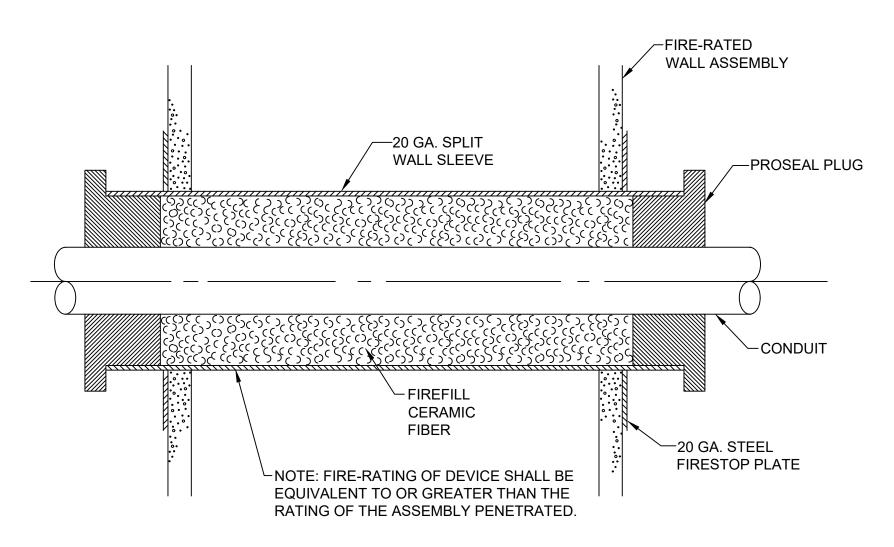

CONDUIT THROUGH FIRE RATED WALL DETAIL

E-301 SCALE: NOT TO SCALE

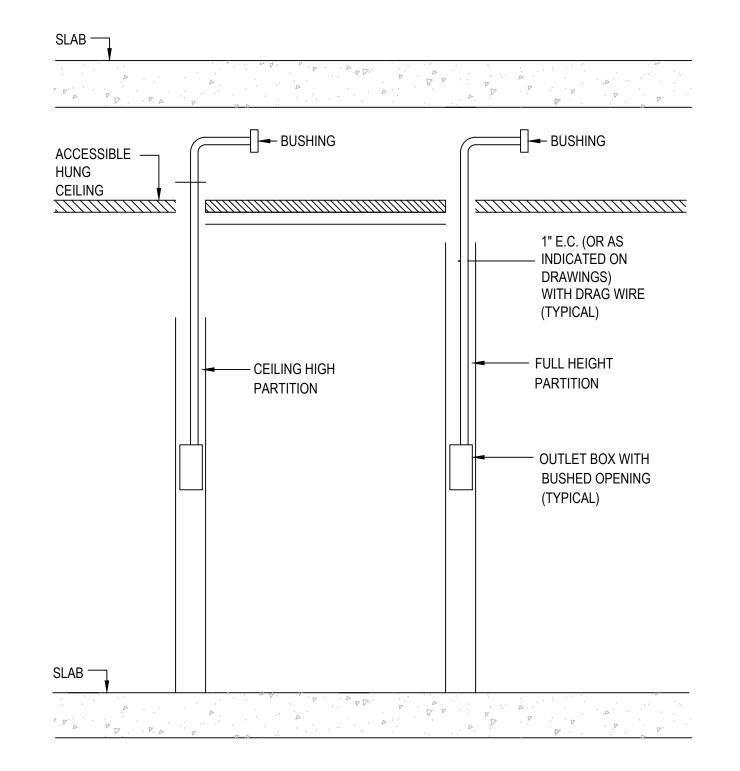

TYPICAL EMPTY STUB-UPS FOR AND DATA OUTLETS

E-301 SCALE: NOT TO SCALE



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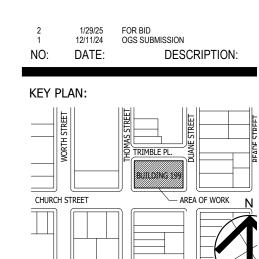




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DRAWING TITLE:
ELECTRICAL DETAILS

•	ISSUE DATE:	
	12/11/24	
	PROJECT NO.:	SCALE:
	21-048-1165.02	N. T. S.
•	DRAWING NO.:	


E-301.00

PROJECT LOCATION:

DLM RULES & BEST PRACTICES

DLM INSIDE THE ROOM

- Always power Room Controllers with a constant hot (unswitched) circuit.
- Use WS LMRJ-xx Cat 5e cables for reliable communication.
- No more than 4 total 100 series room controllers (RCs) LMRC-10x / LMPL-101 / LMPB-100 on a DLM Cat 5e Room Network (aka IRB "In Room Bus"). Other DLM RCs and LMCPs have smart power supplies, so you can have a DLM max of 64 loads or 48 devices. (IRBs with only 100 series RCs have a max of 24 devices and 8 loads.)
- Check total mA consumption of DLM devices against total current available from all LMRCs, LMCPs & LMZCs on the Cat 5e network to a max of 800mA. LMRC-10x / LMPL-100 / LMPB-100 will not limit their 150mA current which is why their 4 unit max. Other LMRCs, LMCPs & LMZCs will limit their current on Cat 5e room network to ≤ 800mA.
- Don't overload rooms: DLM allows 150' Cat 5e (free topology) per intelligent DLM device, to a max of 1,000' per IRB. Suggest rooms have < 32 loads (and never more than 4 total 100 series RCs and < 24 DLM devices unless reviewed
- 2 & 3 Relay Room Controllers are for multi-level lighting or multiple zones inside a room, not multiple rooms. • Rooms ideally should have only one "occupancy state". Multiple occupancy zones in a room are possible, but makes setup more challenging.
- LMLS units require another DLM device (LMCP, OS, etc...) to set initial On state, else set Load to "Auto On" in

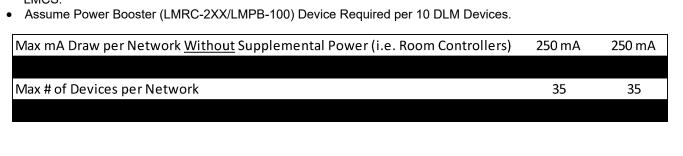

DLM NETWORKING (via MS/TP or "Segment Wire")

- ONLY USE WS LM-MSTP CABLE for DLM Networking.
- Only one Network Bridge per room. LMCPs and LMZCs have this device on their LMPI intelligence card.
- Do not run LM-MSTP to multiple floors (except for LMCP panel only runs). Locate LMSM-3E or a NB-ROUTER at start of all LM-MSTP runs on a network project, and ONLY ground shield there. MS/TP wire cannot exceed 4,000' and must be run in daisy chain topology to all rooms/panels. Pay close attention on how LM-MSTP connects to DLM networking devices and where terminating resistors are required (see device installation instructions and TB-179.2).
- WS Networks are defined and limited as follows: BASIC: LMSM-3E with up to 3 LM-MSTP segment runs. Each segment limited to max 40 Rooms / 250 DLM devices. Integration only via LMSM Export Table.
 - ADVANCED: LMSM-6E with NB-ROUTERs and an NB-SWITCH (can connect to max 250 Rooms / 1000 DLM devices). Integration other than via Export Table is Advanced. Advanced requires WS PM review!

DLM LMCP RELAY PANEL

- Panels are basically large RCs, but DO NOT connect multiple panels with Cat 5e wire use Network Bridges. Each LMCP Panel provides 2 separate Cat 5e IRB networks, each allowing max 47 DLM devices. Max loads for all
- relays in panel and in RCs stays max 64.
- Panels use below equivalency table when connecting to a LMSM (to calculate allowed segment room/device limits):
 - LMZC-301 panel = 1 processors / 10 devices
 - LMCP-8 panel = 3 processors / 20 devices LMCP-24 panel = 5 processors/ 30 devices
 - LMCP-48 panel = 7 processors/ 40 devices

DIMMING COMPATIBILITY:


Contractor shall coordinate and confirm dimming compatibility of all lighting controls devices with final approved lighting fixture submittal documents. SLS shall not be held responsible for compatibility issues if not provided with all applicable approved documentation.

Prior to purchase and install, contractor shall coordinate and confirm an exact match between the led array, driver and controls devices. SLS cannot guarantee compatibility or performance prior to dimming type confirmation.


Prior to purchase and install, coordinate with system manufacturer for confirmation of compatibility and any required testing that may be required.a testing request with system manufacturer may be required.

CONTRACTORS TO CONTACT ELECTRICAL DISTRIBUTORS FOR LIGHTING CONTROL SYSTEM QUOTATION / PRICING. ALL OTHER LIGHTING CONTROL SYSTEM INQUIRIES TO BE DIRECTED TOWARD PATRICK CLARKE (PCLARKE@SLSLTG.COM) AT SLS CONTROLS.


NOTE: WATTSTOPPER SERVES AS THE BASIS OF DESIGN FOR ALL LIGHTING CONTROLS. REFER TO LIGHTING CONTROL DETAILS FOR DEVICE SPECIFICATIONS. WATTSTOPPER IS SPECIFIED AND APPROVED FOR THIS WORK BASED ON COMPATIBILITY WITH CRESTRON AV SYSTEMS. SUBSTITUTION WITH ANOTHER LIGHTING CONTROL MANUFACTURER MUST BE THOROUGHLY REVIEWED AND APPROVED BY THE ELECTRICAL AND AV DESIGNERS, TO ENSURE COMPATIBILITY.

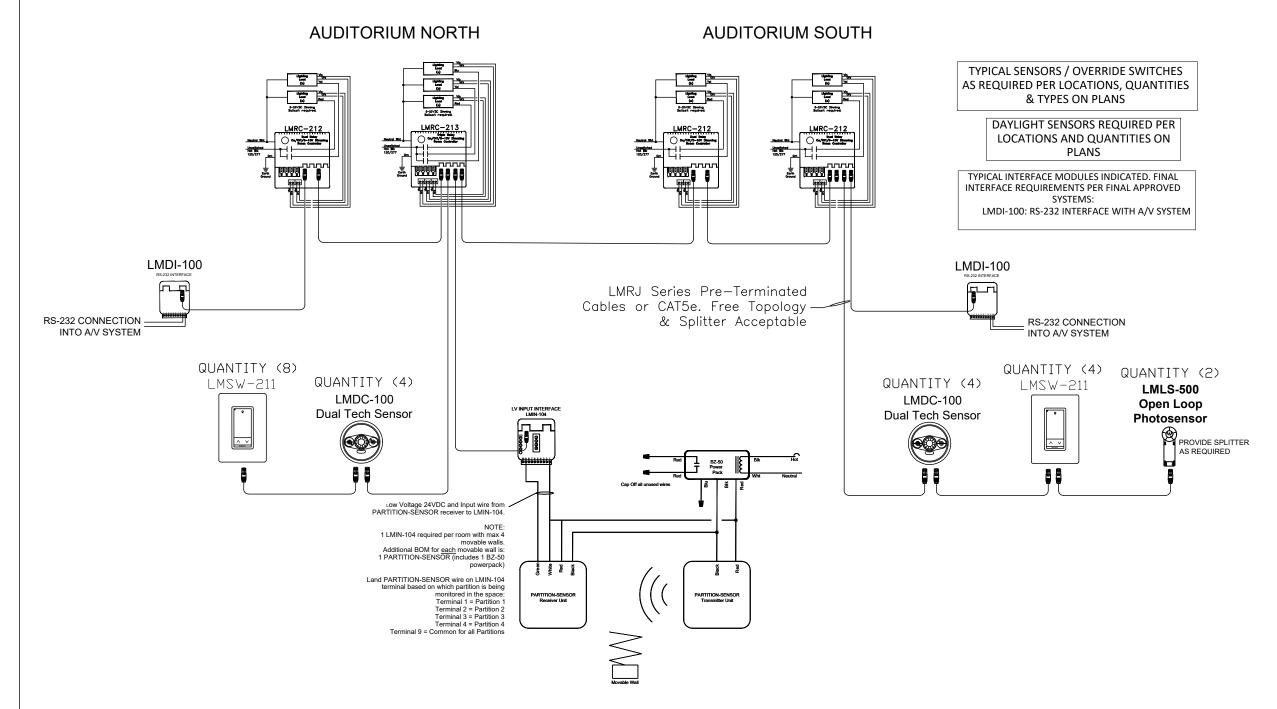


AUDITORIUM A, ZONES: a, b, c, d AUDITORIUM B, ZONES: a, b, c, d

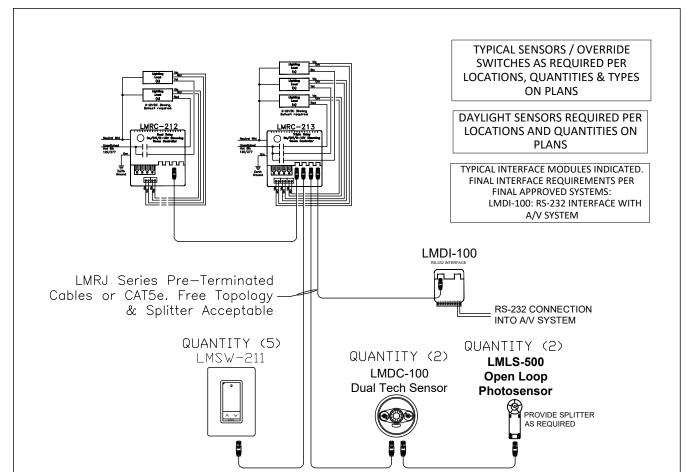

CONFERENCE ROOM A, ZONES: a, b, c, d, e

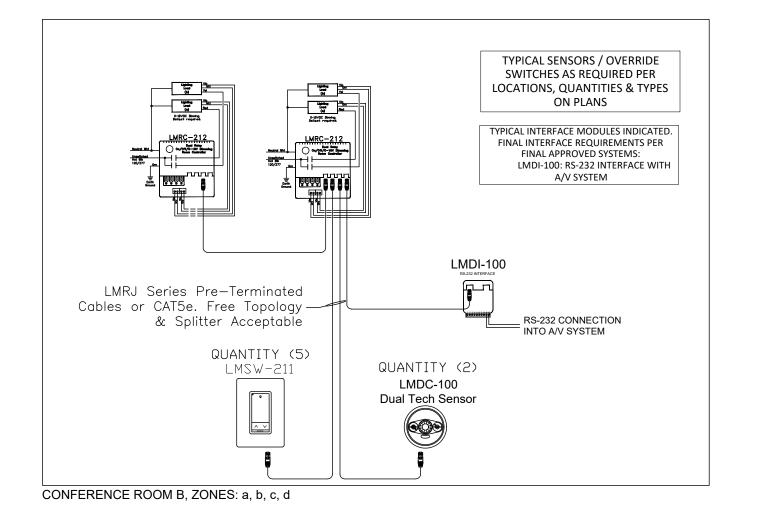

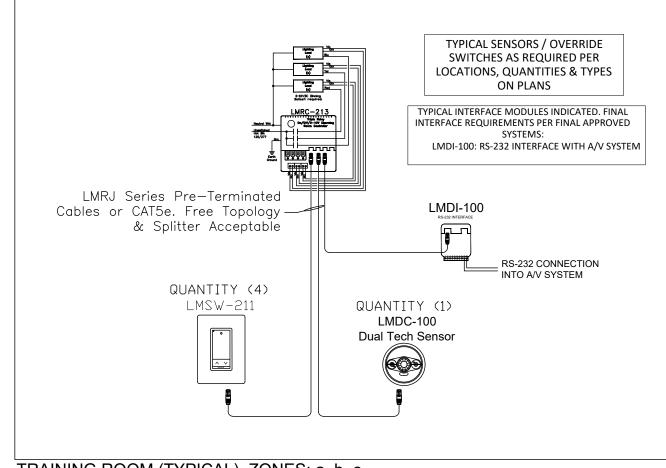

TRAINING ROOM (TYPICAL), ZONES: a, b, c



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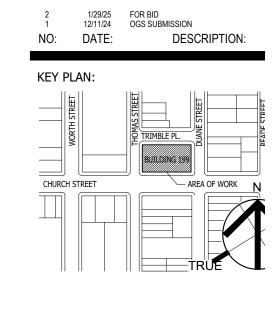




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SEAL AND SIGNATURE:



DRAWING TITLE:

LIGHTING CONTROL DETAILS

ISSUE DATE:	
12/11/24	
PROJECT NO.:	SCALE:
21-048-1165.02	N. T. S.
DRAWING NO.:	

E-302.00

LIGHTING CONTROL DETAILS AND SPECIFICATIONS

E-302 / SCALE: N.T.S.

DRAWING I	LIST:	ABBREVI	IATIONS:	■ GEN	ERAL NOTES:	
NUMBER		7.331.21.				
TA.000	AUDIOVISUAL TITLE SHEET	A AC	AMPERES ABOVE COUNTER		DRAWINGS AND AS	
TA.001 TA.115	AUDIOVISUAL SCHEDULES AUDIOVISUAL OVERALL PLAN - LEVEL 15	AFC AFF	AT FINISHED CEILING ABOVE FINISHED FLOOR	'	POWER AND DATA WITH ELECTRICAL I	ENGINEE
TA.215 TA.400	AUDIOVISUAL OVERALL RCP - LEVEL 15 AUDIOVISUAL SECTIONS & ELEVATIONS	AFP AS	ABOVE FINISHED PLATFORM OR RAISED FLOOR ABOVE SLAB		THIS DRAWING SET	
TA.400 TA.401	AUDIOVISUAL SECTIONS & ELEVATIONS AUDIOVISUAL SECTIONS & ELEVATIONS	ATS AV	ABOVE TABLE SURFACE AUDIOVISUAL		WHERE POWER CIF SHALL BE TAPED AI	
TA.500 TA.700	AUDIOVISUAL RISERS AUDIOVISUAL SYSTEM DIAGRAMS	AWG	AMERICAN WIRE GAGE		INSTALLATION OF T	
TA.701 TA.702	AUDIOVISUAL SYSTEM DIAGRAMS AUDIOVISUAL SYSTEM DIAGRAMS	C CAT-3	CONDUIT TIA/EIA CATEGORY 3 RATED		EMPTY CONDUIT RI EXACT PATH OF CO	ONDUIT I
TA.703	AUDIOVISUAL SYSTEM DIAGRAMS	CAT-5E CAT-6A	TIA/EIA CATEGORY 5E RATED TIA/EIA CATEGORY 6A RATED		WITH ARCHITECTUI	
TA.704 TA.705	AUDIOVISUAL SYSTEM DIAGRAMS AUDIOVISUAL SYSTEM DIAGRAMS	CAT-6E CB	TIA/EIA CATEGORY 6E RATED CEILING BOX		HIGH LEVEL/HIGH C ARE NOT TO BE RU	
		CCTV	CLOSED CIRCUIT TELEVISION CIRCUIT		MUST RUN PARALL ACCORDING TO TH	
		COAX CL	COAXIAL CABLE CENTER LINE	•	THAT POWER CONI CONDUCTORS ARE	
		COND CLG	CONDUCTOR CEILING			
		CP CU	CONSOLIDATION POINT COPPER		MIN	NIMUM A
		DVR	DIGITAL VIDEO RECORDER			
		DWG	DRAWING		AV CONDUIT	т
		EC EM	CONDUCTOR EMERGENCY			
		EMT EC	ELECTRICAL METALLIC TUBING (W/ PULL STRING EMPTY CONDUIT		EMT	EM.
		EX	EXISTING		ЕМТ	RIG
		F/UTP FA	FOILED/UNSHIELDED TWISTED PAIR FIRE ALARM		RIGID STEEL	RIG
		FACP FB	FIRE ALARM CONTROL PANEL FLOOR BOX			
		FO FP	FIBER OPTIC FLAT PANEL	6.	NO LARGE POWER	TRANSF
		GND	GROUND		ALL AV CABLING TH	
		нс	HUNG CEILING		NO CABLE IS TO BE THE METHOD OF IN	
		HZ	HERTZ	•	THE METHOD OF IN THROUGH ACOUST	
		ID IDF	INSIDE DIAMETER INTERMEDIATE DISTRIBUTION FRAME	•	INSTALL FIRESTOP CONDUIT AS REQUI	
		LAN	LOCAL AREA NETWORK		TYPES. THE CONTR HAVING CABLING P	RACTOR
		LV	LOW VOLTAGE		ELECTRICAL SPECI	
		MAX MER	MAXIMUM MECHANICAL EQUIPMENT ROOM		ALL POWER, WIREV	
		MC MIC	MAIN CROSS CONNECT MICROPHONE			
		MDF MH	MAIN DISTRIBUTION FRAME MANHOLE		ALL OVERHEAD RIG STRUCTURAL ENGI	
		MIN MM	MINIMUM MULTIMODE	12.	POWER BREAKER A	AND DIST
		MTD MTER	MOUNTED MAIN TELECOMMUNICATIONS EQUIPMENT ROOM	•	ALL CABLE TRAY TH	
		N	NEUTRAL		BE SECURELY FAST	
		NC NIC	NORMALLY CLOSED NOT IN CONTRACT		POWER FOR AV AN THE ELECTRICAL E	
		NID NTS	NETWORK INTERFACE DEVICE NOT TO SCALE		APPLICABLE.	MDTV
		NO NO.	NORMALLY OPEN NUMBER		ALL AV-RELATED EI FURNISHED WITH P	
		OD	OUTSIDE DIAMETER		WHERE EXACT DIM	
		OFE OSP	OWNER FURNISHED EQUIPMENT OUTSIDE PLANT	,	FOR DETERMINING WHERE EXACT DIM	IENSION
		PA	PUBLIC ADDRESS		INCLUDING ANY AC PRELIMINARY ARCH	HITECTU
		PP PB	PATCH PANEL PULLBOX		CHANGES MUST BE	
		PR PBX	PAIR PRIVATE BRANCH EXCHANGE		NOTIFY OWNER'S R DRAWINGS. OBTAII	
		PNL POE	PANEL POWER OVER ETHERNET		ALL AV DEVICES SH	
		PRJ PTZ	PROJECTOR PAN/TILT/ZOOM		MANUFACTURER'S	
		RM	ROOM		THERE SHALL BE A PULL BOX WHERE 1	
		RW	RACEWAY	20.	MAINTAIN MINIMUM	I BEND R
		SC SB	SCREW COVER BOX SPEAKER BACK BOX		LIGHTING DESIGNE	
		SM SP	SINGLE MODE SPEAKER		ENSURE GOOD COI	
		ST STP	STRAND SHIELDED TWISTED PAIR		AV CONTRACTOR S TO COMPLETION O	
		TBD	TO BE DETERMINED	23.	REFER TO AV ELEC	TRICAL
		TEMP TGB	TEMPORARY TELECOMMUNICATIONS GROUND BAR	•	ALL POWER CIRCUI	
		TR TS	TELECOMMUNICATIONS ROOM TAMPER SWITCH		NON-AV CIRCUITS I	
		TSER TV	TELECOMMUNICATIONS SERVICE ENTRANCE ROOM TELEVISION		POWER FOR ALL AV PHASE SHALL NOT INTERFERENCE.	
		TYP	TYPICAL		INTERFERENCE. GROUNDING: GROU	
		UON UPS	UNLESS OTHERWISE NOTED UNINTERRUPTIBLE POWER SUPPLY		GROUNDING: GROU GROUNDING STANI EXCEED NEC REQU	DARDS A
		UTP	UNSHIELDED TWISTED PAIR		OR RESIDING IN TE	CHNICA
		VA VIF	VOLT/AMPERES VERIFY IN FIELD	,	USING A MINIMUM (WIRES USED FOR T INSULATION OR IDE	TECHNIC
		VM VOIP	VOLTMETER VOICE OVER INTERNET PROTOCOL		SHALL BE IDENTIFIE BUSHING ON ALL C	ED AND I
		VP VP	VAPOR PROOF		JUNCTION BOX CO	
		W WAN	WATTS WIDE AREA NETWORK	,	WHERE RAISED DE' BOXES ARE MOUNT	VICE CO
		WAP WM	WIRELESS ACCESS POINT WIRE MANAGEMENT		DOWN.	יבטאו(
		WP WS	WATERPROOF WORKSTATION		POWER RECEPTAC OR CEILING BOXES	
		WT WW	WATER TIGHT WIREWAY		DRAWINGS. TECHN TO THE ELECTRICA	IICAL PO
		XFRM	TRANSFORMER		NETWORK OUTLETS	
					DRAWINGS. NETWOOD RESERVENCE OF THE PROPERTY O	ORK SER QUIREME ECHNOLO


TED SPECIFICATIONS ARE INTENDED TO REPRESENT OVERALL DESIGN INTENT.

REMENTS SHOWN FOR REFERENCE ONLY AND ARE NOT FOR CONSTRUCTION. COORDINATE ER, ARCHITECT AND TELECOM DESIGNER DRAWINGS FOR LOCATION OF ALL OUTLETS IN

- ARE SHOWN TERMINATING IN JUNCTION BOXES WITHOUT RECEPTACLES, THE WIRES BOXES COVERED. THESE CIRCUITS WILL BE CONNECTED BY OTHERS DURING SYSTEMS EQUIPMENT.
- I THESE DRAWINGS SHOW ONLY INTERCONNECTION BETWEEN TERMINATION POINTS. THE IS TO BE DETERMINED BY THE COORDINATE PATHWAYS FOR ALL AV RELATED DEVICES D ELECTRICAL PLANS.
- NT FEEDS (SUCH AS FOR POWER DISTRIBUTION PANELS, LIGHTING, AND BRANCH CIRCUITS,) ALLEL WITH AUDIO/VIDEO CONDUITS OR CABLING. IF HIGH LEVEL/HIGH CURRENT FEEDS AUDIO/VIDEO CONDUITS OR CABLING, MINIMUM SEPARATION MUST BE MAINTAINED OWING TABLE. "NA" INDICATES THAT THE USE SHOULD BE AVOIDED. SPACINGS ASSUME RS WILL NOT BE TWISTED PAIRS. CLOSER SPACINGS CAN BE USED IF POWER ED PAIRS.

MINIMUM ACCEPTABLE DISTANCE BETWEEN PARALLEL AV AND POWER CONDUITS						
AV CONDUIT	POWER	COMBINED AMPACITY OF ALL PHASE CONDUCTORS IN POWER CONDUIT				
	CONDUIT	UNDER 60A	60A	120A	240A	400A
EMT	EMT	2 FT.	3 FT.	4 FT.	NA	NA
ЕМТ	RIGID STEEL	4 IN.	8 IN.	1 FT.	2 FT.	4 FT.
RIGID STEEL	RIGID STEEL	1 IN.	2 IN.	4 IN.	8 IN.	16 IN.

- FORMERS OR MOTORS SHOULD BE LOCATED WITHIN 50 FEET OF AV EQUIPMENT SPACES.
- RUN OPEN-WIRE SHALL BE SUPPORTED FROM J-HOOKS NO GREATER THAN 3 FEET APART. PPORTED OR LAID OVER CEILING TILES, BLACK IRON, OR OTHER CEILING MEMBERS.
- ATION OF BOXES IN WALLS, AND THE METHOD OF PASSAGE OF CONDUITS AND WIREWAYS
- SENSITIVE WALLS SHALL BE COORDINATED WITH THE ACOUSTICAL CONSULTANT.
- SLAB AND WALL PENETRATIONS PROVIDED FOR THE INSTALLATION OF CABLE AND O MAINTAIN FIRE RATING OF SLAB OR WALL. REVIEW ARCHITECT'S PLANS FOR PARTITION SHALL BE RESPONSIBLE FOR VERIFYING THE FIRE RATING OF ALL WALLS AND FLOORS ATIONS, COORDINATE SEALANT INSTALLATION WITH WORK OF OTHER TRADES. REFER TO ONS FOR MATERIAL AND INSTALLATION PARAMETERS.
- AND JUNCTION BOXES ARE TO BE REVIEWED BY ELECTRICAL ENGINEER FOR CODE AND
- REQUIREMENTS ARE TO BE REVIEWED AND STAMPED FOR APPROVAL BY LICENSED FOR CODE AND SAFETY COMPLIANCE.
- TRIBUTION PANELS ARE SIZED AND SPECIFIED BY THE ELECTRICAL ENGINEER.
- SURFACE-MOUNTED ON SLAB BELOW RAISED FLOOR OR ABOVE EQUIPMENT RACKS SHALL AND LEFT OPEN FOR CABLE ACCESS.
- TED SYSTEMS SHALL USE AN EIA/TIA 607 COMPLIANT GROUNDING SYSTEM, DESIGNED BY ER. REFER TO AV DETAIL SHEETS FOR ADDITIONAL GROUNDING REQUIREMENTS IF
- CONDUIT SHALL BE REAMED, CLEANED, CAPPED (WHERE APPROPRIATE), TAGGED, AND
- NS ARE NOT INDICATED. THE SCALE OF THIS DRAWING IS NOT SUFFICIENTLY ACCURATE OCATION OF EQUIPMENT, JUNCTION BOXES, OUTLET BOXES, WIREWAYS, PANELS, ETC. IS ARE INDICATED. THE REFERENCE SURFACE SHALL BE THE FINAL FINISHED SURFACE CAL TREATMENT. ROOM DIMENSIONS ON THE DRAWINGS HAVE BEEN TAKEN FROM URAL DRAWINGS. ALL DIMENSIONS MUST BE VERIFIED AND ANY DEVIATIONS CAUSING DINATED WITH SHEN MILSOM & WILKE, LLC.
- ENTATIVES OF ANY DISCREPANCIES BETWEEN THE EXISTING CONDITIONS AND THE AV RIFICATION BEFORE PROCEEDING WITH WORK.
- SECURELY MOUNTED PLUMB AND STRAIGHT TO WALLS, FLOORS, OR RACKS PER THE IMENDED MOUNTING PRACTICE.
- JM OF ONE PULL BOX FOR EVERY 100' OF STRAIGHT EMPTY AV-RELATED CONDUIT AND ONE ARE MORE THAN TWO 90° BENDS OR LESSER BENDS TOTALING 180° IN A CONDUIT RUN.
- RADIUS OF 10X OD FOR ALL AV-RELATED CONDUITS.
- ROVIDE LIGHTING ON A SEPARATE DIMMING ZONE AT THE SCREEN/DISPLAY DEVICE TO AND IMAGE SHARPNESS.
- RESTORE CEILINGS, WALLS AND ANY OTHER SURFACES AFFECTED BY THEIR WORK PRIOR WITH LIKE MATERIALS TO MATCH EXISTING CONSTRUCTION.
- PLANS AND/OR RISER DIAGRAMS FOR EMPTY CONDUIT SIZING.
- ICATED IN THIS DRAWING SET TO BE PROVIDED BY DEDICATED BREAKER PANEL(S). NO ED FROM DEDICATED AV BREAKER PANEL(S).
- ICES IN EACH DESIGNATED SPACE SHALL BE ON THE SAME ELECTRICAL PHASE, AND THIS DE MOTORS, APPLIANCES, OR ANY OTHER SOURCE THAT CAN CAUSE SIGNAL
- MMUNICATIONS SYSTEMS AND EQUIPMENT IN ACCORDANCE WITH ANSI/TIA/EIA-807 AND APPLICABLE NEC REQUIREMENTS EXCEPT WHERE DRAWINGS OR SPECIFICATIONS NTS. ALL RACKS, METALLIC BACKBOARDS, CABLE SHEATHS, CABLE TRAYS, ETC. ENTERING AL EQUIPMENT SPACES SHALL BE GROUNDED TO THEIR RESPECTIVE GROUND SYSTEM WG STRANDED COPPER BONDING CONDUCTOR AND COMPRESSOR CONNECTORS. ALL CAL POWER SYSTEMS GROUNDING PURPOSES SHALL BE IDENTIFIED WITH GREEN D AT EACH TERMINATION POINT WITH A WRAP OF GREEN TAPE. ALL CABLES AND BUS BARS LABELED "TECHNICAL POWER SYSTEM GROUND". CONDUIT STUBS: PROVIDE NYLON STUBS AND NON-TERMINATING CONDUIT ENDS TO PROTECT WIRE PULLS.
- INLESS OTHERWISE NOTED, ALL JUNCTION BOXES MUST BE PROVIDED WITH A COVER. OVERS ARE SPECIFIED, MATCH COVER DEPTH TO WALL THICKNESS. WHERE JUNCTION OR ABOVE FINISHED CEILING HEIGHT, INSTALL JUNCTION BOXES WITH OPEN SIDE FACING
- ECHNICAL POWER RECEPTACLES. INCLUDING THOSE WITHIN FLOOR BOXES, WALL BOXES, BE PROVIDED BY THE BUILDING CONTRACTOR AND APPEAR ON THE ELECTRICAL OWER RECEPTACLES IN RELATION TO TECHNOLOGY INFRASTRUCTURE IS CRITICAL. REFER VINGS FOR COMPLETE POWER LAYOUTS AND CIRCUITING DETAILS.
- AUDIOVISUAL SYSTEMS: ALL NETWORK OUTLETS SHALL APPEAR ON THE NETWORK RVICES APPEARING ON THE AUDIOVISUAL DRAWINGS ARE REPRESENTATIVE OF NETWORK MENTS IN SUPPORT OF AUDIOVISUAL SYSTEMS, AS THE LOCATION OF NETWORK SERVICES IN RELATION TO TECHNOLOGY INFRASTRUCTURE IS CRITICAL. REFER TO THE STRUCTURED CABLING SYSTEM SPECIFICATIONS AND DRAWINGS FOR ADDITIONAL INFORMATION.

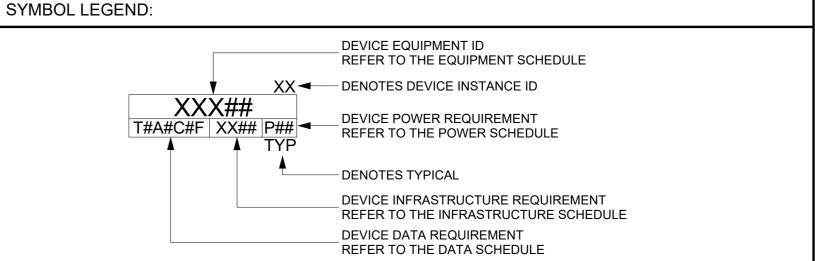

NETWORK SYMBOL KEY:

LETTER	DESCRIPTION	DESTINATION	CABLE TYPE
Т	CLIENT NETWORK DATA	REFER TO TT DRAWINGS	REFER TO TT DRAWINGS
Α	AV NETWORK DATA	NEAREST AV RACK ROOM	REFER TO NETWORK SCHEDULE
С	CABLE TV DROP	REFER TO TT DRAWINGS	CATV, REFER TO TT DRAWINGS
F	CLIENT NETWORK FIRER	REFER TO TT DRAWINGS	REFER TO TT DRAWINGS

SCOPE OF WORK BETWEEN TRADES:

DEFINITION OF TERMS:

TO PURCHASE AND DELIVER TO THE PROJECT SITE COMPLETE WITH EVERY NECESSARY APPURTENANCE AND SUPPORT. PURCHASING SHALL INCLUDE PAYMENT OF ALL SALES TAXES AND OTHER SURCHARGES AS MAY BE REQUIRED TO ASSURE THAT PURCHASED ITEMS ARE FREE OF ALL LIENS. CLAIMS, OR ENCUMBRANCES.

TO UNLOAD AT THE DELIVERY POINT AT THE SITE AND PERFORM EVERY OPERATION NECESSARY TO ESTABLISH SECURE MOUNTING AND CORRECT OPERATION AT THE PROPER LOCATION IN THE PROJECT, ALL AS PART OF THE WORK.

LEGEND FOR SCOPE OF WORK BETWEEN TRADES:

- GENERAL CONTRACTOR
- ELECTRICAL CONTRACTOR AUDIOVISUAL

- STRUCTURED CABLING, OR TELECOMMUNICATIONS CONTRACTOR

SCOPE OF WORK	FURNISH	INSTALL
IN-WALL BLOCKING SUPPORT FOR AV MOUNTS	GC	GC
MOTORIZED PROJECTION SCREENS	AV	GC
SPECIALTY AV BACKBOXES (DISPLAYS, CAMERAS, ETC.)	AV	GC
WALL AND CEILING SPEAKER CUTOUTS	GC	GC
FURNITURE CUTOUTS FOR AV EQUIPMENT (UNLESS PROVIDED BY FURNITURE PROVIDER)	GC	GC
MOTORIZED PROJECTION LIFTS	GC	GC
STRUT CHANNEL AND/OR BLACK IRON AS REQUIRED FOR CEILING MOUNTED AV DEVICES	GC	GC
CABLE CONTAINMENT INCLUDING:	EC	EC
- CONDUIT WITH MEASURED PULLSTRINGS	EC	EC
- CABLETRAY, LADDERTRAY, AND WIREWAYS	EC	EC
- FLOORBOXES	EC	EC
- JUNCTION BOXES, PULL BOXES, AND BACKBOXES	EC	EC
POWER OUTLETS	EC	EC
DEDICATED DISTRIBUTION PANELS, LOAD CENTERS, AND POWER ISOLATION TRANSFORMERS	EC	EC
AV CABLING (LOW VOLTAGE)	AV	AV
POWER OUTLETS	AV	AV
AV TERMINATIONS	AV	AV
CUSTOM ENGRAVED AV COVER PLATES	AV	AV
J-HOOKS AND OTHER SUPPORTS REQUIRED FOR OPEN-RUN AV CABLING	AV	AV
AV DEVICE WALL MOUNTS	AV	AV
AV DEVICES (AS DESCRIBED IN THE AV BID DOCS)	AV	AV
VOICE/DATA NETWORK CABLING (FIBER AND TWISTED PAIR)	ST	ST
VOICE/DATA COVER PLATES	ST	ST
CATV CABLING	ST	ST
LIGHTING & SHADE CONTROL INTERFACE	EC	EC

REFER TO AV DETAIL SHEETS FOR ADDITIONAL SCOPE DELINEATION AND INFORMATION



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CONSULTANT:



DATE:

NO:

DESCRIPTION:

KEY PLAN:

OGS PROJECT NO: SF760

DRAWING TITLE:

12/11/24 OGS SUBMISSION

AUDIOVISUAL TITLE SHEET

12/11/24 21-048-1165.02 DRAWING NO.:

	AUDIOVISUAL EQUIPMENT SCHEDULE
DEVICE ID	TYPE
ANT01	WIRELESS MICROPHONE ANTENNA
AVP01	AV WALL PLATE
AVP02	AV FLOORBOX PLATE
AVP04	AV WALL PLATE
CAM03	INTEGRATED VIDEO CAMERA BAR (CISCO)
CAM05	PTZ VIDEO CAMERA - WALL (1BEYOND)
CAM06-C	PTZ VIDEO CAMERA - CEILING (CISCO)
CAM06-W	PTZ VIDEO CAMERA - WALL (CISCO)
CTP01	TABLE TOP AV CONTROL PANEL
ER01	AV EQUIPMENT RACK - FULL HEIGHT
ER02	AV RACK, CREDENZA
FPD05-VC	75" ALL-IN-ONE VC APPLIANCE
FPD06	FLAT PANEL DISPLAY, 85"
FPD06-E	EXISTING FLAT PANEL DISPLAY, 80"
FPD08	POLE MOUNTED FLAT PANEL DISPLAY, 55"
LED01	DIRECT VIEW LED VIDEO WALL - 32:9 ASPECT RATIO 8X4
MIC02	CEILING MICROPHONE ARRAY, 2'X2'
MICP	CUSTOM MICROPHONE PLUGS
PS01-E	EXISTING PROJECTOR SCREEN
PSS01	PARTITION SENSOR
SPK01-E	EXISTING RECESSED CEILING SPEAKER
TH01	AV TABLE HATCH
TH-E	EXISTING AV TABLE HATCH
VP02	POLE MOUNTED PROJECTOR

INFRASTRUCTURE SCHEDULE					
TAG#	TYPE	DETAILS			
AV2	2-GANG				
AV6	6-GANG				
AVE	EXISTING AV INFRASTRUCTURE	<varies></varies>			
CP1	CEILING POLE MOUNTED				
FB1	EXISTING AV FLOOR BOX				
GR1	TABLE GROMMET				
WB2	RPV WALLMATE 32				

NETWORK SCHEDULE				
TAG#	# of Data Drops	TYPE		
T2	2	CATEGORY 6		
T4	4	CATEGORY 6		
TE	0	EXISTING		

POWER SCHEDULE			
TAG#	QTY Per Location	Device Power Notes	
P1	1	120V/20A DUPLEX RECEPTACLE, 5-20R	
P2	2	120V/20A QUAD RECEPTACLE, 5-20R	
P5	1	120V/20A DEDICATED CIRCUIT - DUPLEX RECEPTACLE, 5-20R - INSTALLED IN ARLINGTON TVBS503 RECESSED OUTLET BACKBOX	
PE	0	EXISTING POWER	



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OGS PROJECT NO: SF760

DRAWING TITLE:
AUDIOVISUAL SCHEDULES


15SUE DATE:
12/11/24

PROJECT NO.: SCALE:
21-048-1165.02

DRAWING NO.:

TA.001

PROJECT LOCATION:
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212-563-1284 [F]
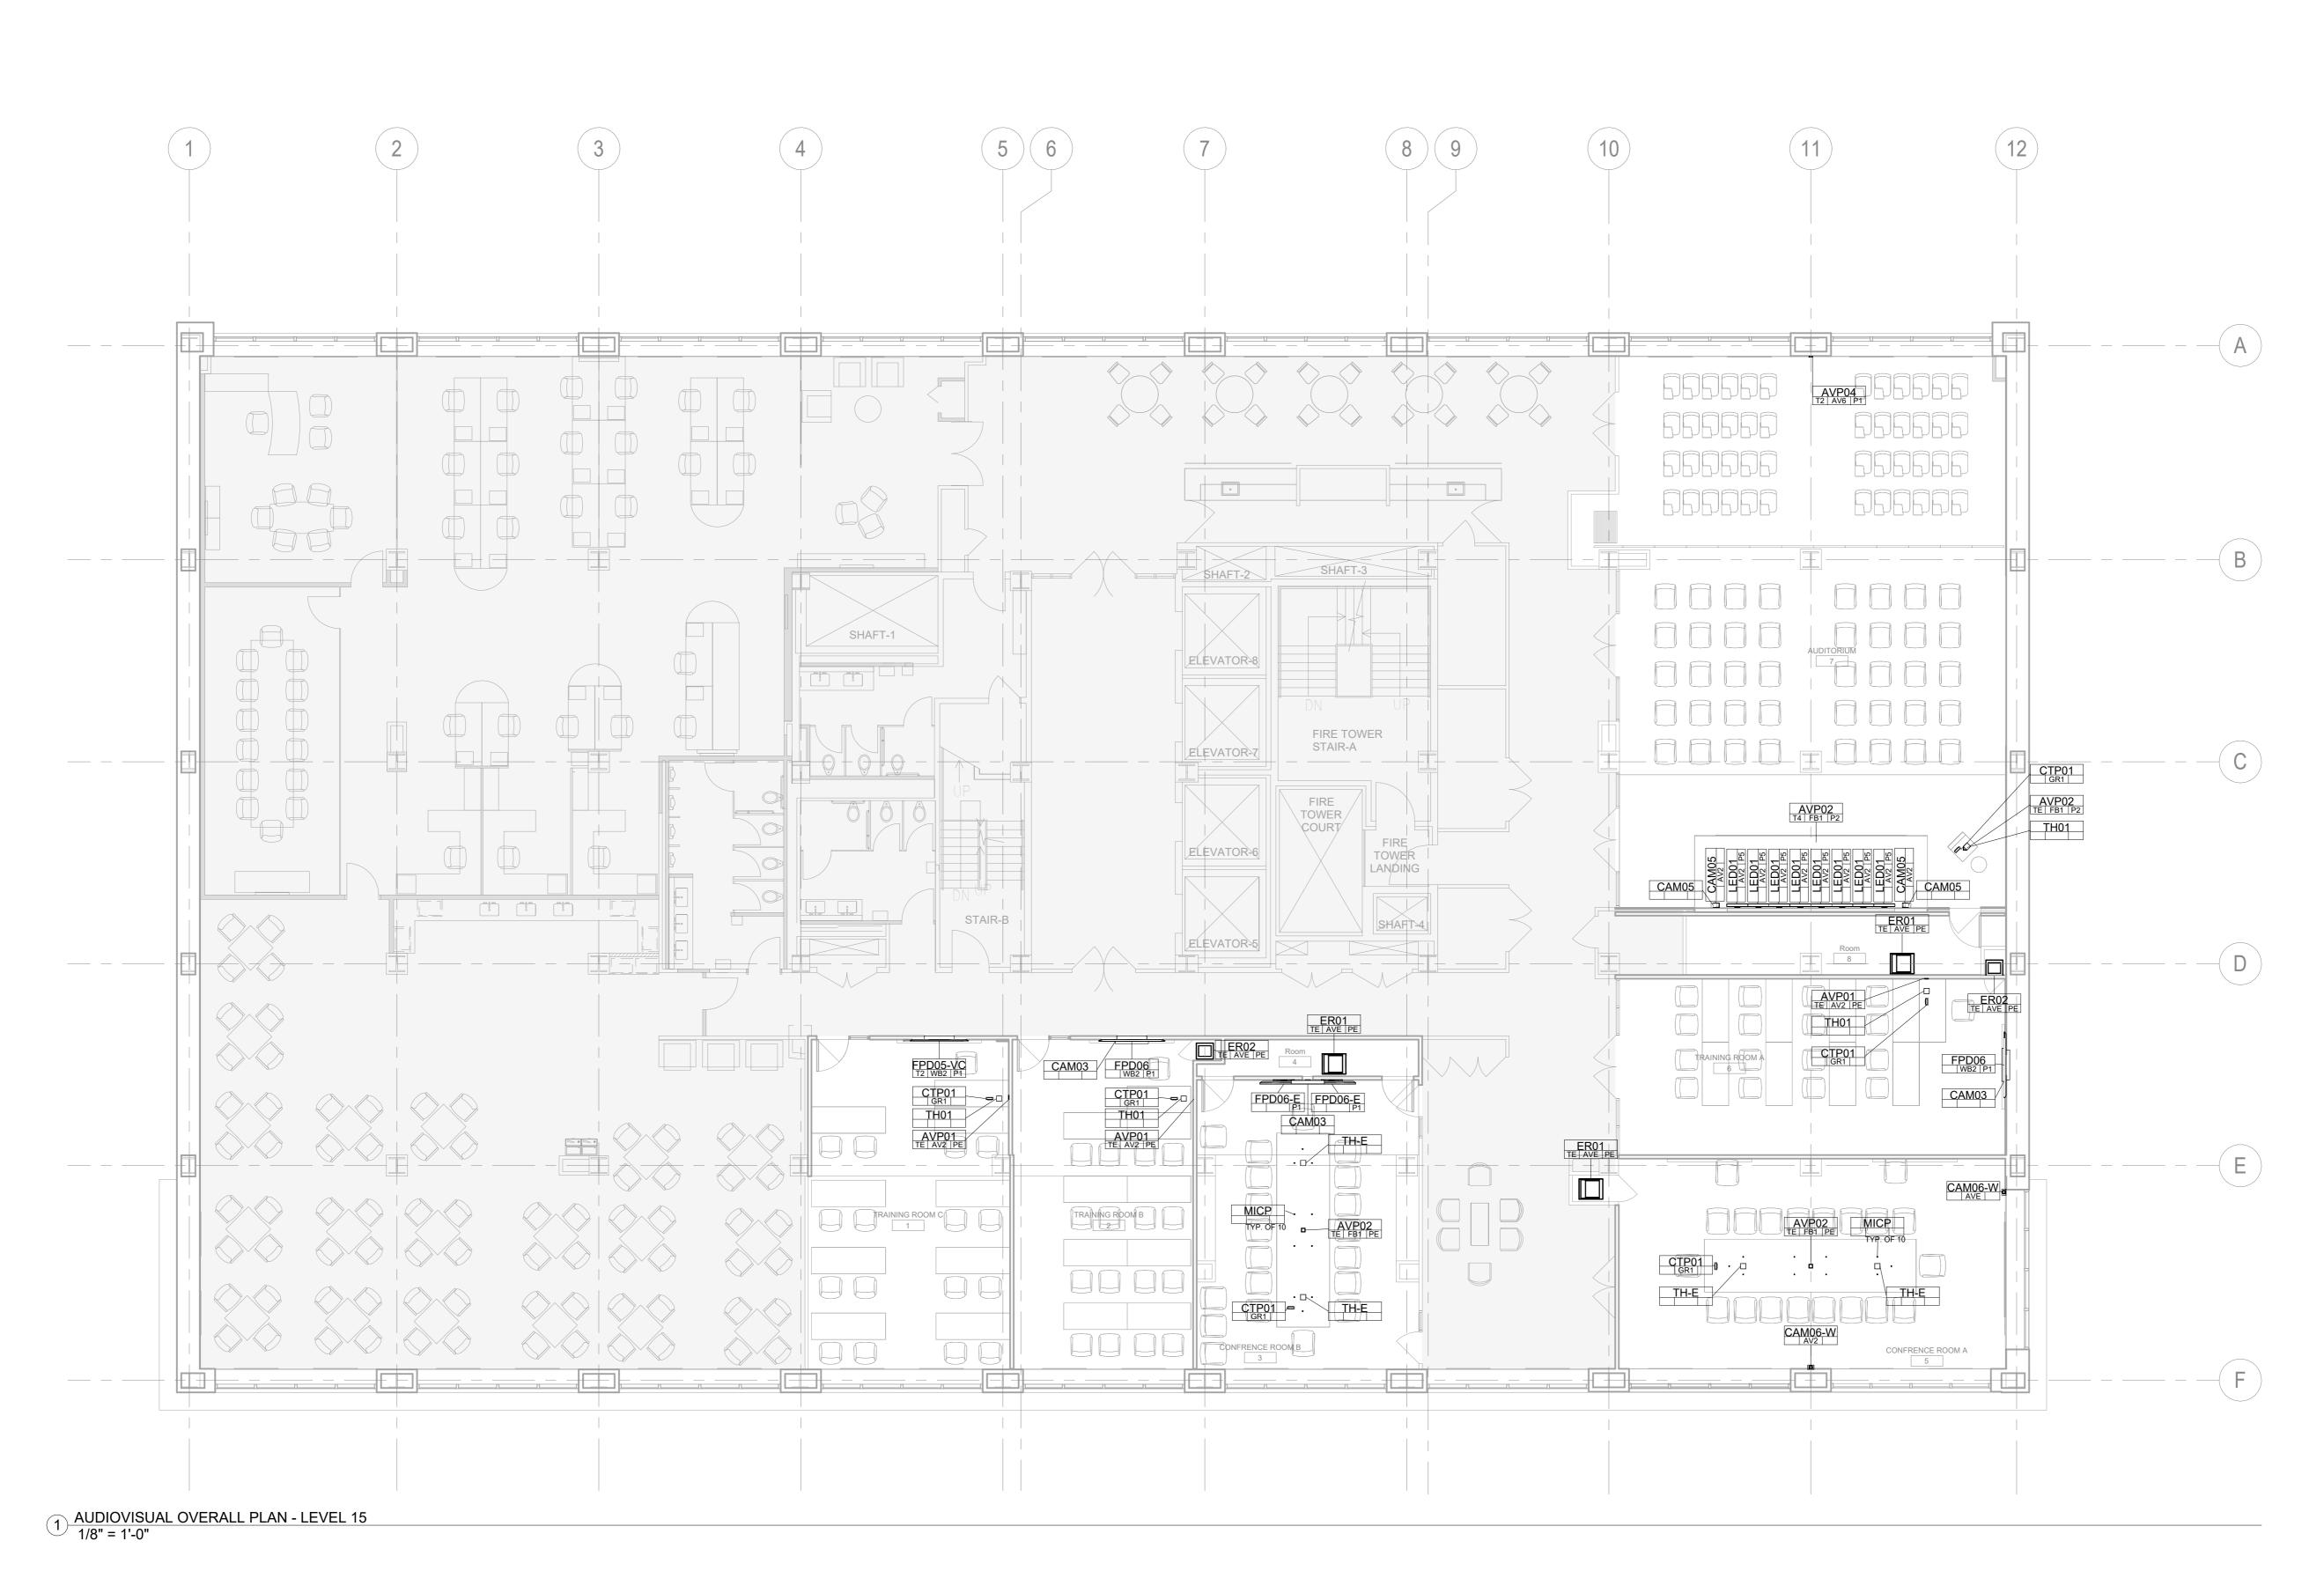
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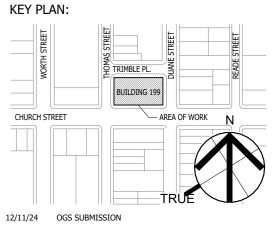
CONSULTANT:

SHEN MILSOM & WILKE, LLC
AUDIO AND VISUAL CONSULTANT
275 MADISON AVE
NEW YORK, NY 10016
TEL 212-725-6800

1/29/25 F 12/11/24 P DATE: D

FOR BID PERMIT SET DESCRIPTION:

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OGS PROJECT NO: SF760

DRAWING TITLE:

AUDIOVISUAL OVERALL PLAN - LEVEL 15

ISSUE DATE:

12/11/24


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21-048-1165.02 1/8" = 1'-0'

DRAWING NO.:

TA.115

PROJECT LOCATION:
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DESCRIPTION:

OGS PROJECT NO: SF760

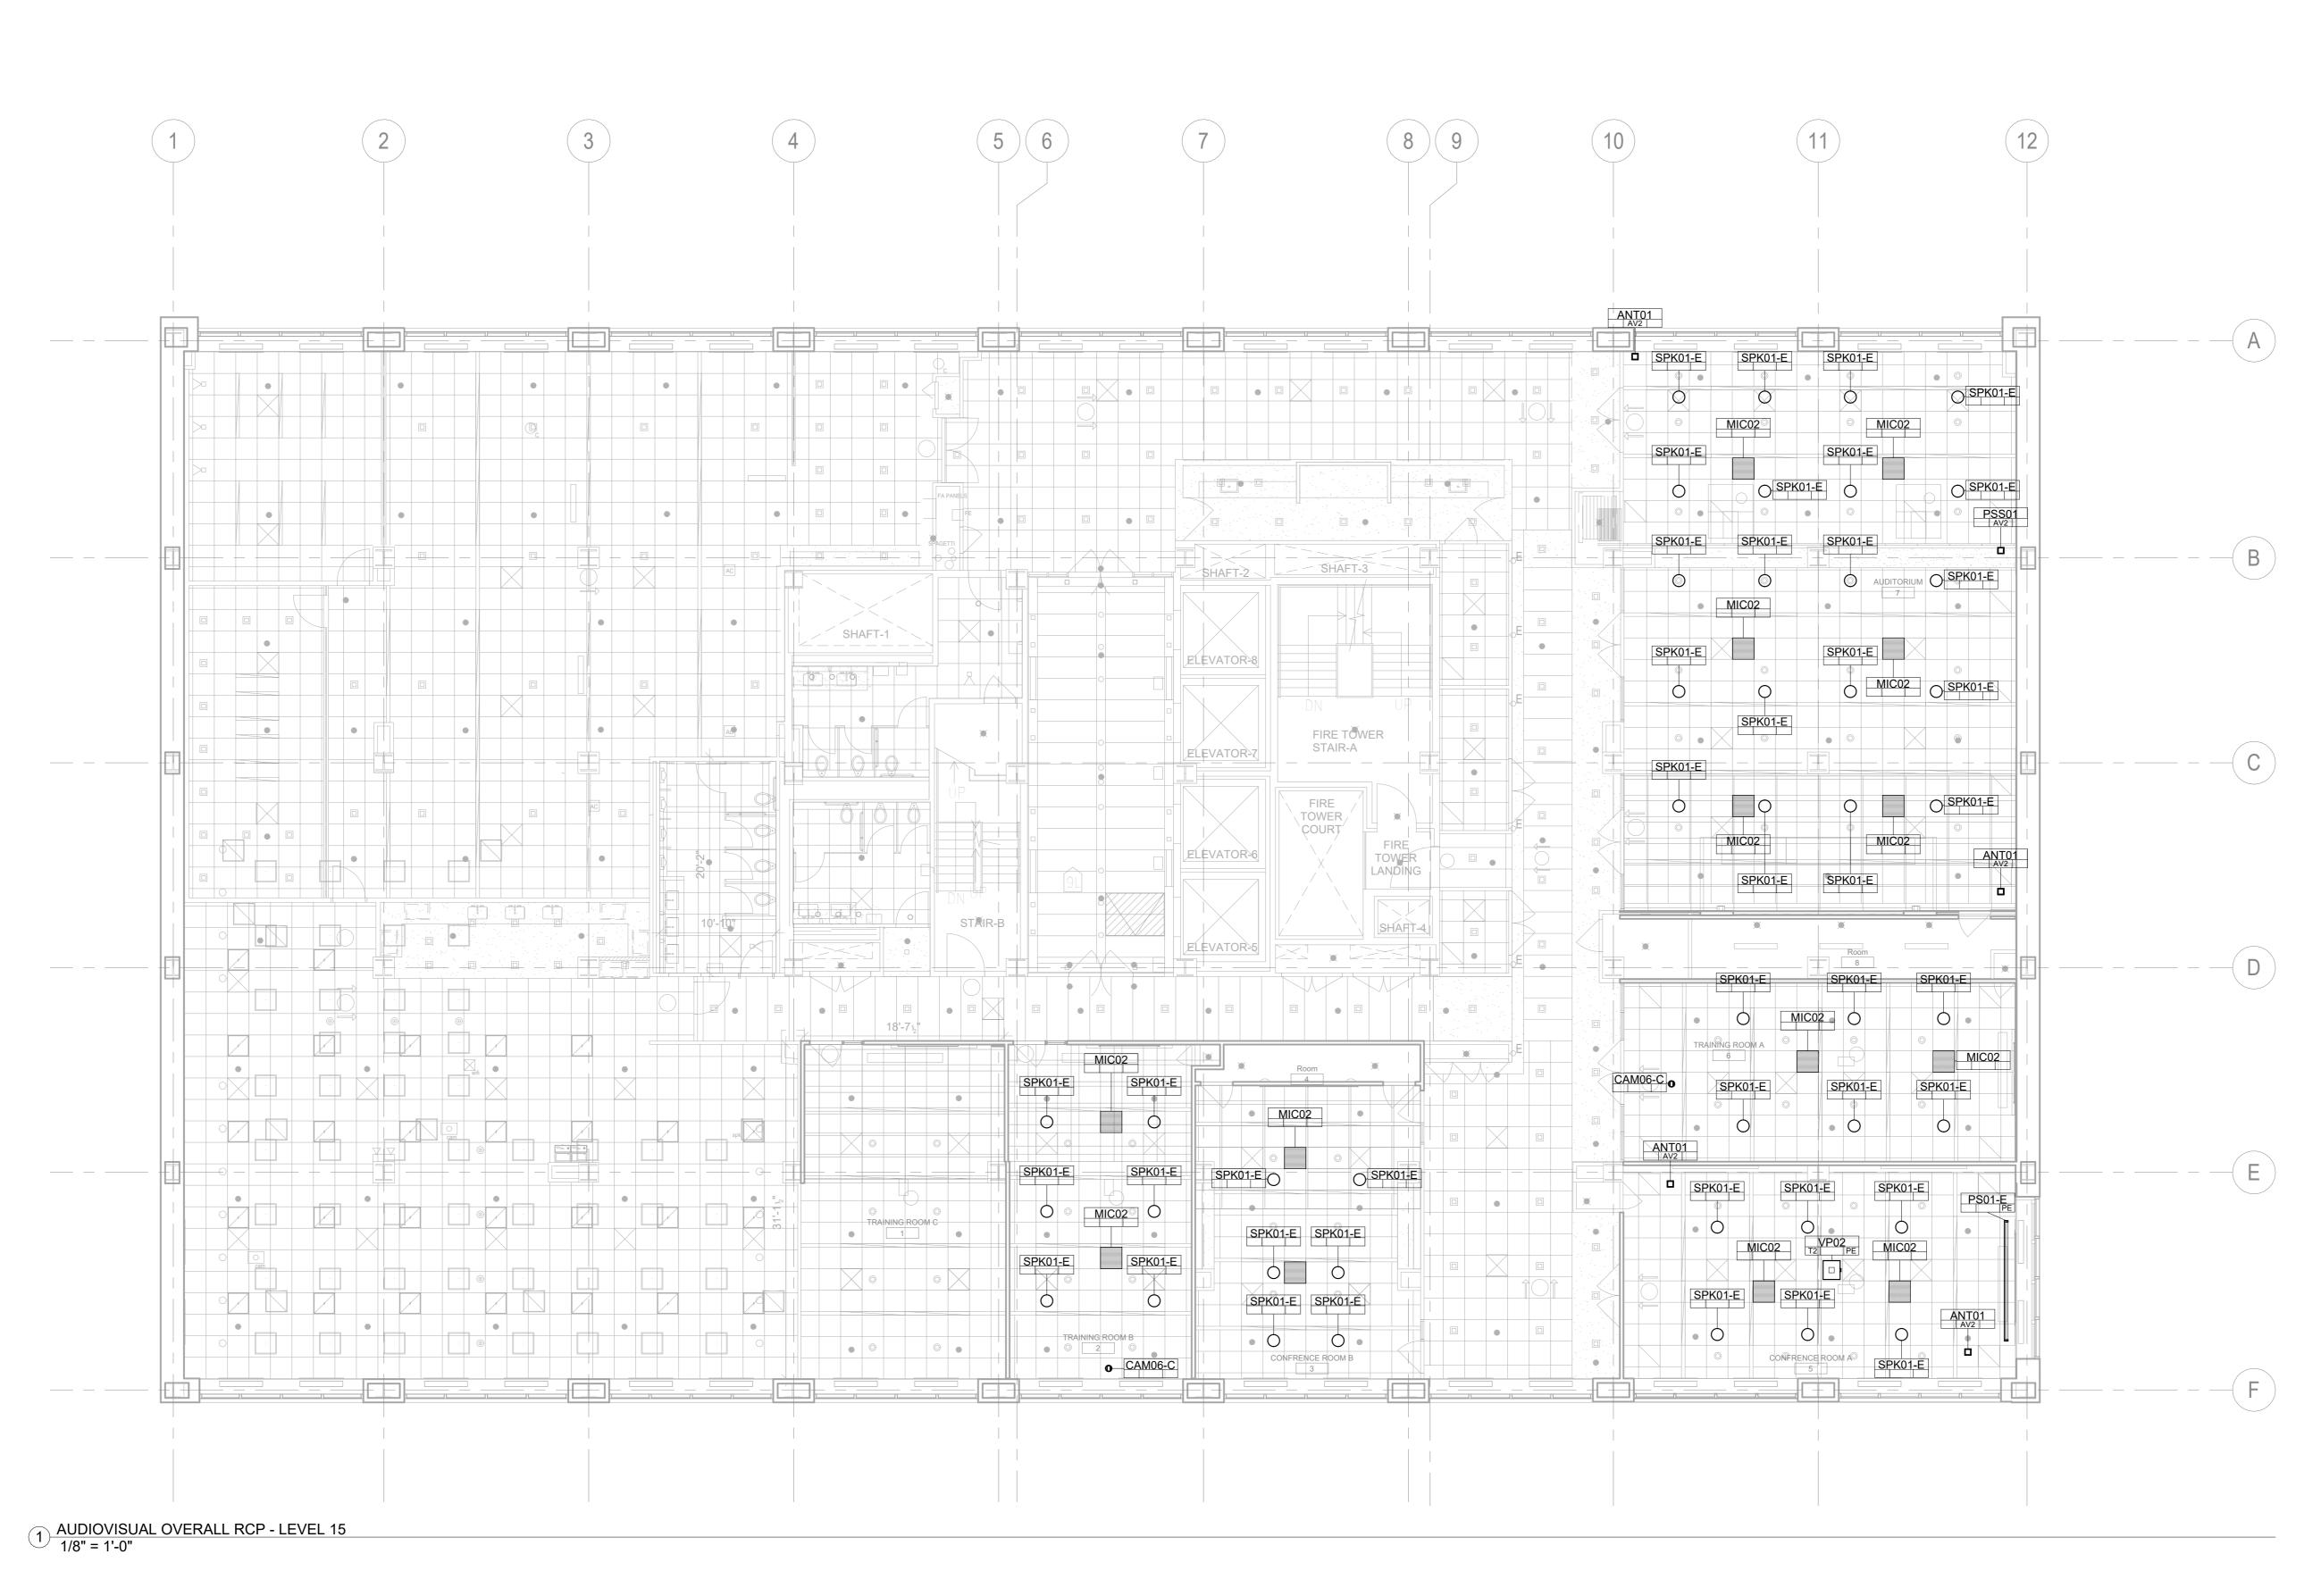DRAWING TITLE:


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AUDIOVISUAL OVERALL RCP - LEVEL 15

12/11/24 21-048-1165.02 DRAWING NO.:

TA.215

PROJECT LOCATION:
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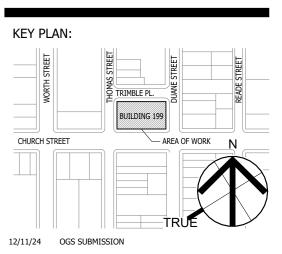
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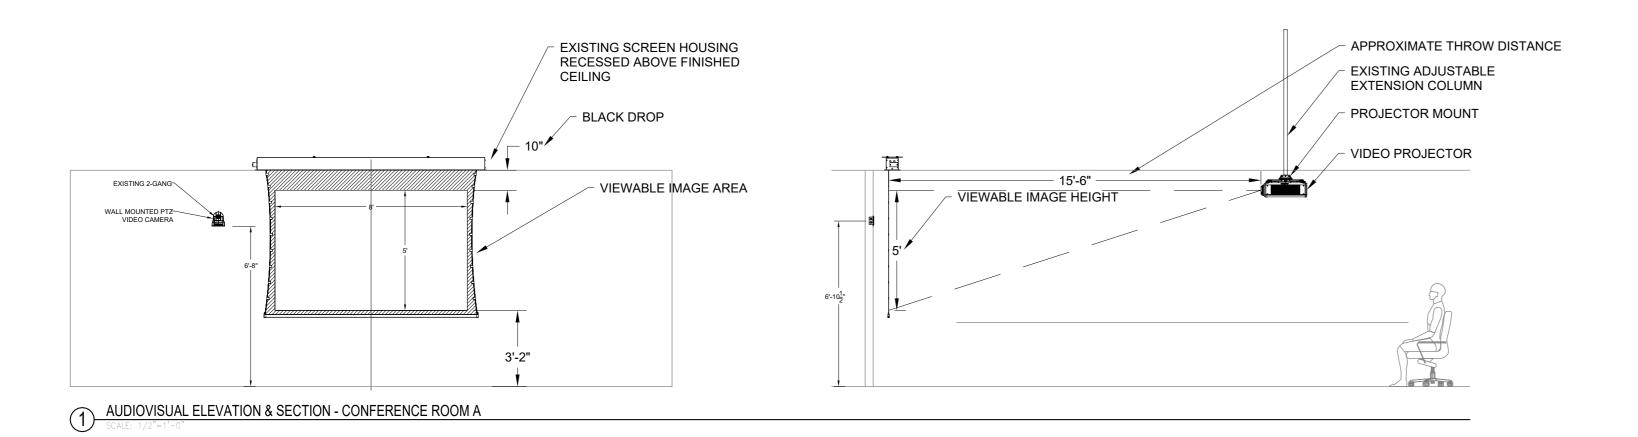
OGS PROJECT NO: SF760

DRAWING TITLE:

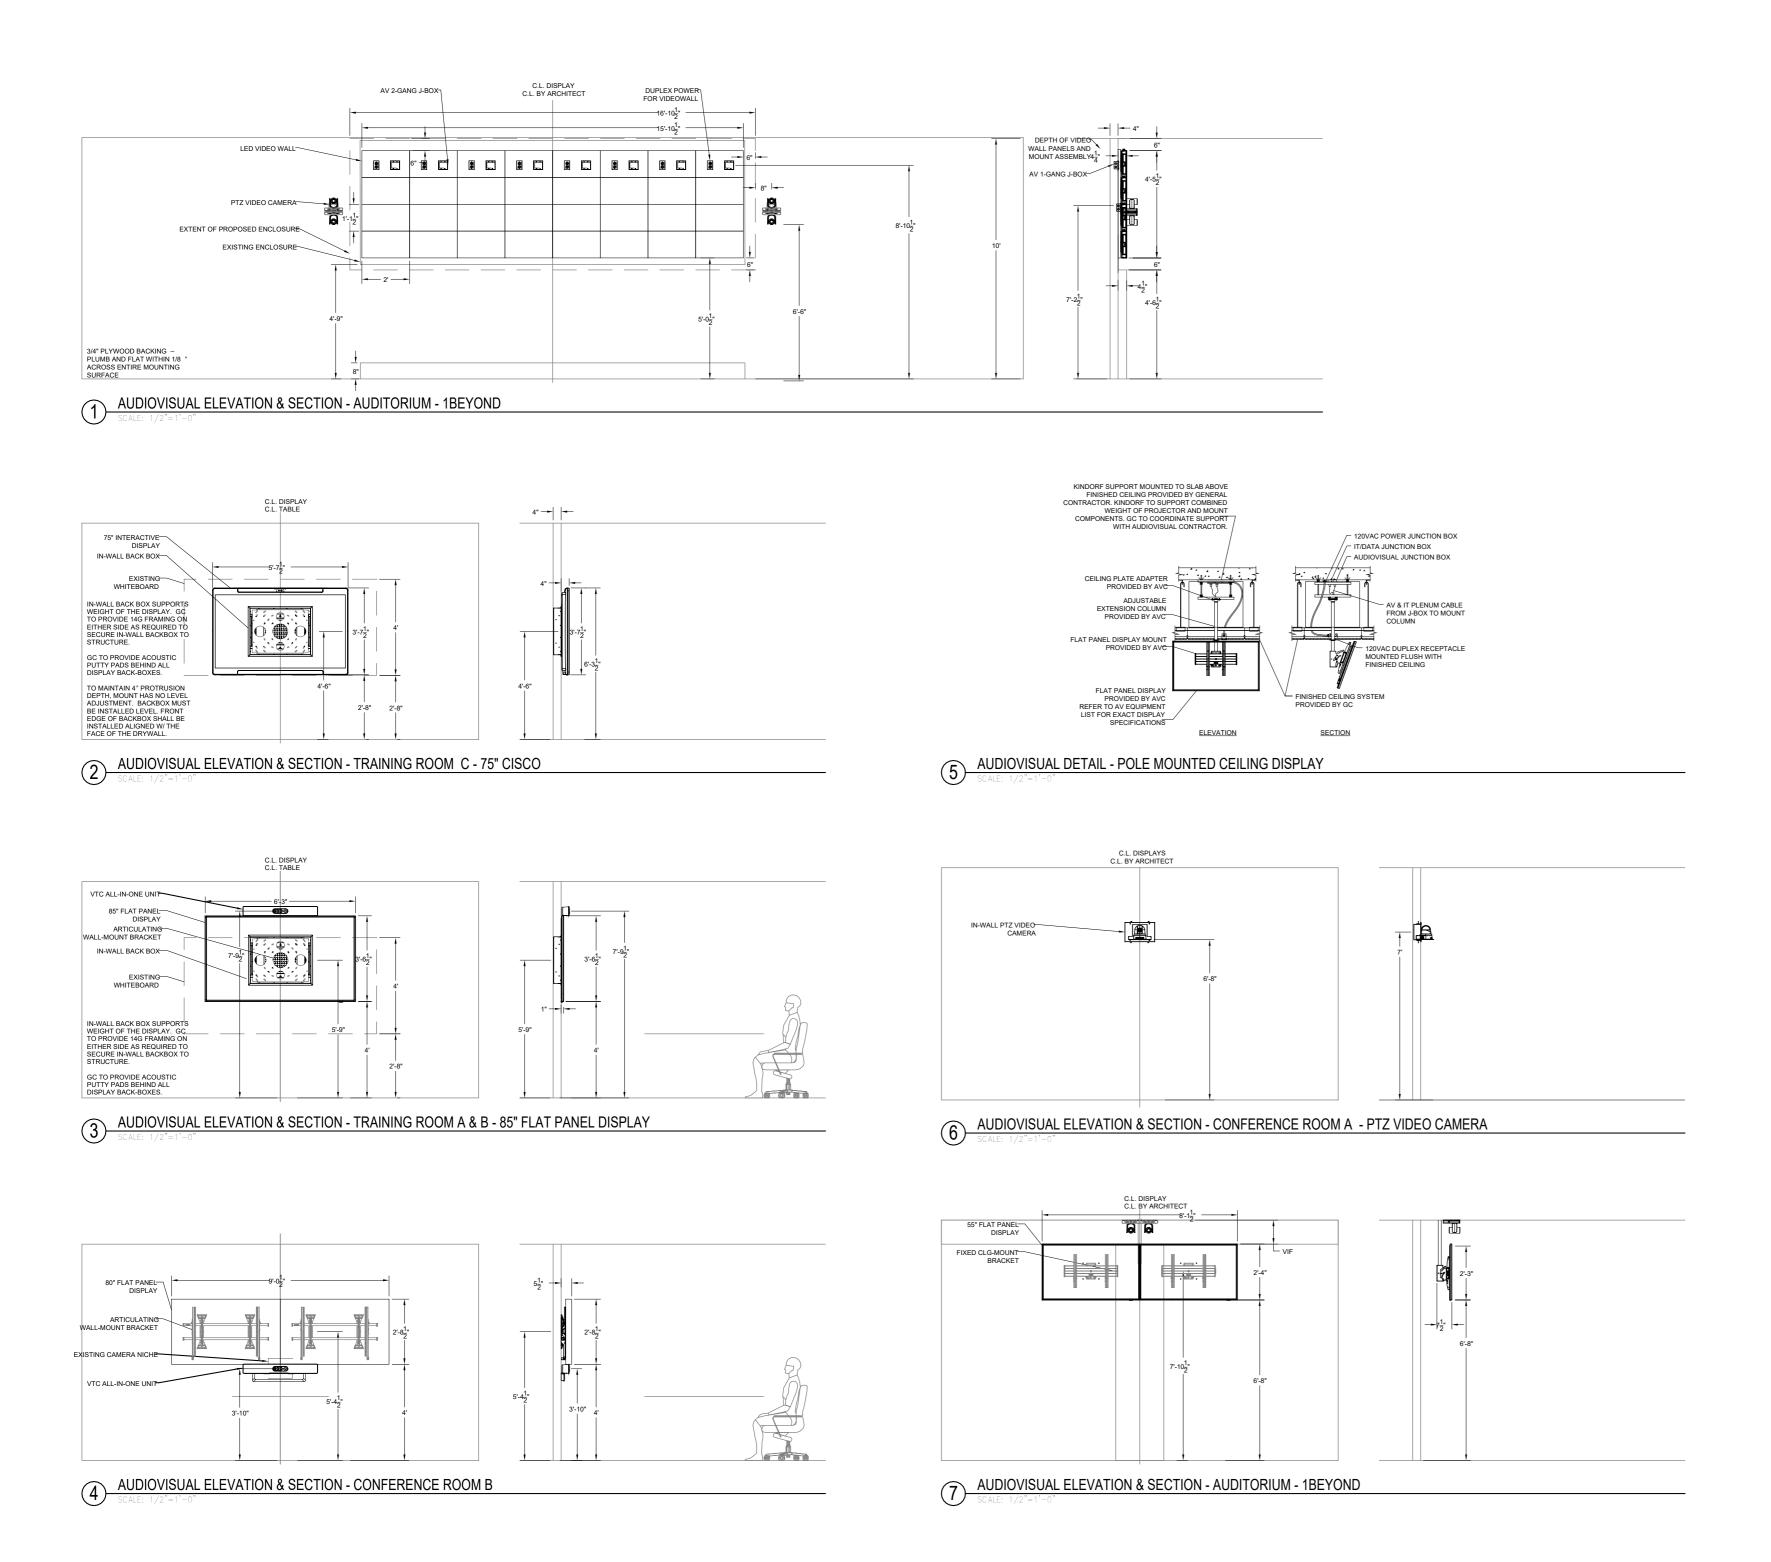AUDIOVISUAL SECTIONS & ELEVATIONS

ISSUE DATE: 12/11/24 21-048-1165.02

DRAWING NO.: TA.400





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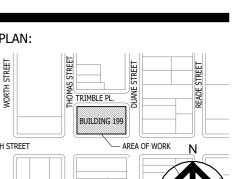
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OGS PROJECT NO: SF760

DRAWING TITLE:

AUDIOVISUAL SECTIONS & ELEVATIONS


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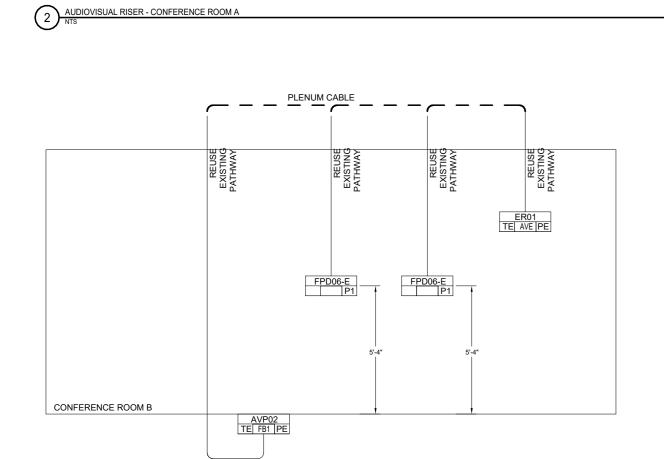
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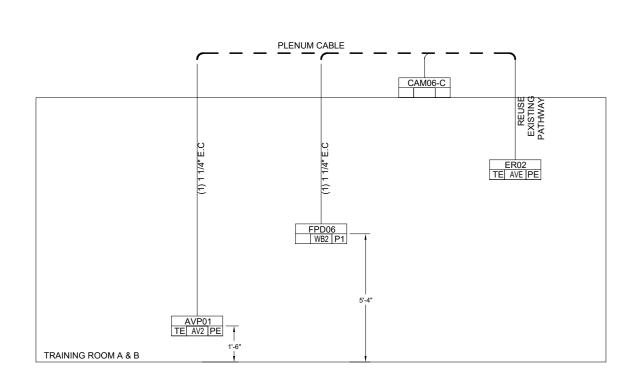
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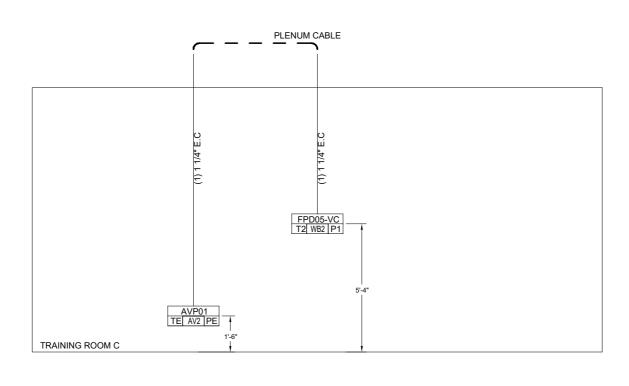




CONFERENCE ROOM A

AUDIOVISUAL RISER - CONFERENCE ROOM B



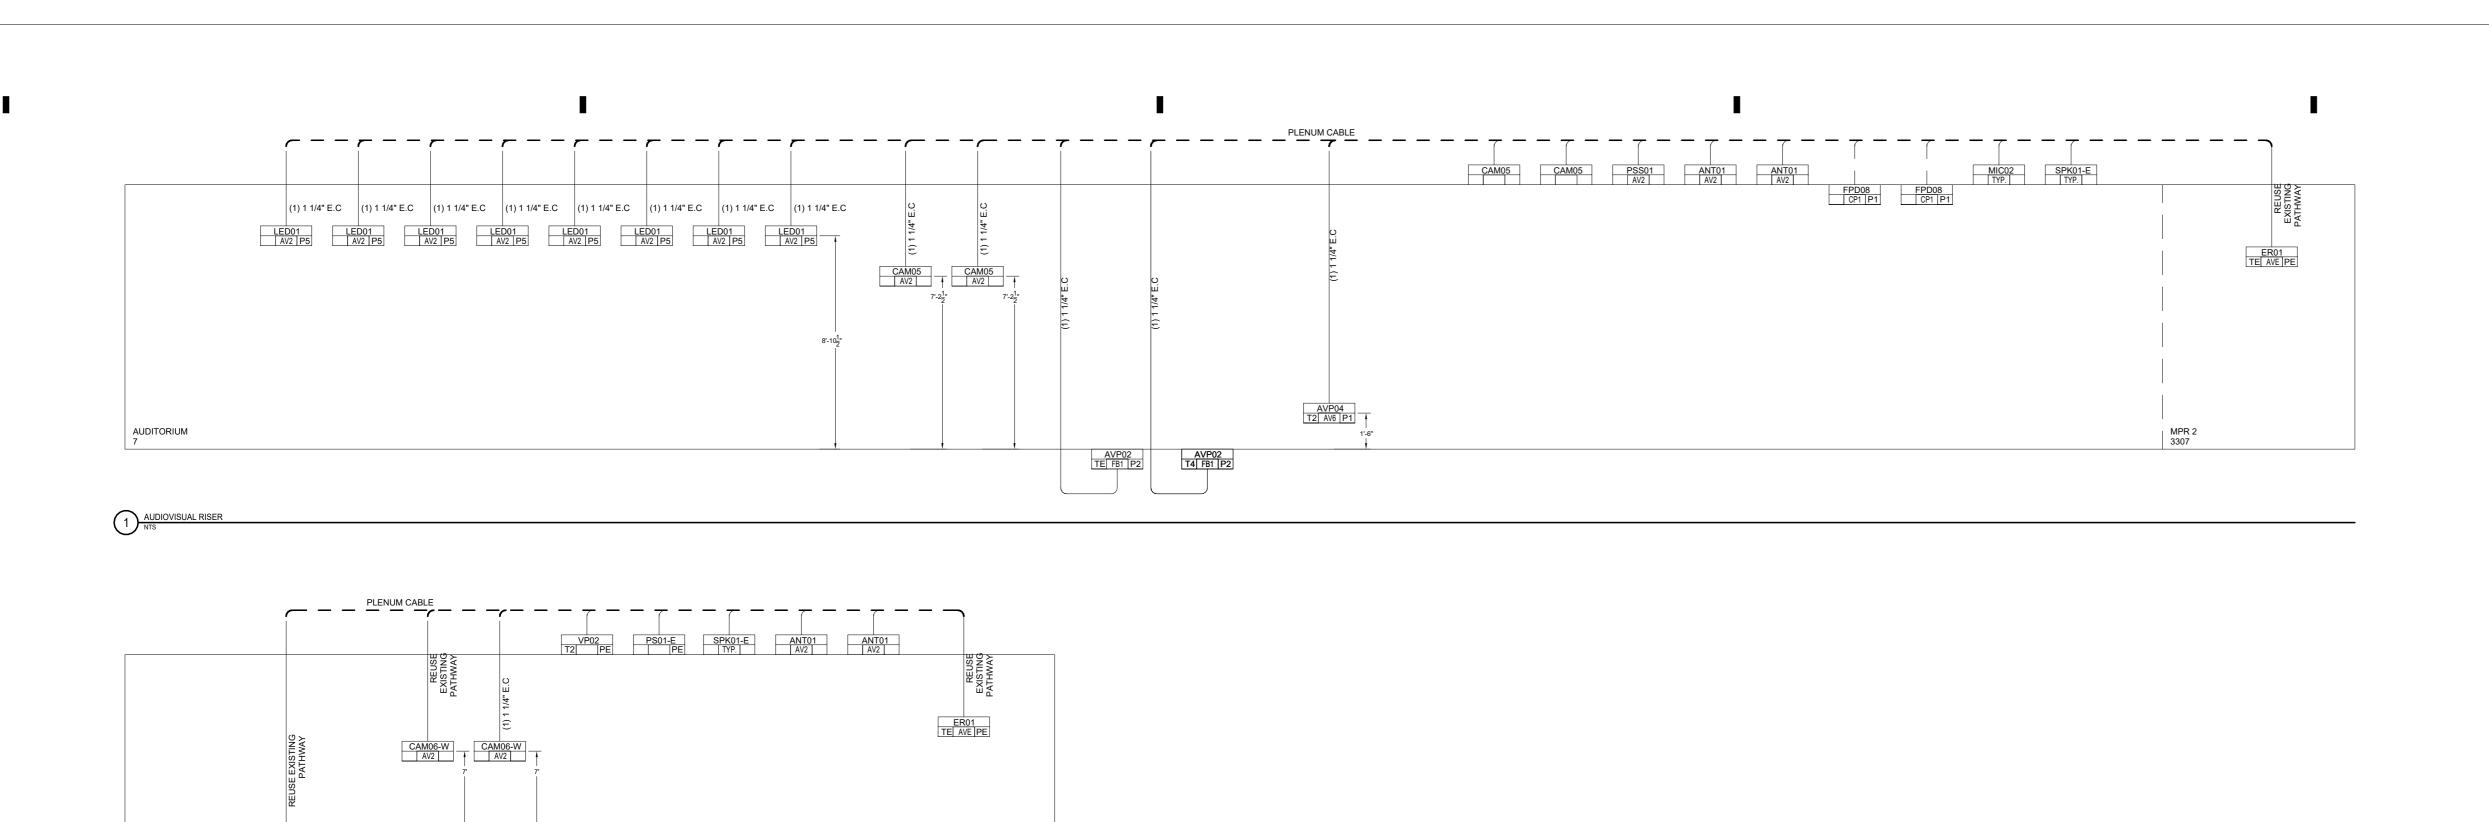

4 AUDIOVISUAL RISER - TRAINING ROOM A & B

AUDIOVISUAL RISERS

DRAWING TITLE:

OGS PROJECT NO: SF760

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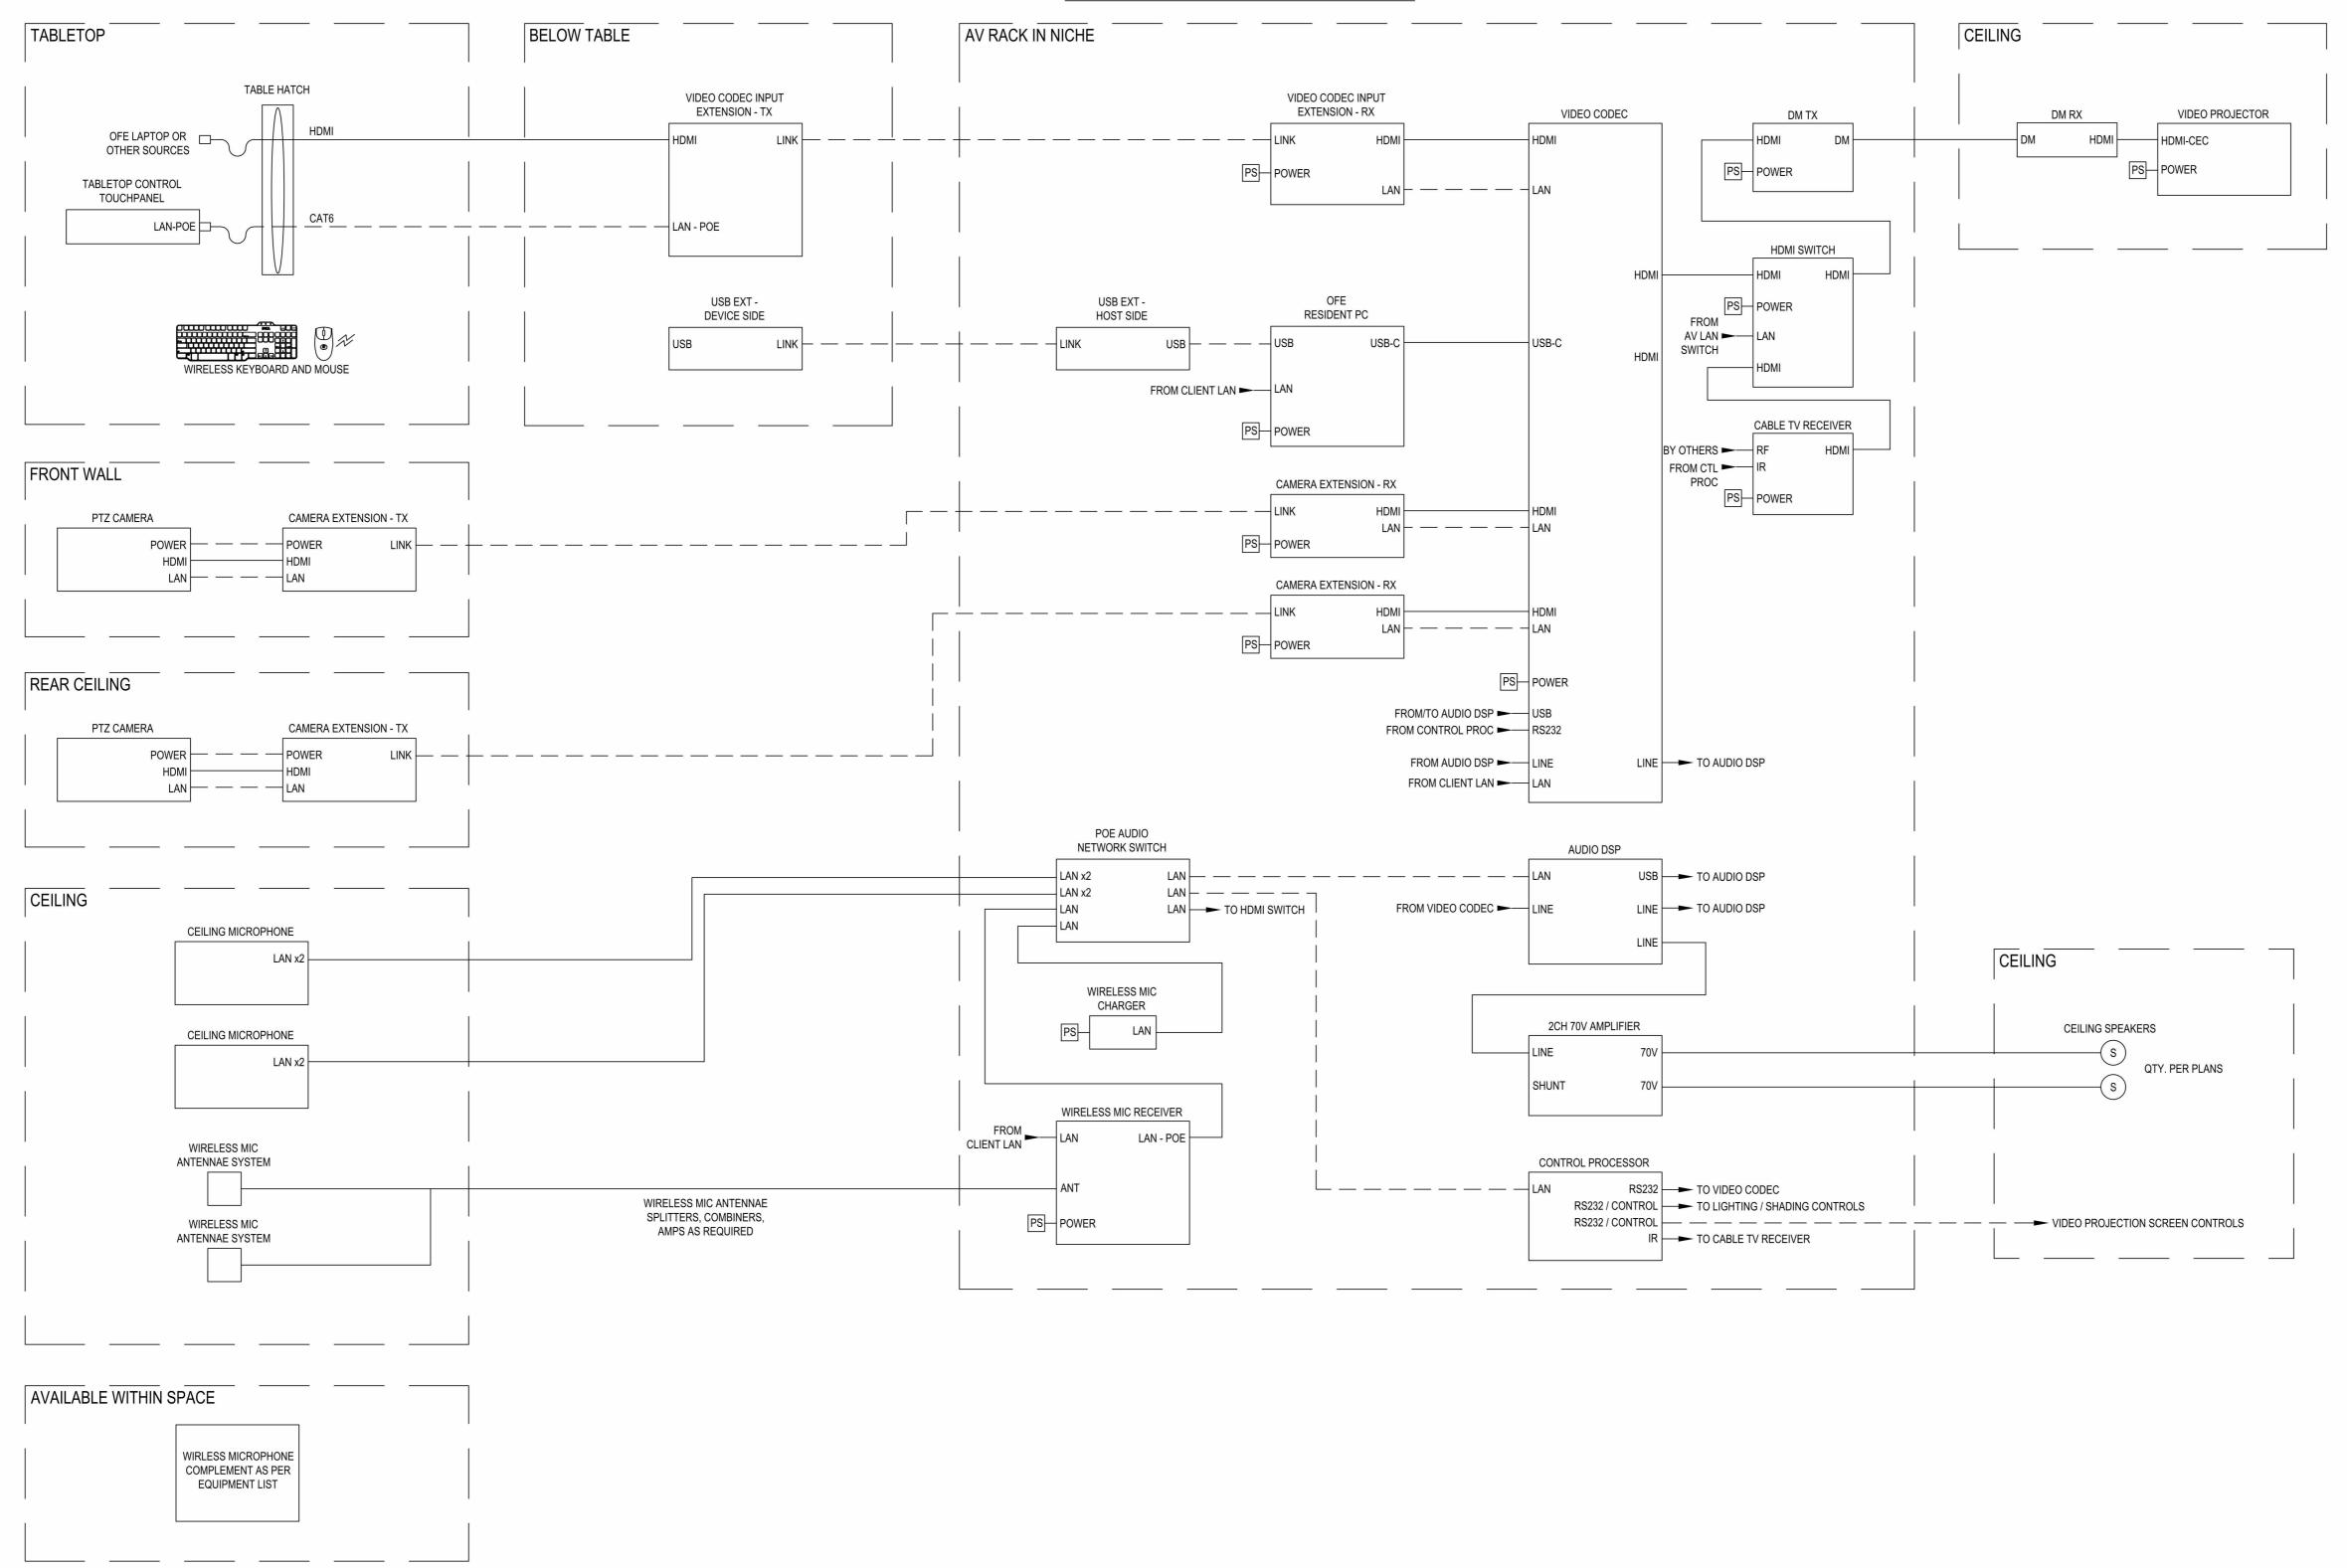
NO: DATE:

KEY PLAN:

12/11/24
PROJECT NO.: 21-048-1165.02

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SYSTEM FLOW DIAGRAM - CONFERENCE ROOM A





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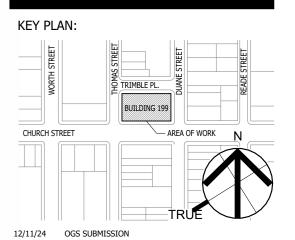
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2 1/29/25 1 12/11/24 NO: DATE:

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OGS PROJECT NO: SF760

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12/11/24

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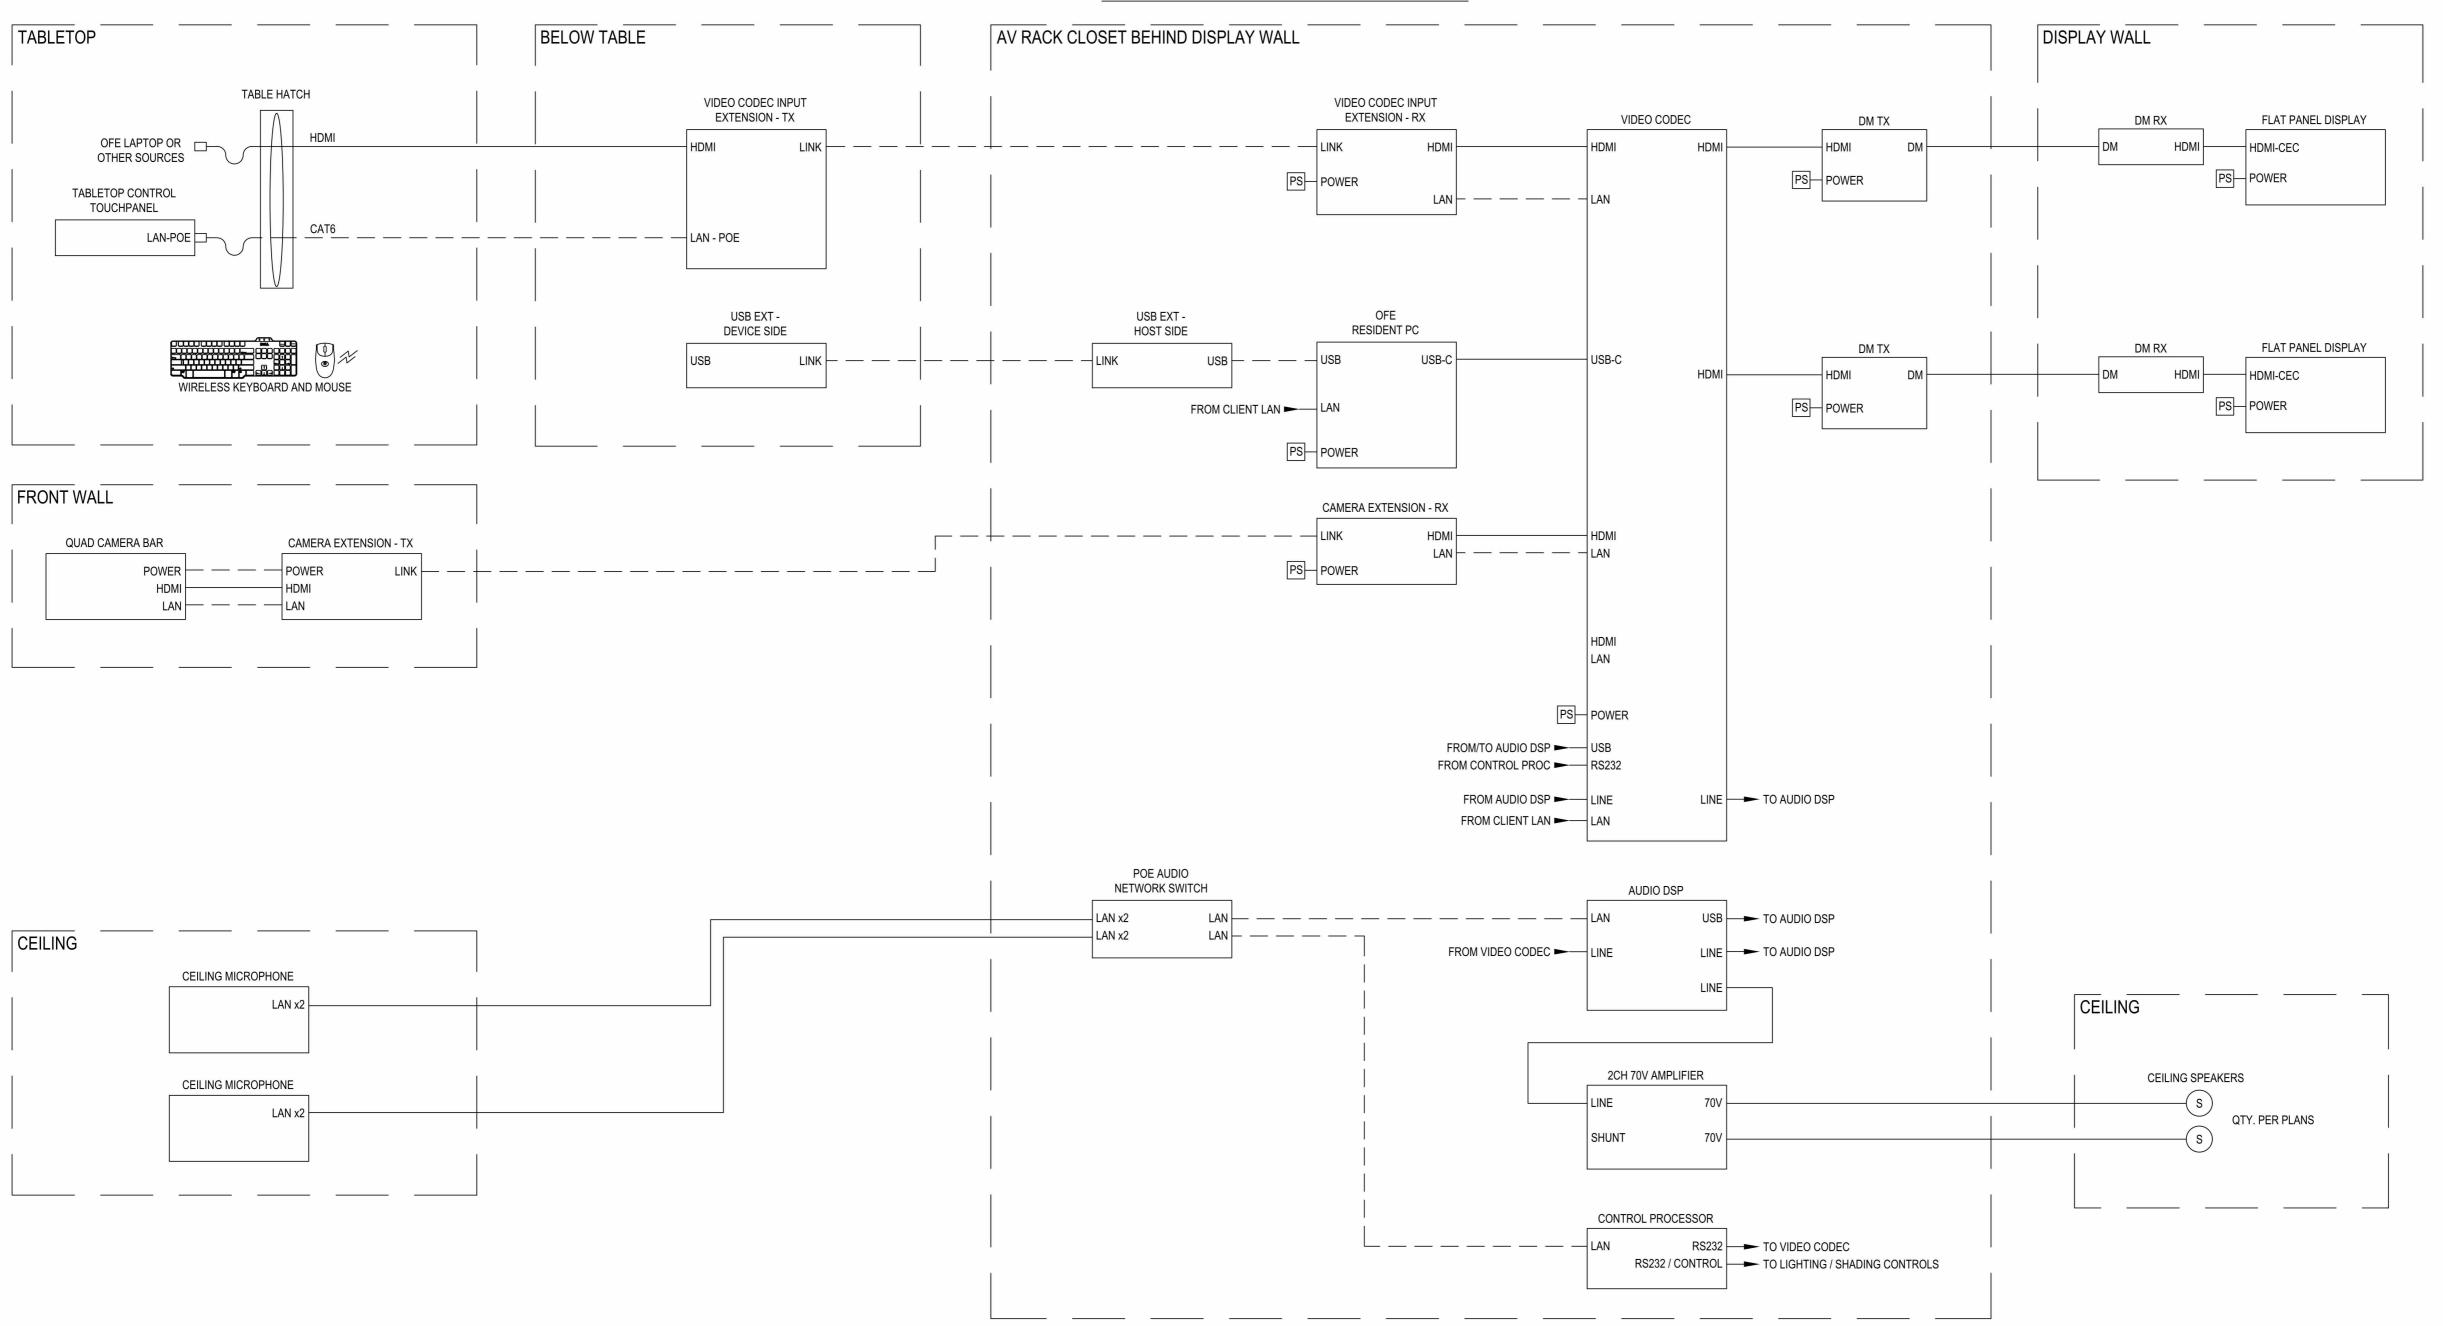
21-048-1165.02

DRAWING NO.:

TA.700

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SYSTEM FLOW DIAGRAM - CONFERENCE ROOM B





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KEY PLAN:

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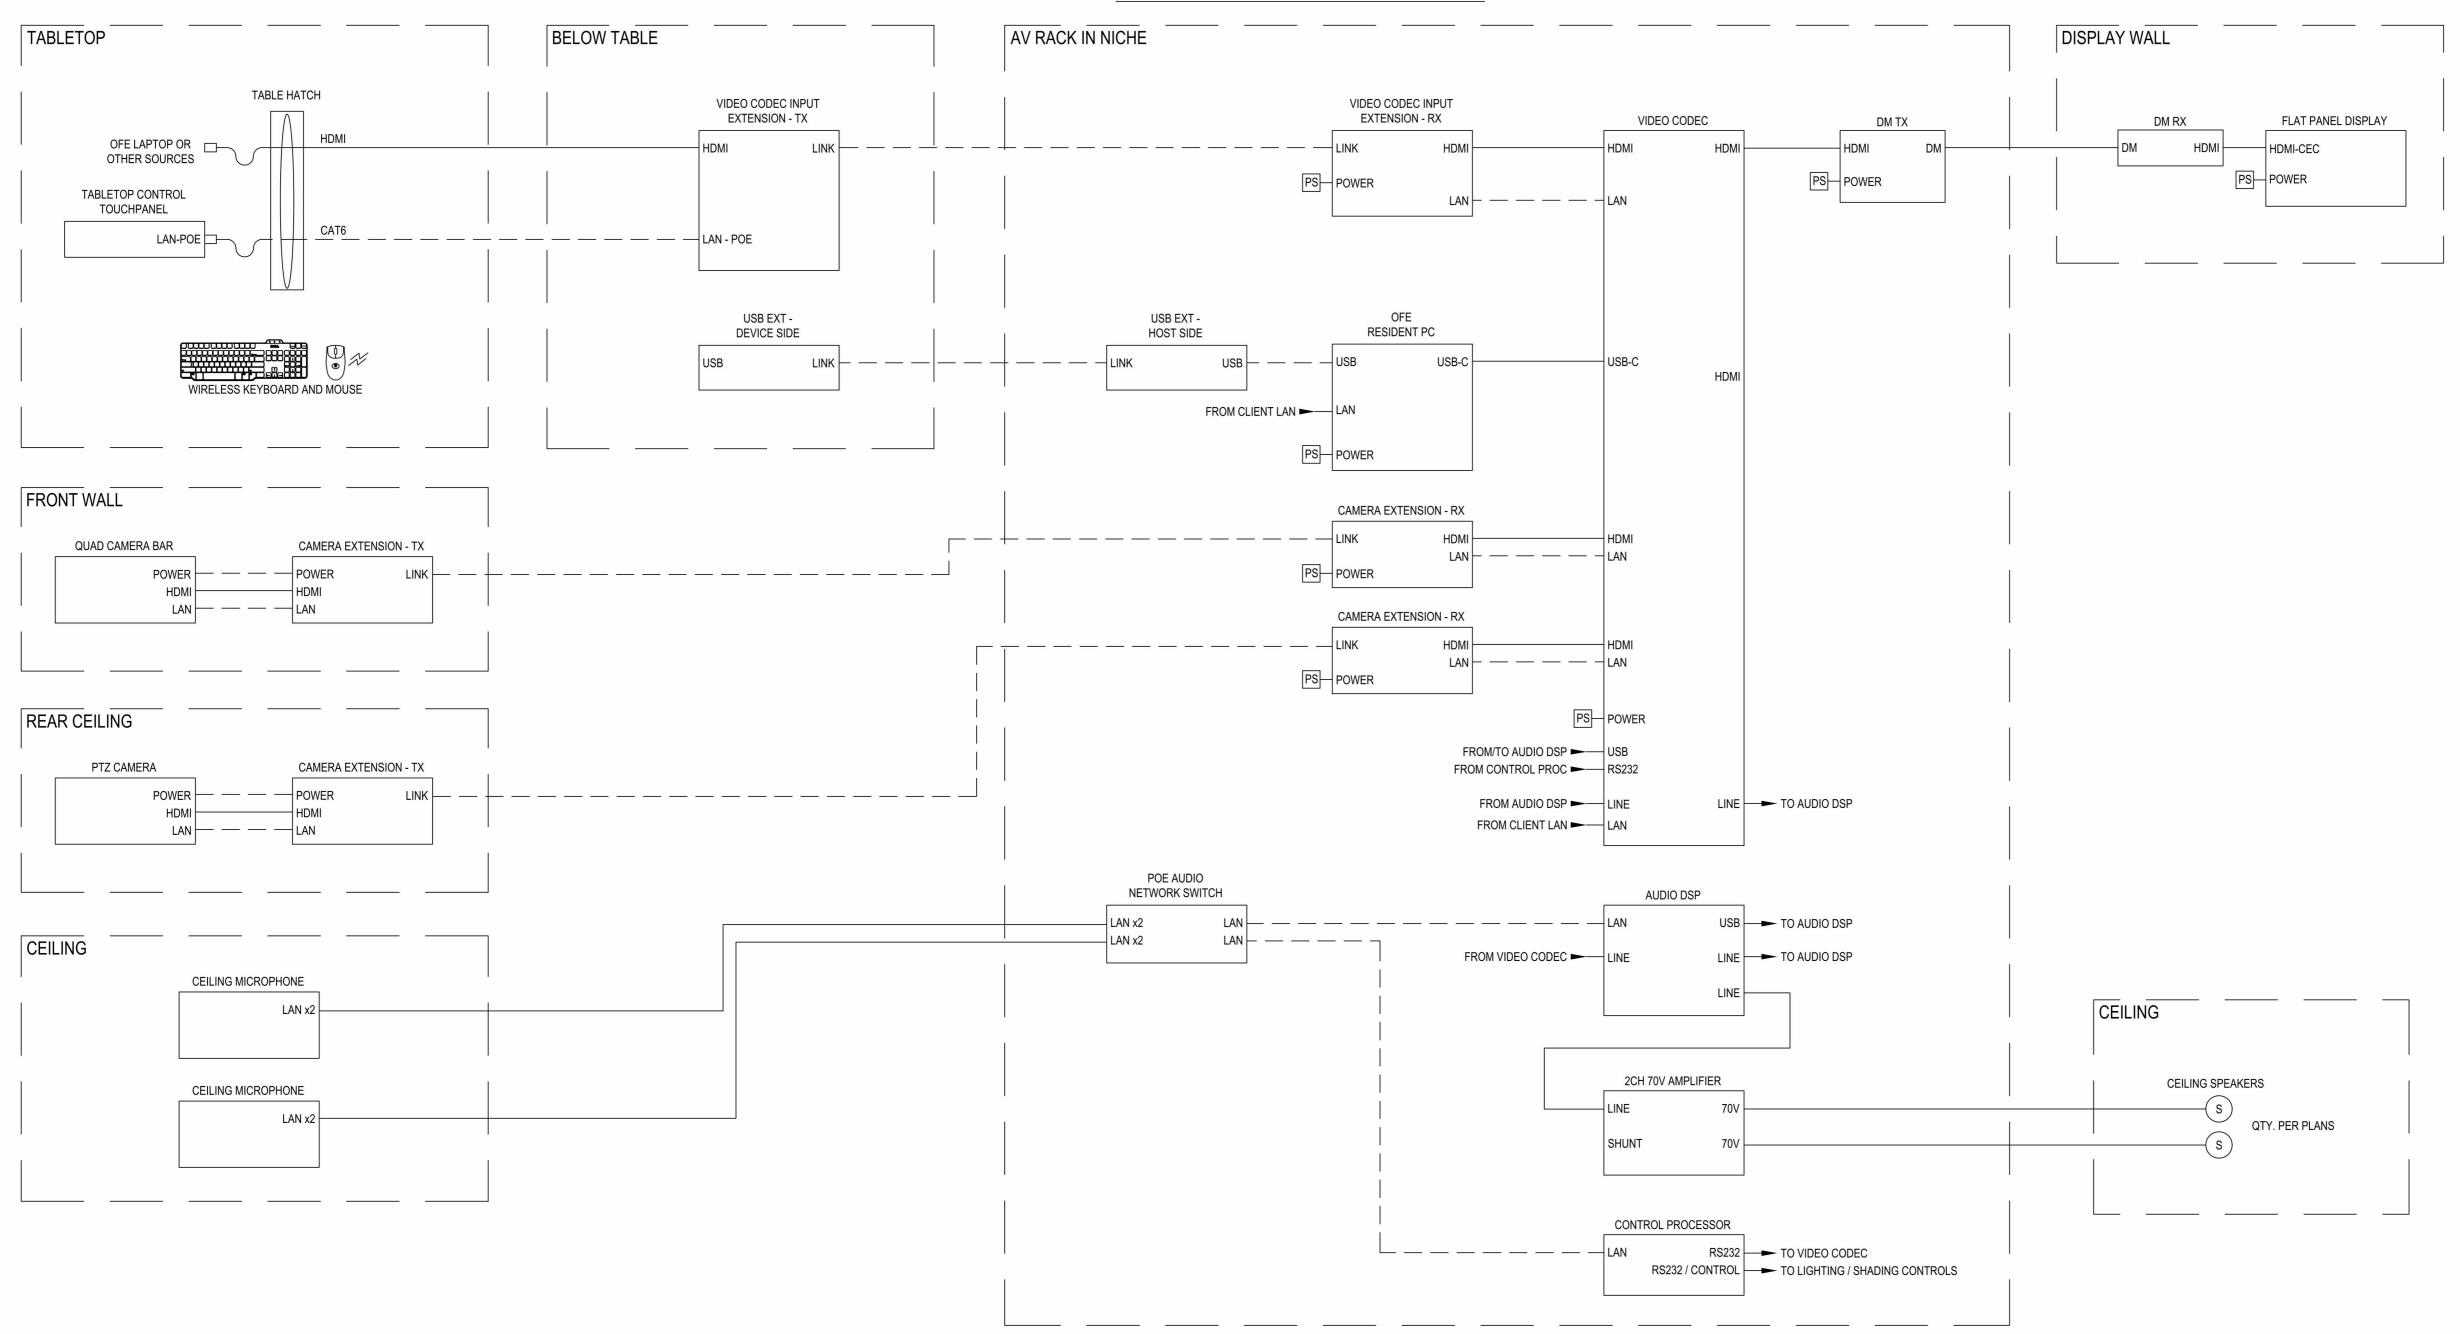
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SYSTEM FLOW DIAGRAM - TRAINING ROOMS 1 + 2





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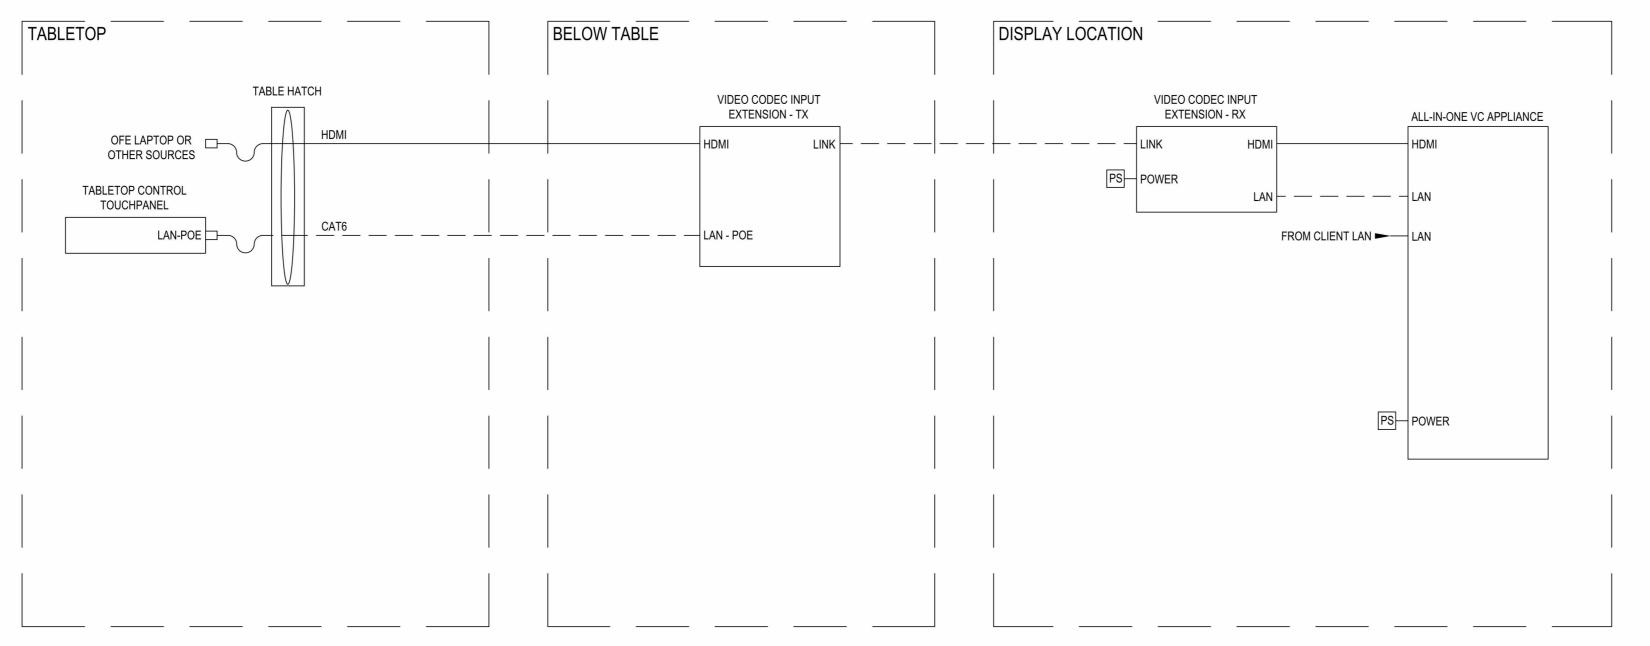
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21-048-1165.02

DRAWING NO.:

TA.702

PROJECT LOCATION:

SYSTEM FLOW DIAGRAM - TRAINING ROOM 3





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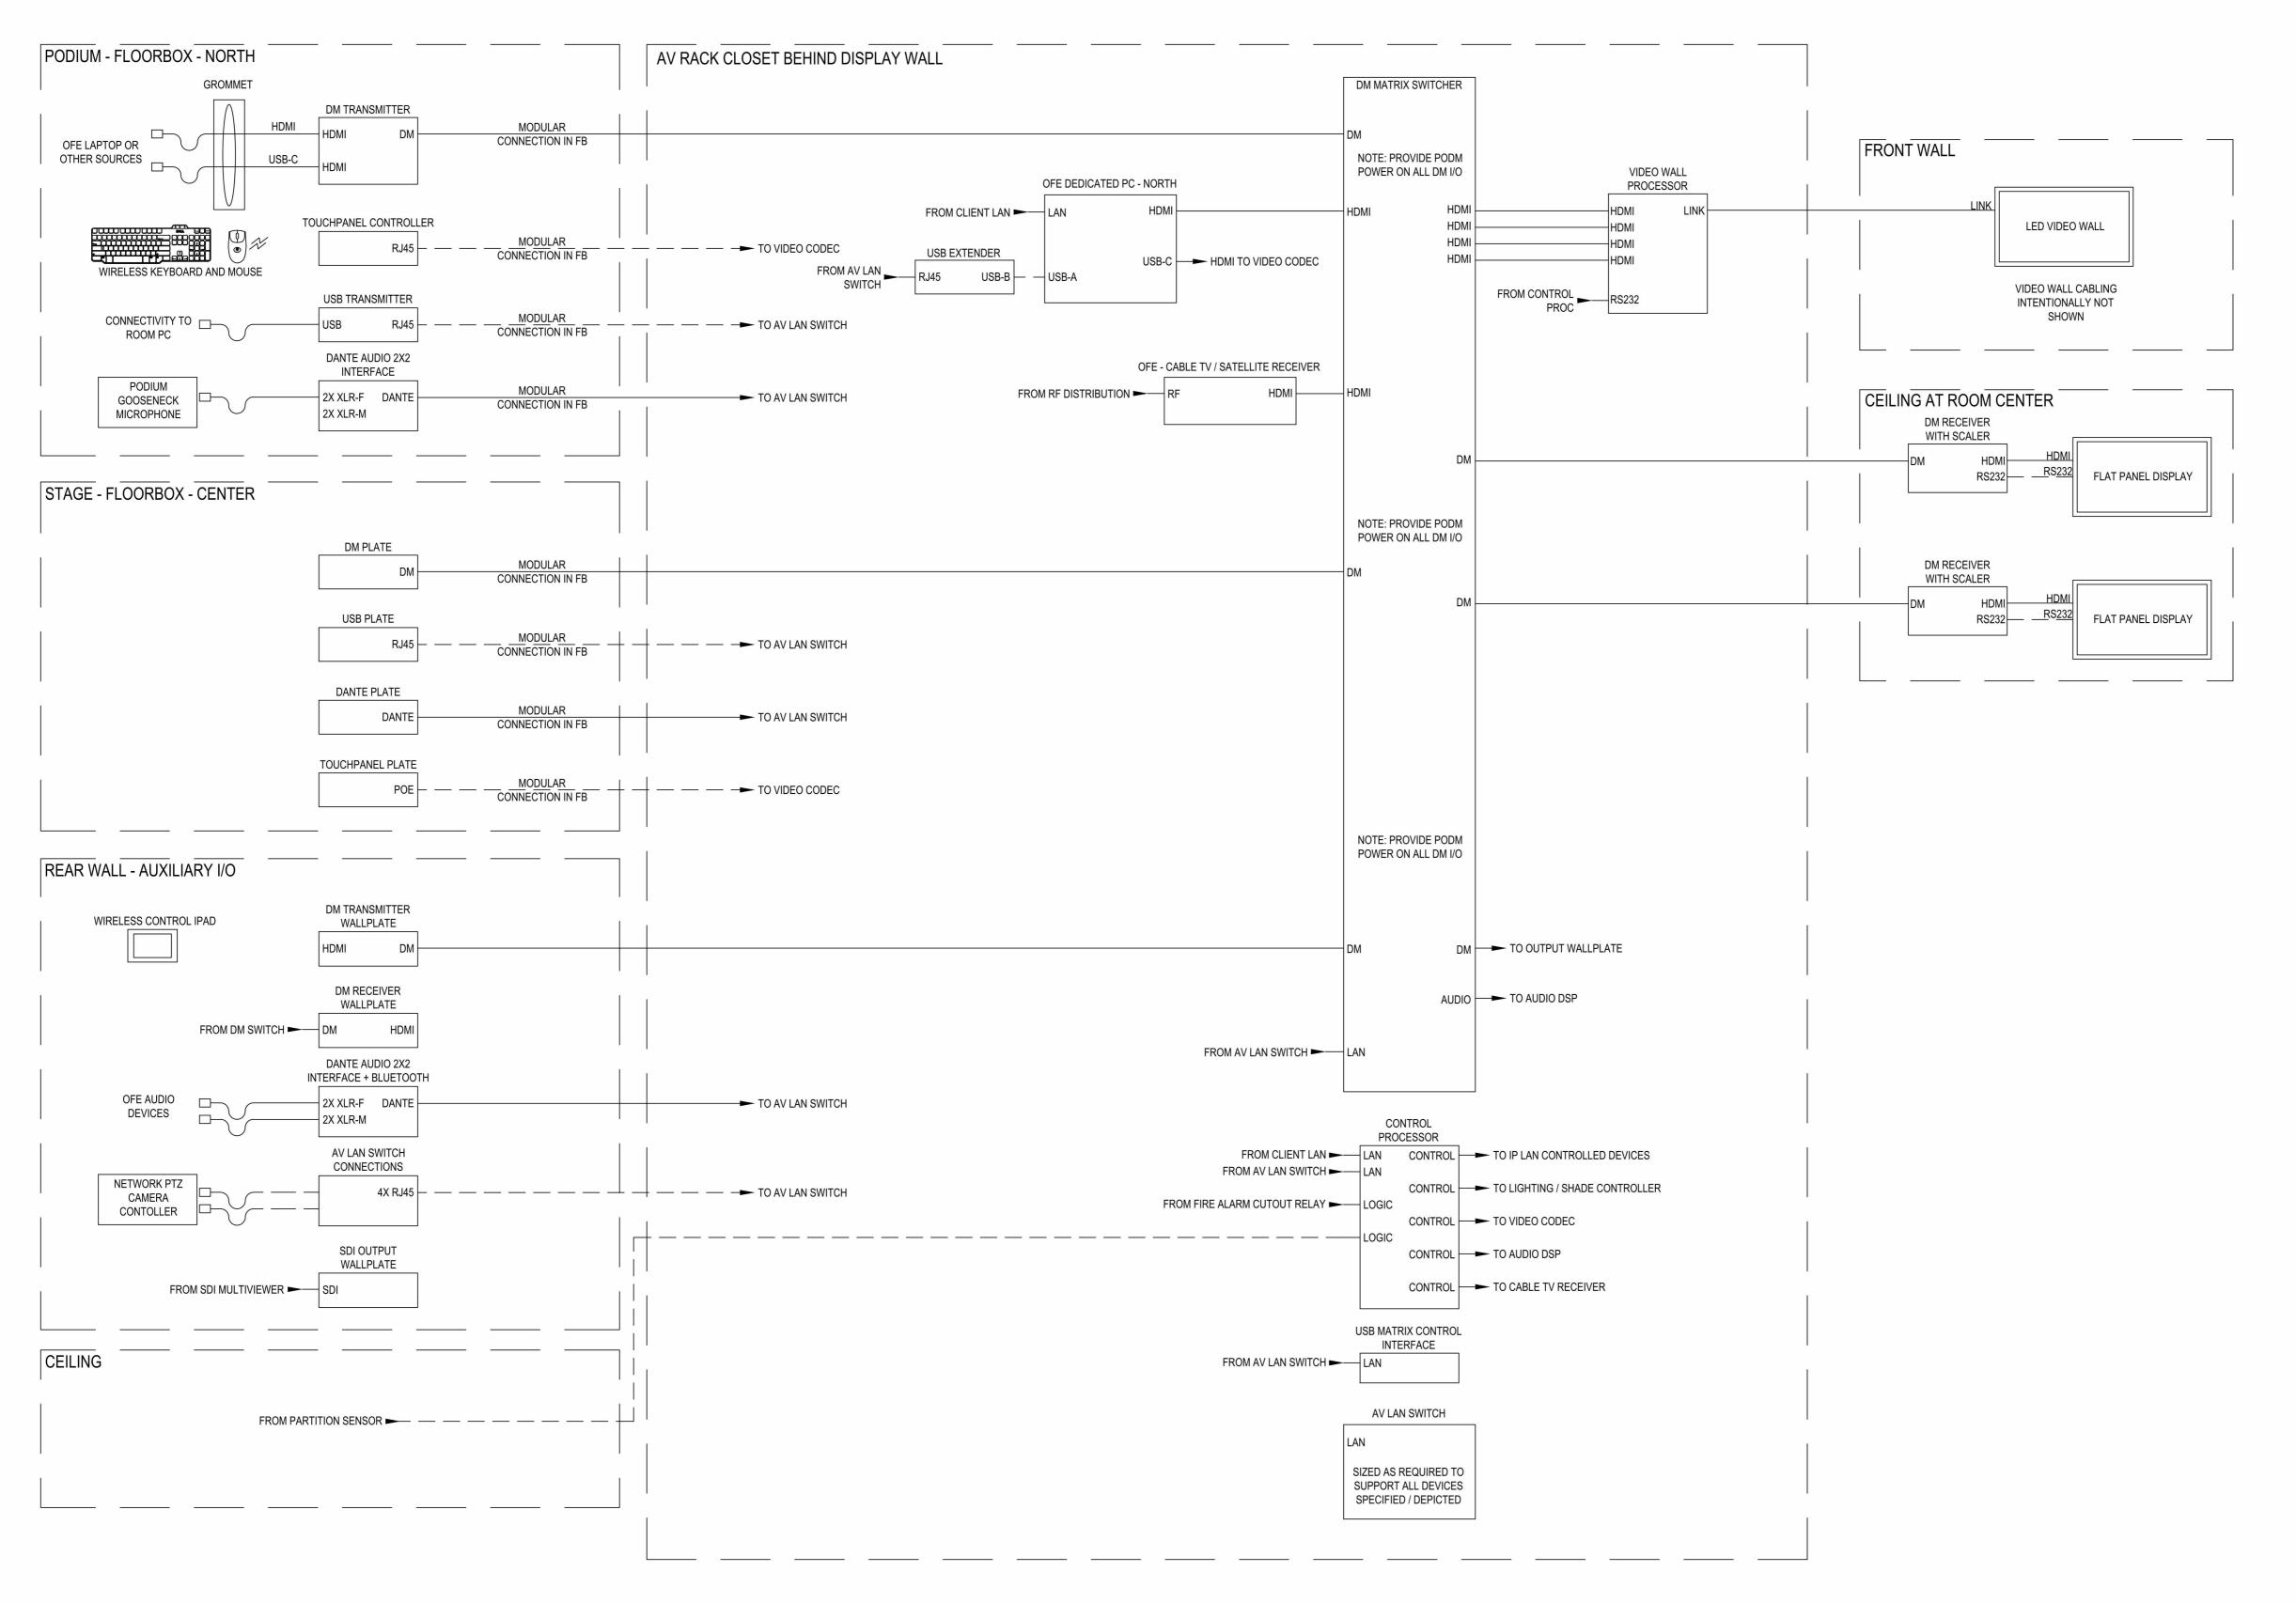
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DRAWING NO.:

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PROJECT LOCATION:
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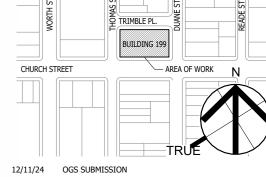
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OGS PROJECT NO: SF760

DRAWING TITLE:

AUDIOVISUAL SYSTEM DIAGRAMS

12/11/24


PROJECT NO.: SCALE:
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PROJECT LOCATION:
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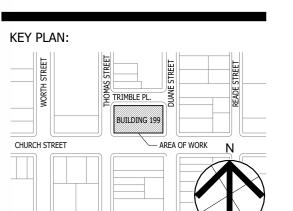
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OGS PROJECT NO: SF760

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12/11/24

PROJECT NO.: SCALE:
21-048-1165.02

DRAWING NO.:

TA.705

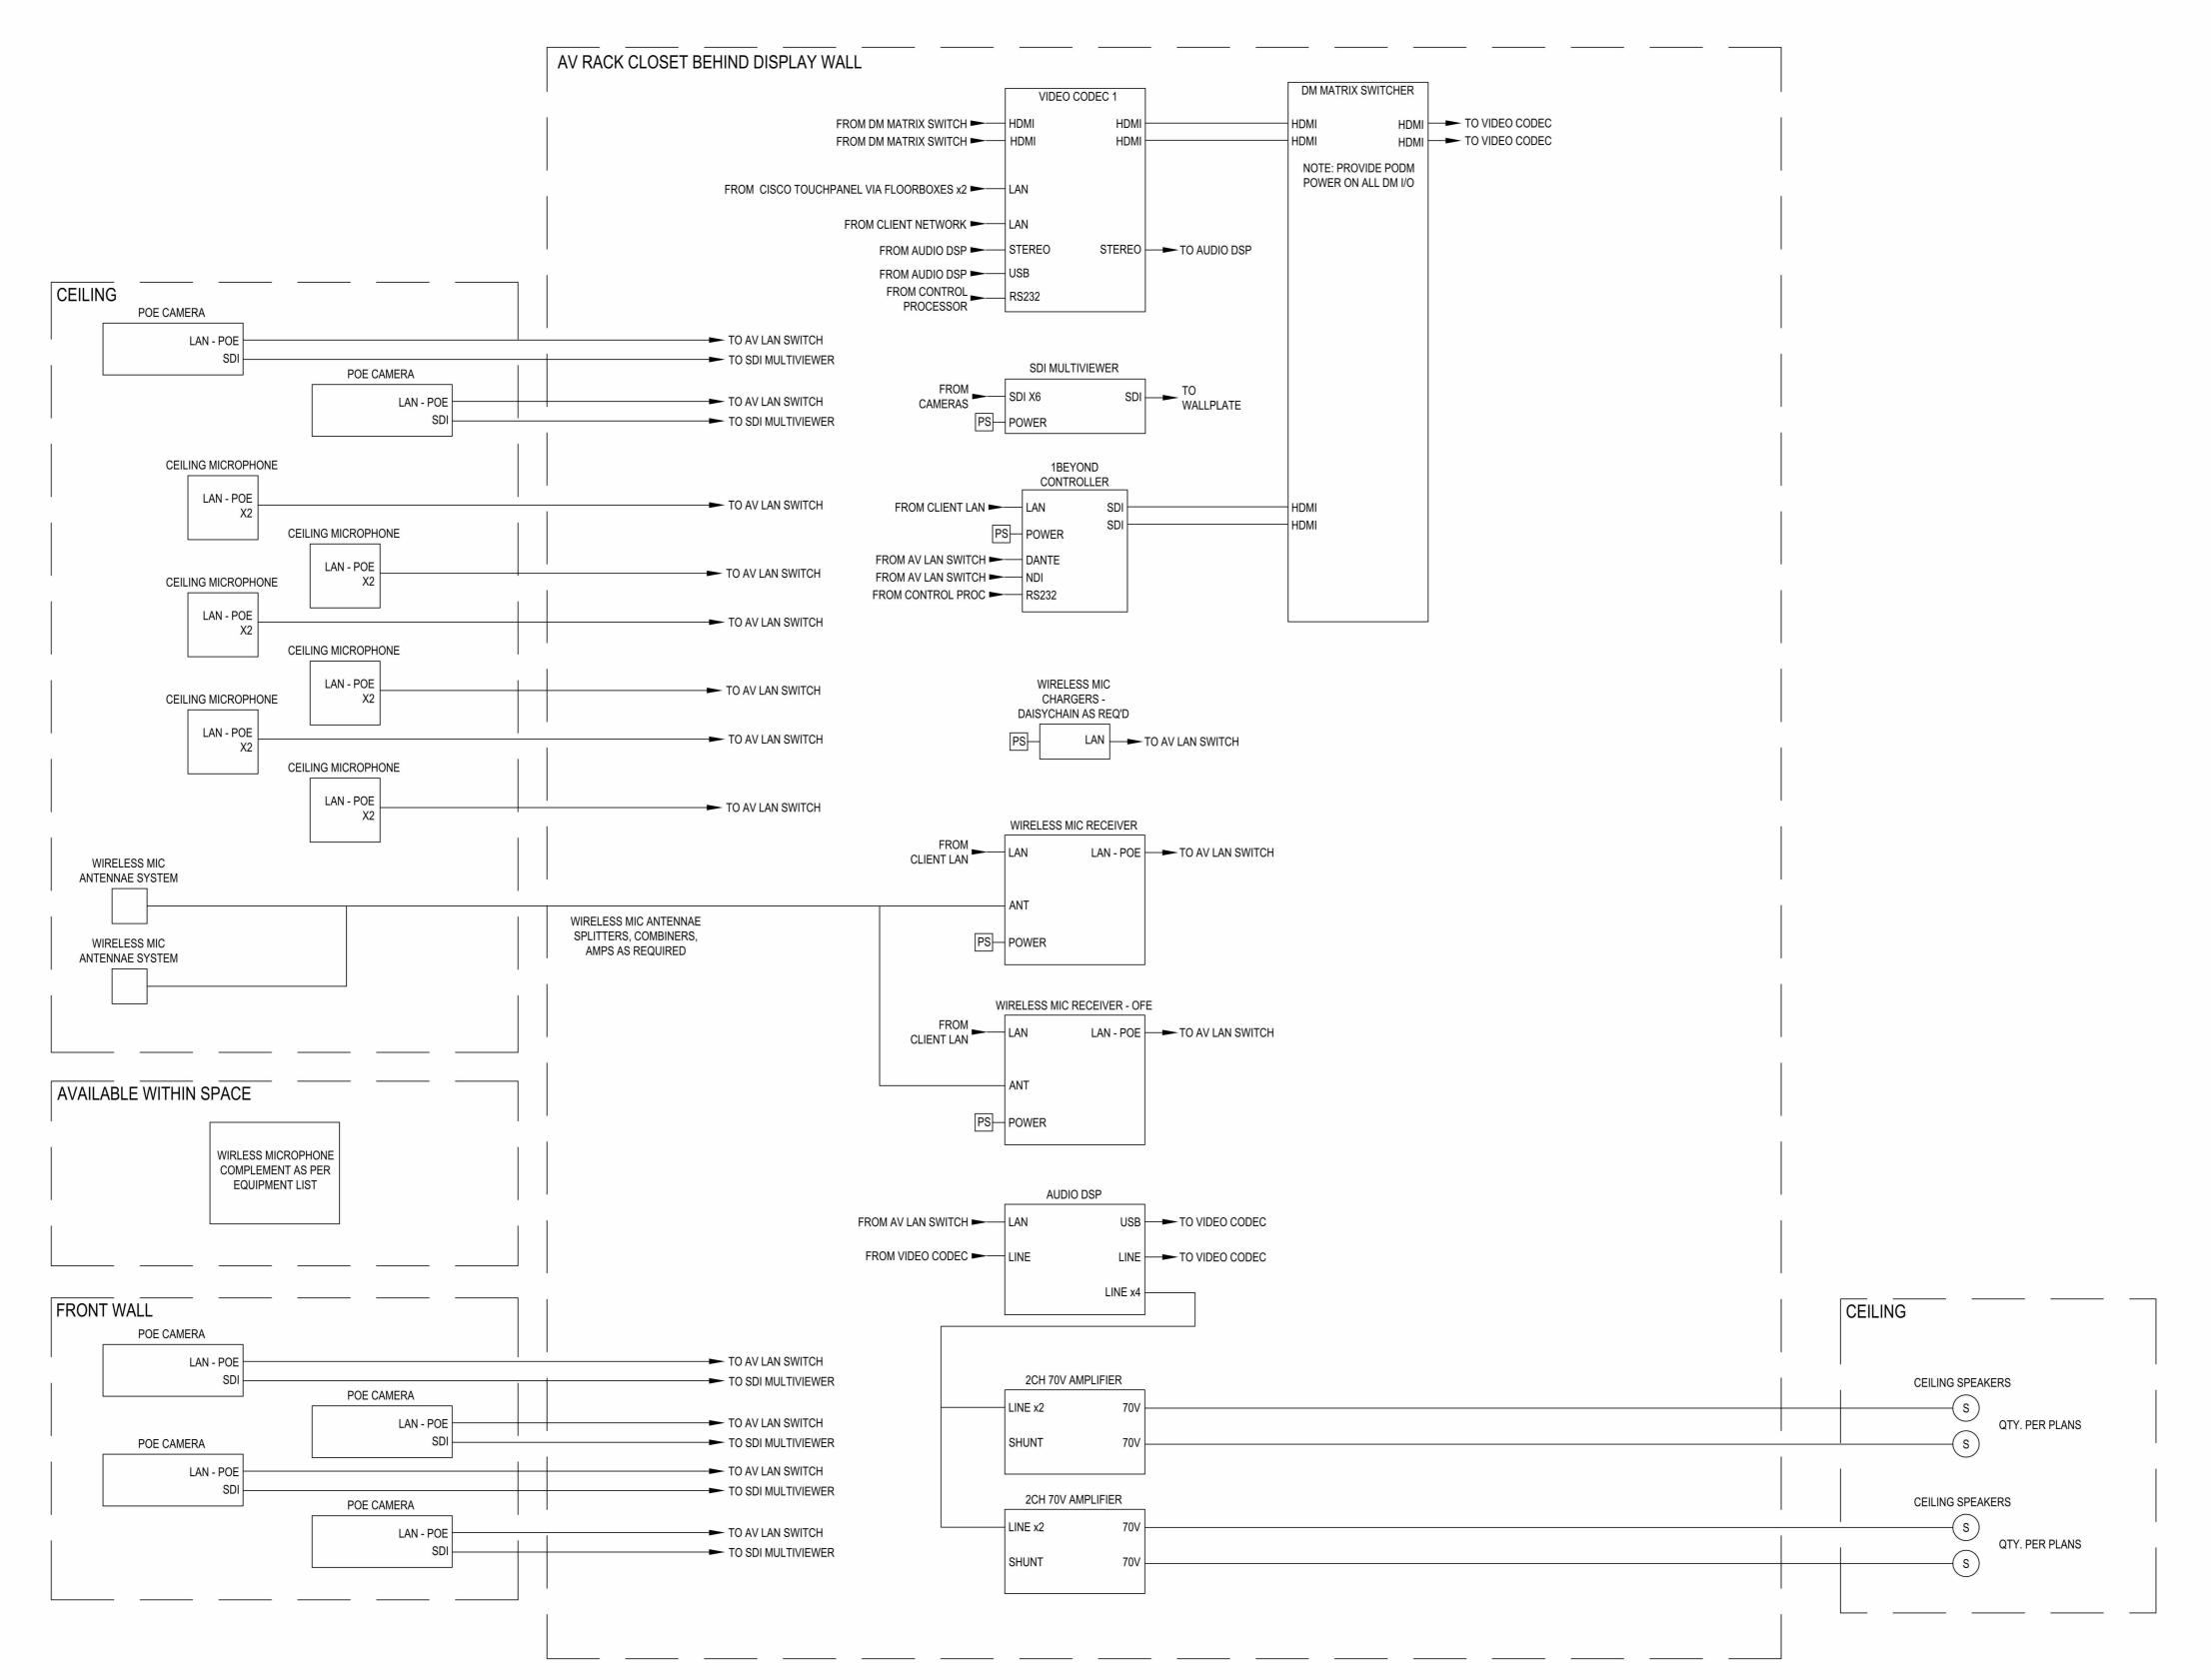PROJECT LOCATION:
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