


### REHABILITATE FACADE


### STATE INSURANCE FUND HEADQUARTERS 199 CHURCH STREET, NEW YORK, NY 10007 O.G.S. PROJECT NO. 45143-C

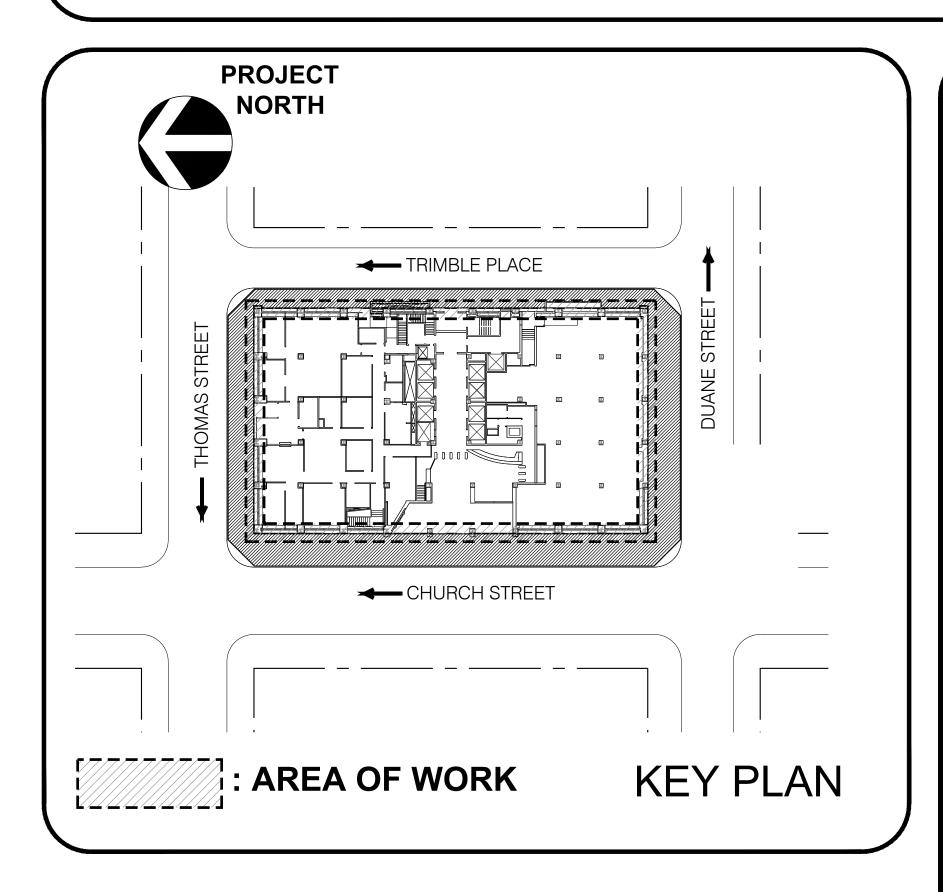

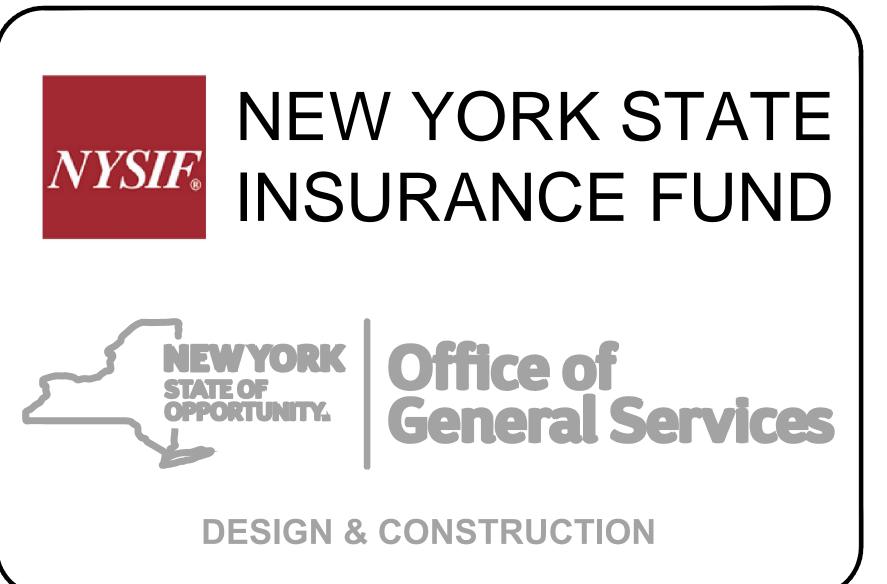

#### DRAWING LIST COVER SHEET **BUILDING SITE PLAN** SUPERSTRUCTURE PLAN WEST PART ELEVATION: BOTTOM (GROUND TO 11TH FLOOR) WEST PART ELEVATION: TOP (11TH FLOOR TO ROOF) NORTH PART ELEVATIONS: BOTTOM AND TOP EAST PART ELEVATION: BOTTOM (GROUND TO 11TH FLOOR) EAST PART ELEVATION: TOP (11TH FLOOR TO ROOF) S-205 SOUTH PART ELEVATIONS: BOTTOM AND TOP REMOVAL AND REPAIR DETAILS REMOVAL AND REPAIR DETAILS AT NORTHEAST AND SOUTHEAST CORNERS REMOVAL AND REPAIR DETAILS FOR NORTHWEST AND SOUTHWEST CORNERS REMOVAL AND REPAIR DETAILS FOR WEST FACADE REMOVAL AND REPAIR DETAILS FOR SOUTH FACADE AT 9TH FLOOR REMOVAL AND REPAIR DETAILS FOR SUPERSTRUCTURE REMOVAL AND REPAIR DETAILS FOR SUPERSTRUCTURE

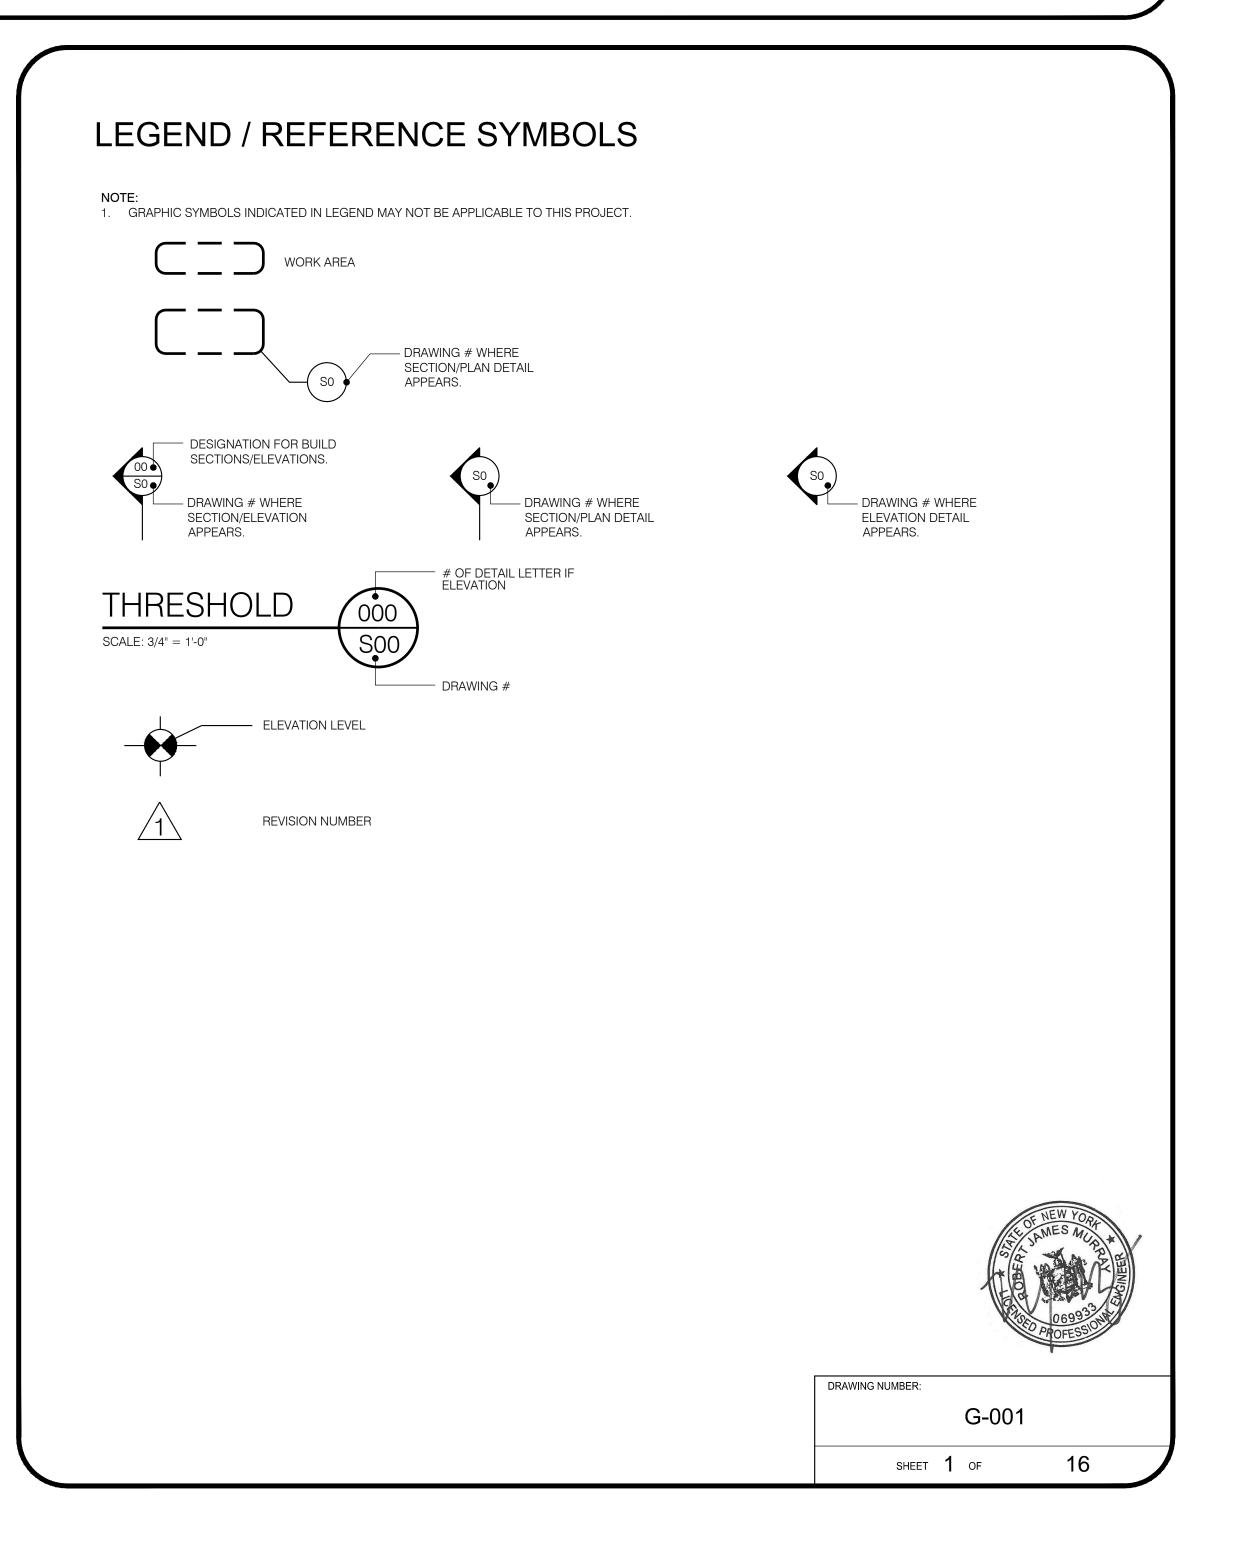

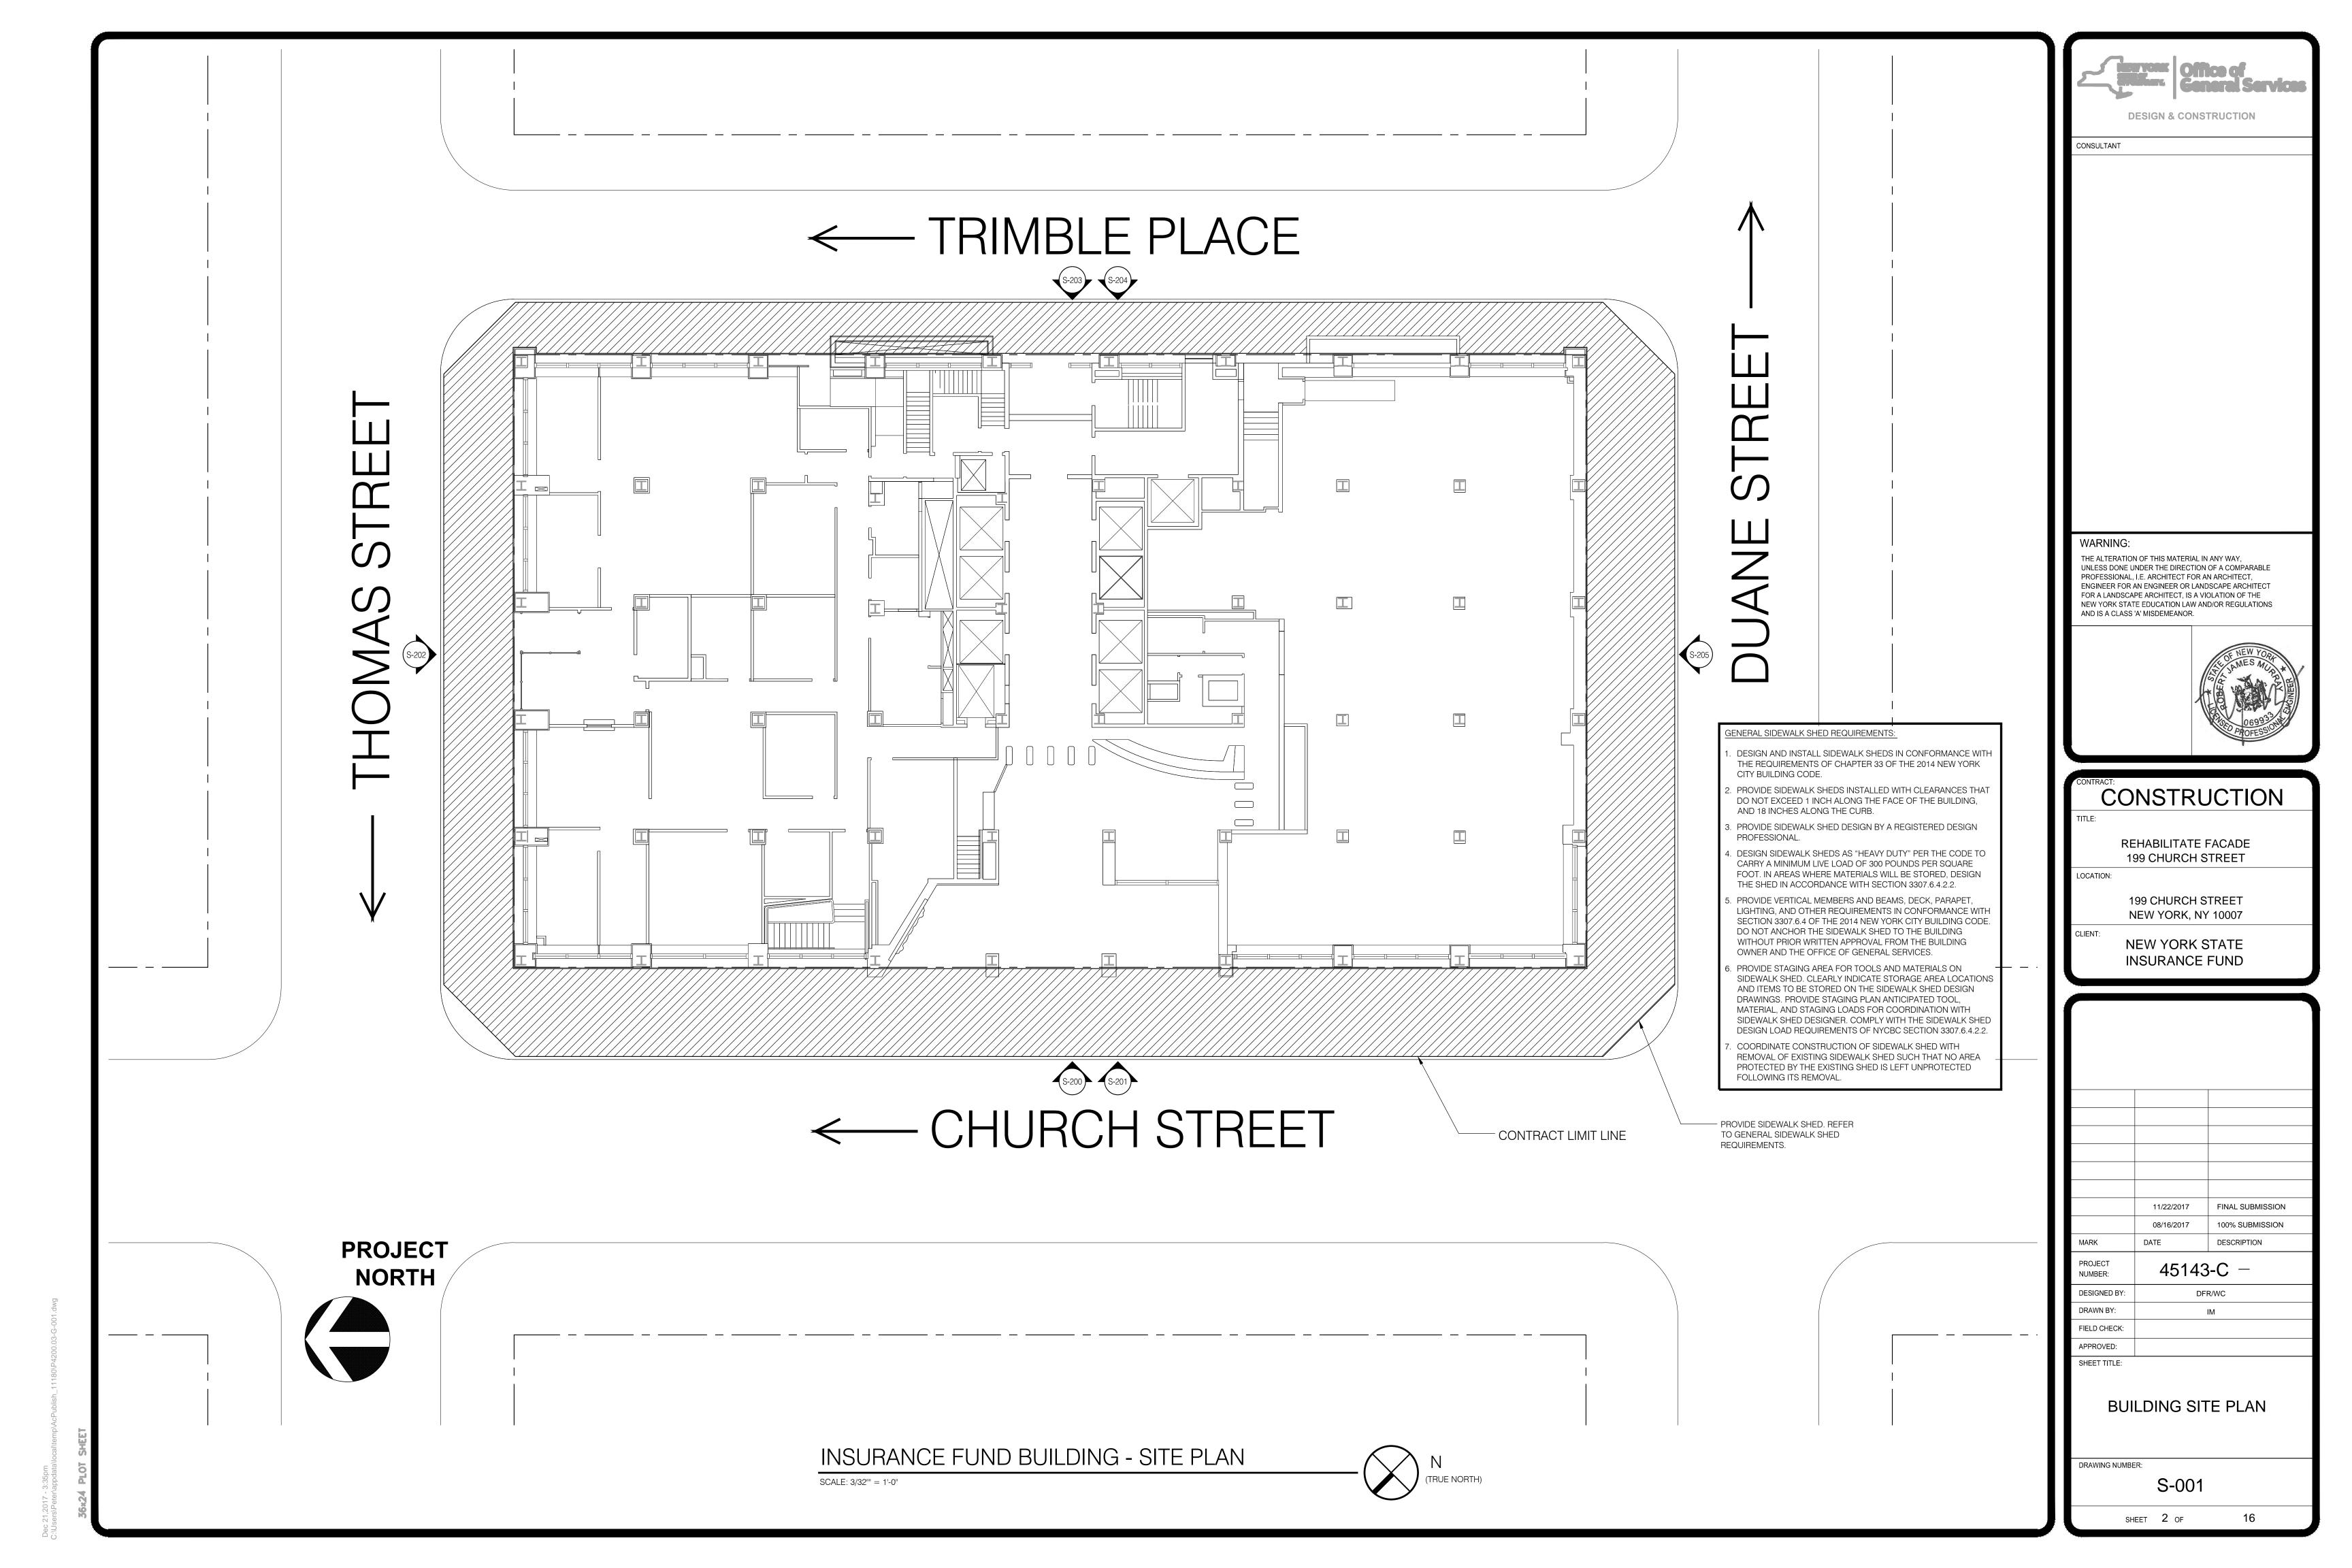


OUTLINE OF ROOF BELOW — OUTLINE OF FAN ROOM BULKHEAD ROOF BELOW —— – SEGMENT 2 – SEGMENT 3 -- STEEL TRUSSES TO BE REPAIRED (TYP.) SEQUENCE OF WORK FOR STEEL TRUSSES: . REMOVE PAINT FROM ACCESSIBLE AREAS (DEFINED ON 3/S-306) OF EXISTING STEEL TRUSSES. . PREPARE ACCESSIBLE AREAS OF EXISTING STEEL TRUSSES IN ACCORDANCE WITH PROJECT MANUAL, SPECIFICATION SECTION 099101. 3. INSTALL TRUSS CONNECTION REINFORCEMENT PER 2/S-306 AND 9/S-306. 4. INSTALL TRUSS BRACING PER 4/S-306 THROUGH 8/S-306. ABATE EXISTING ASBESTOS CONTAINING METAL PARAPET 5. APPLY 3-PART COATING TO ACCESSIBLE AREAS OF STEEL TRUSSES IN CAP JOINT SEALANT AT ALL ACCORDANCE WITH PROJECT MANUAL, SPECIFICATION SECTION 099101. — — ∃T17 JOINT LOCATIONS (APPROX 8 SF TOTAL). SEE 7/S-305 DETAIL - APPROX. OUTLINE OF EXISTING COOLING TOWER FOR MORE INFORMATION. TO BE REPLACED UNDER SEPARATE CONTRACT REFER TO PROJECT MANUAL, ∬— — — ∃T18 SPECIFICATION SECTION 028213. — - CONCRETE ENCASED STEEL BEAMS AND COLUMNS TO BE REPAIRED (TYP.) ABATE EXISTING ASBESTOS CONTAINING BLACK COATING & SEQUENCE OF WORK FOR CONCRETE ENCASED STRUCTURAL STEEL: **OUTLINE OF** OUTLINE OF FAN ROOM ADHESIVE FROM COLUMN 1. PERFORM SEQUENCE OF WORK DESCRIBED IN STEPS 3-10 BELOW FOR ENCASEMENT AND PARAPET (3 ROOF BELOW ———— BULKHEAD ROOF BELOW — SINGLE EDGE OF COOLING TOWER ENCLOSURE. WORK LOCATIONS - APPROX. 120 SF ALONG-NORTH-SOUTH EDGES TO BE PERFORMED IN TWO SECTIONS. TOTAL). SEE 5/S-305 DETAIL FOR 2. REPEAT STEP 1 FOR ALL SEGMENTS AT EDGES OF COOLING TOWER MORE INFORMATIONREFER TO ENCLOSURE (6 TOTAL). PROJECT MANUAL, 3. REMOVE AND STORE METAL FACING FROM SUPERSTRUCTURE PER 1/S-305. SPECIFICATION SECTION 4. REMOVE EXISTING CONCRETE ENCASEMENT TO EXPOSE STRUCTURAL 028213. -OUTLINE OF STEEL AS SHOWN IN DETAILS 1, 3, AND 7 ON S-305 (APPROX 450 LF). **ROOF BELOW** 5. REMOVE PAINT FROM EXISTING STRUCTURAL STEEL. **▼**T22 6. PREPARE SURFACE OF EXISTING STRUCTURAL STEEL TO RECEIVE PAINT. . PRIME EXISTING STRUCTURAL STEEL. REFER TO PROJECT MANUAL, SPECIFICATION SECTION 099101, FOR REMOVAL, SURFACE PREPARATION, AND PAINTING SPECIFICATIONS. 8. PROVIDE COLD FLUID APPLIED WATERPROOFING SYSTEM TO EXISTING STEEL COLUMNS AS SHOWN IN 6/S-305 AND 8/S-305. . PROVIDE CONCRETE ENCASEMENT AND FASTENERS PER DETAILS 2, 4, AND 8 ON S-305. REFER TO PROJECT MANUAL, SPECIFICATION SECTIONS 033000 10. REINSTALL ALUMINUM FACING PER 4/S-305. OUTLINE OF FAN ROOM - SEGMENT 6 -SEGMENT 5 -BULKHEAD ROOF BELOW -LONG NORTH-SOUTH EDGE TO BE LONG NORTH-SOUTH EDGE TO BE REPAIRED IN TWO EQUAL LENGTH SECTION REPAIRED IN TWO EQUAL LENGTH SECTION — OUTLINE OF **ROOF BELOW** 

**DESIGN & CONSTRUCTION** 

CONSULTANT

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#### CONSTRUCTION

REHABILITATE FACADE

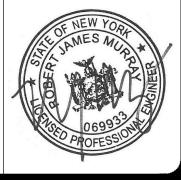STATE INSURANCE FUND HEADQUARTERS 199 CHURCH STREET NEW YORK, NY 10007

STATE INSURANCE FUND

FINAL SUBMISSION 100% SUBMISSION DATE DESCRIPTION PROJECT 45143-C -NUMBER:

DESIGNED BY: DRAWN BY: FIELD CHECK:

APPROVED: SHEET TITLE:

SUPERSTRUCTURE PLAN

DRAWING NUMBER:

S-100


SUPERSTRUCTURE ROOF PLAN

SCALE: 1/8" = 1'-0"

**PROJECT** 


**NORTH** 

REFER TO SHEETS S-305 AND S-306 FOR SUPERSTRUCTURE REPAIR AND MAINTENANCE DETAILS.
T# INDICATES TRUSS NUMBER REFERENCED ON SHEET S-306.

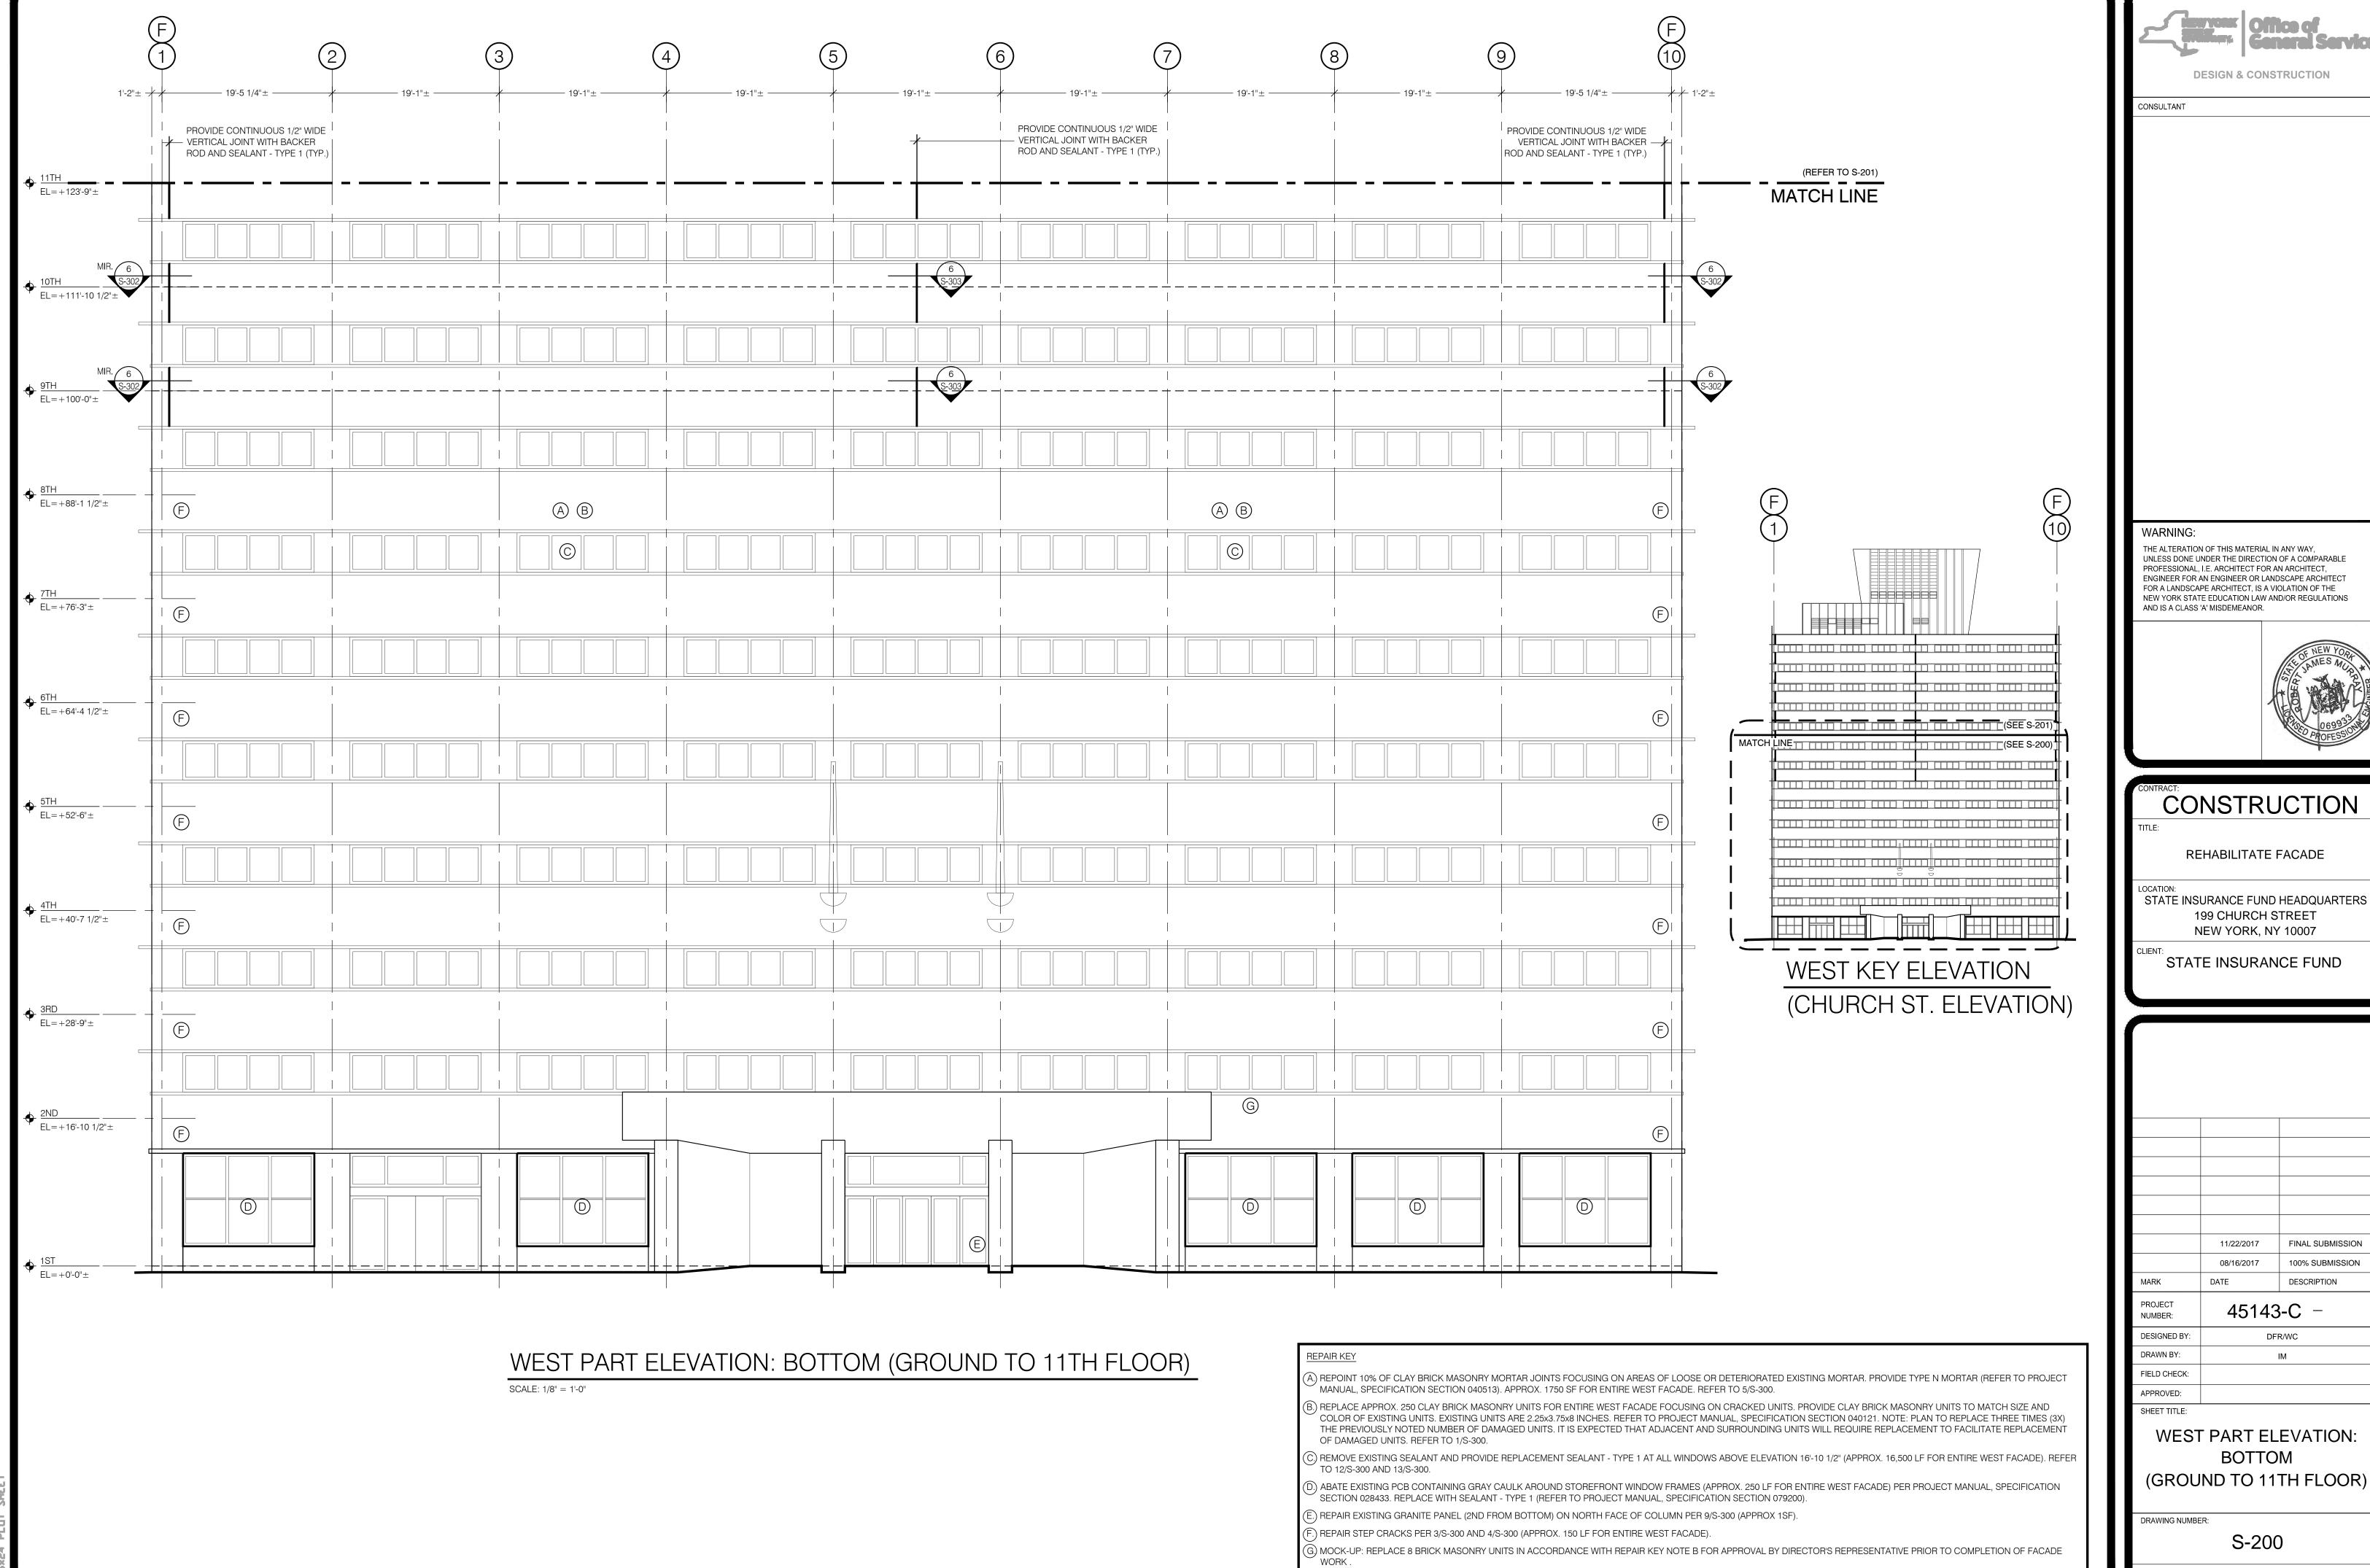

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SHEET 4 OF 1

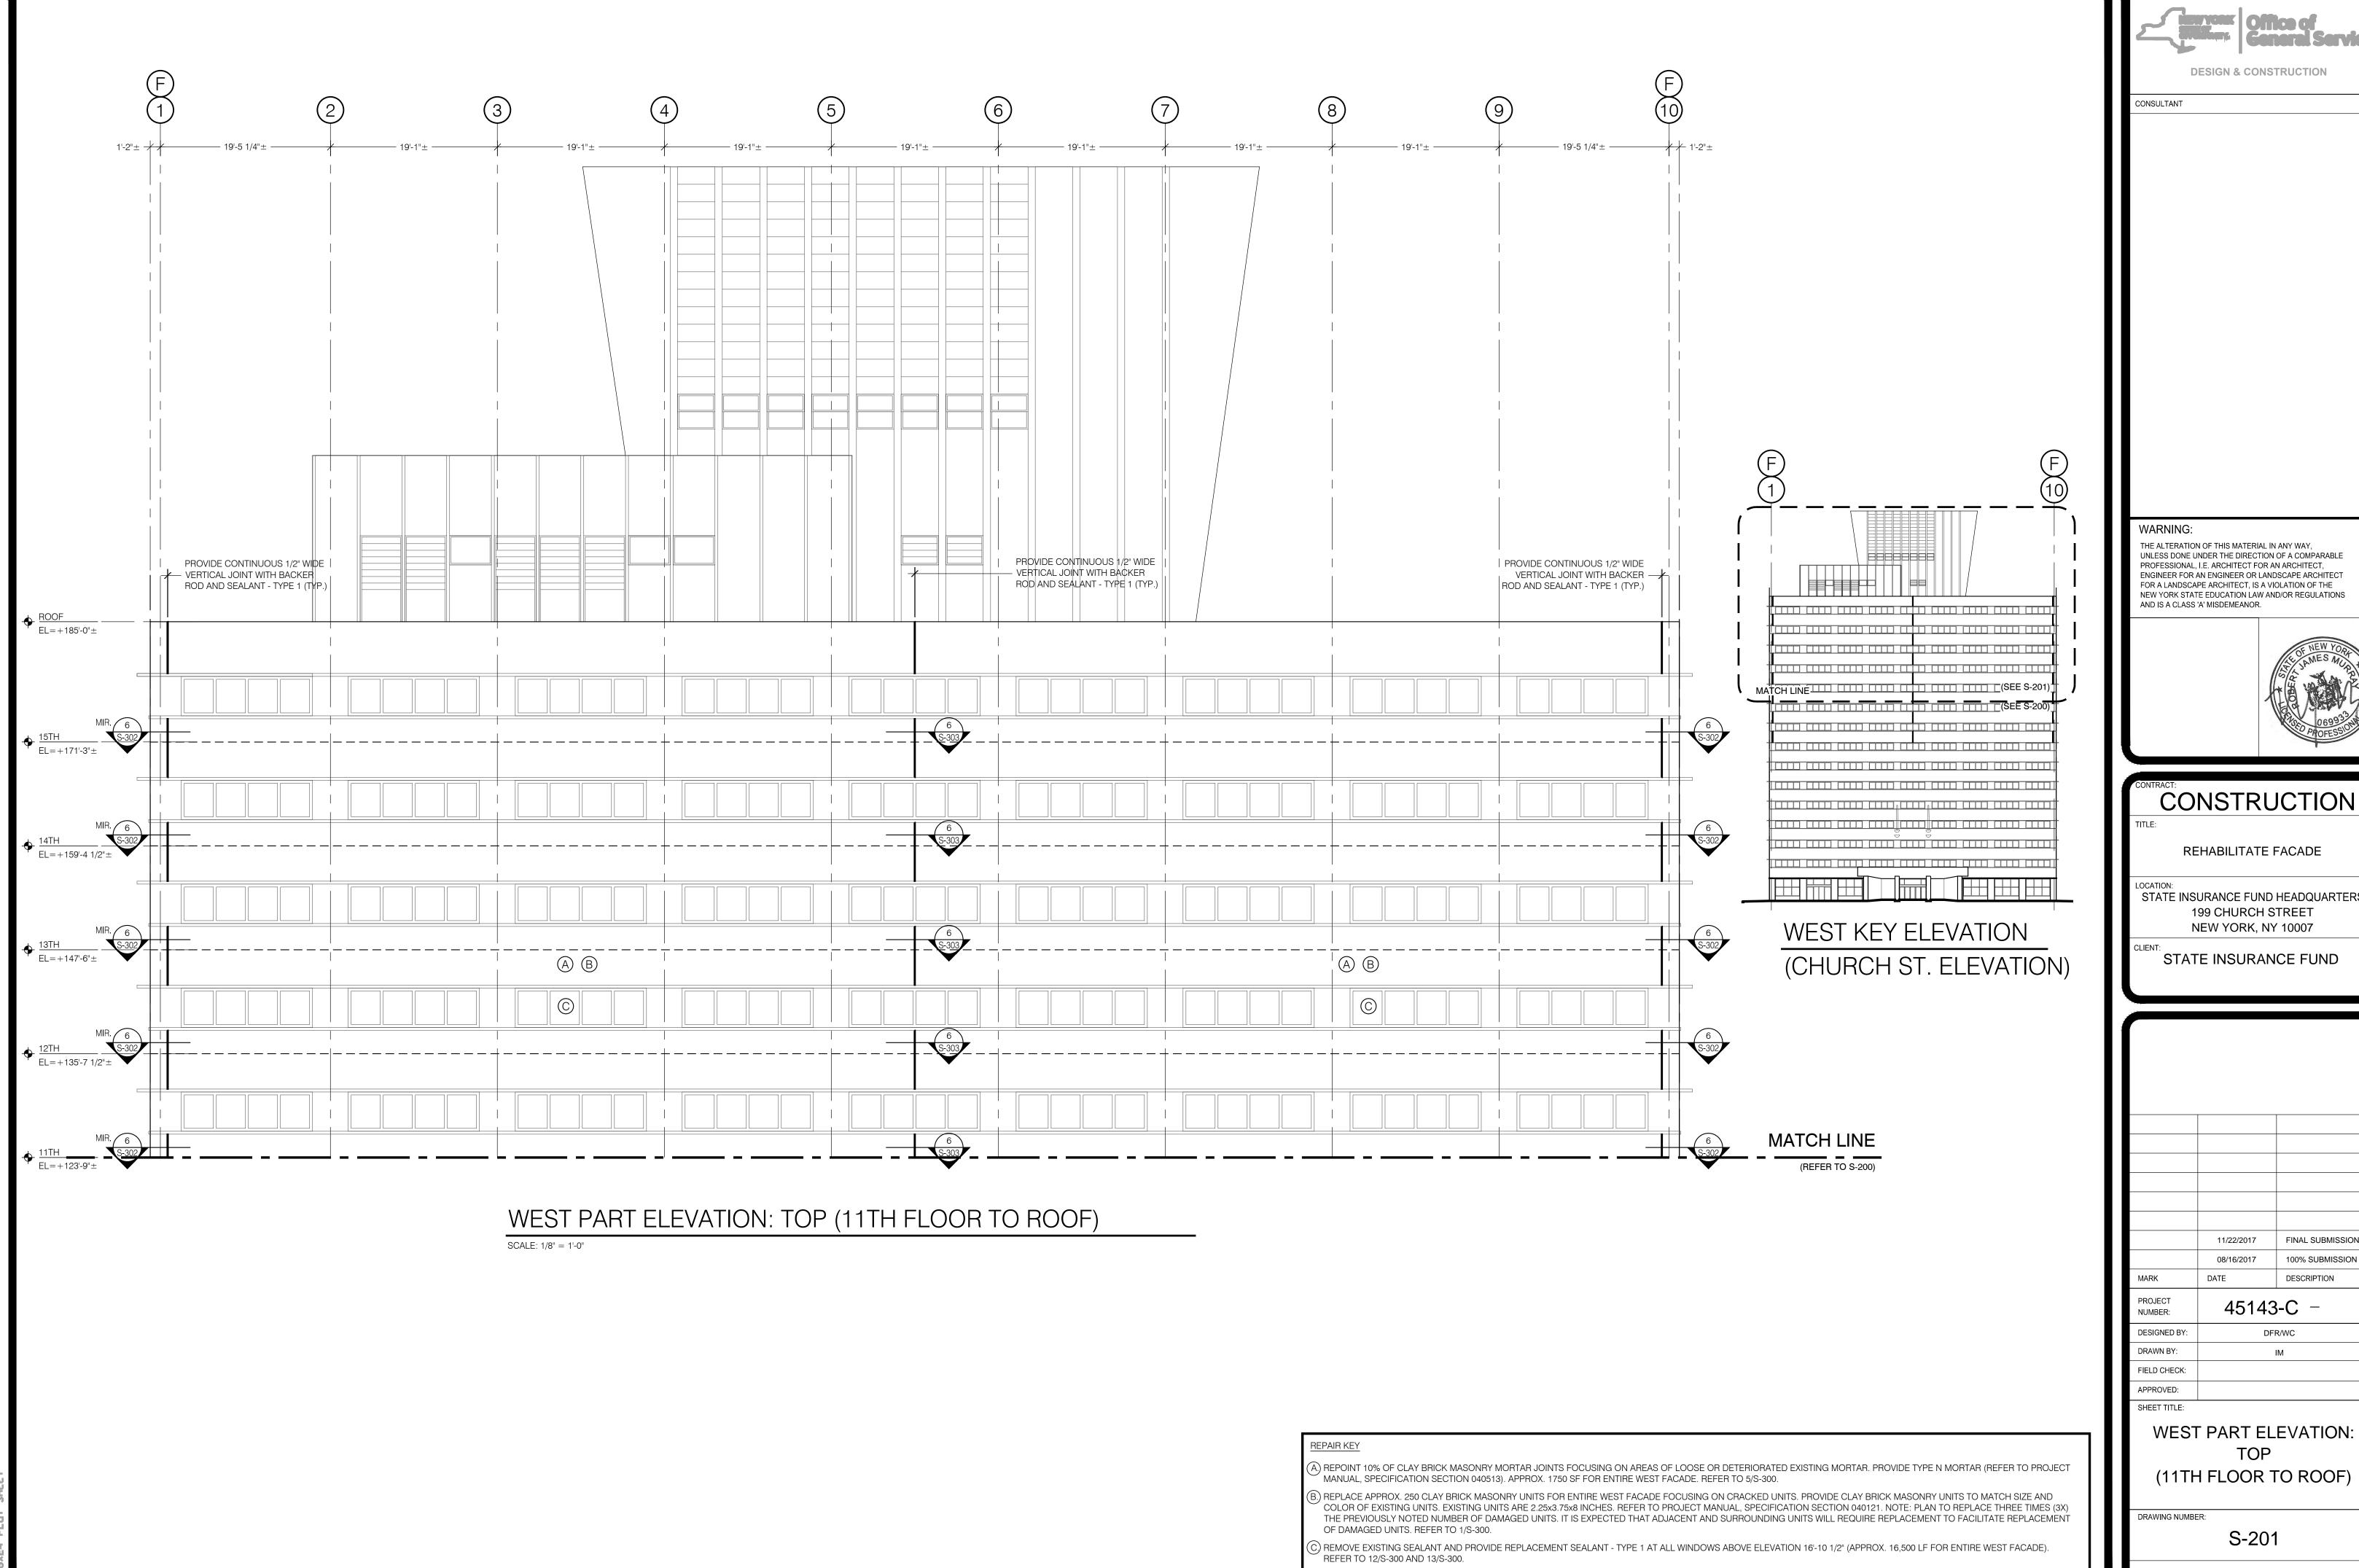

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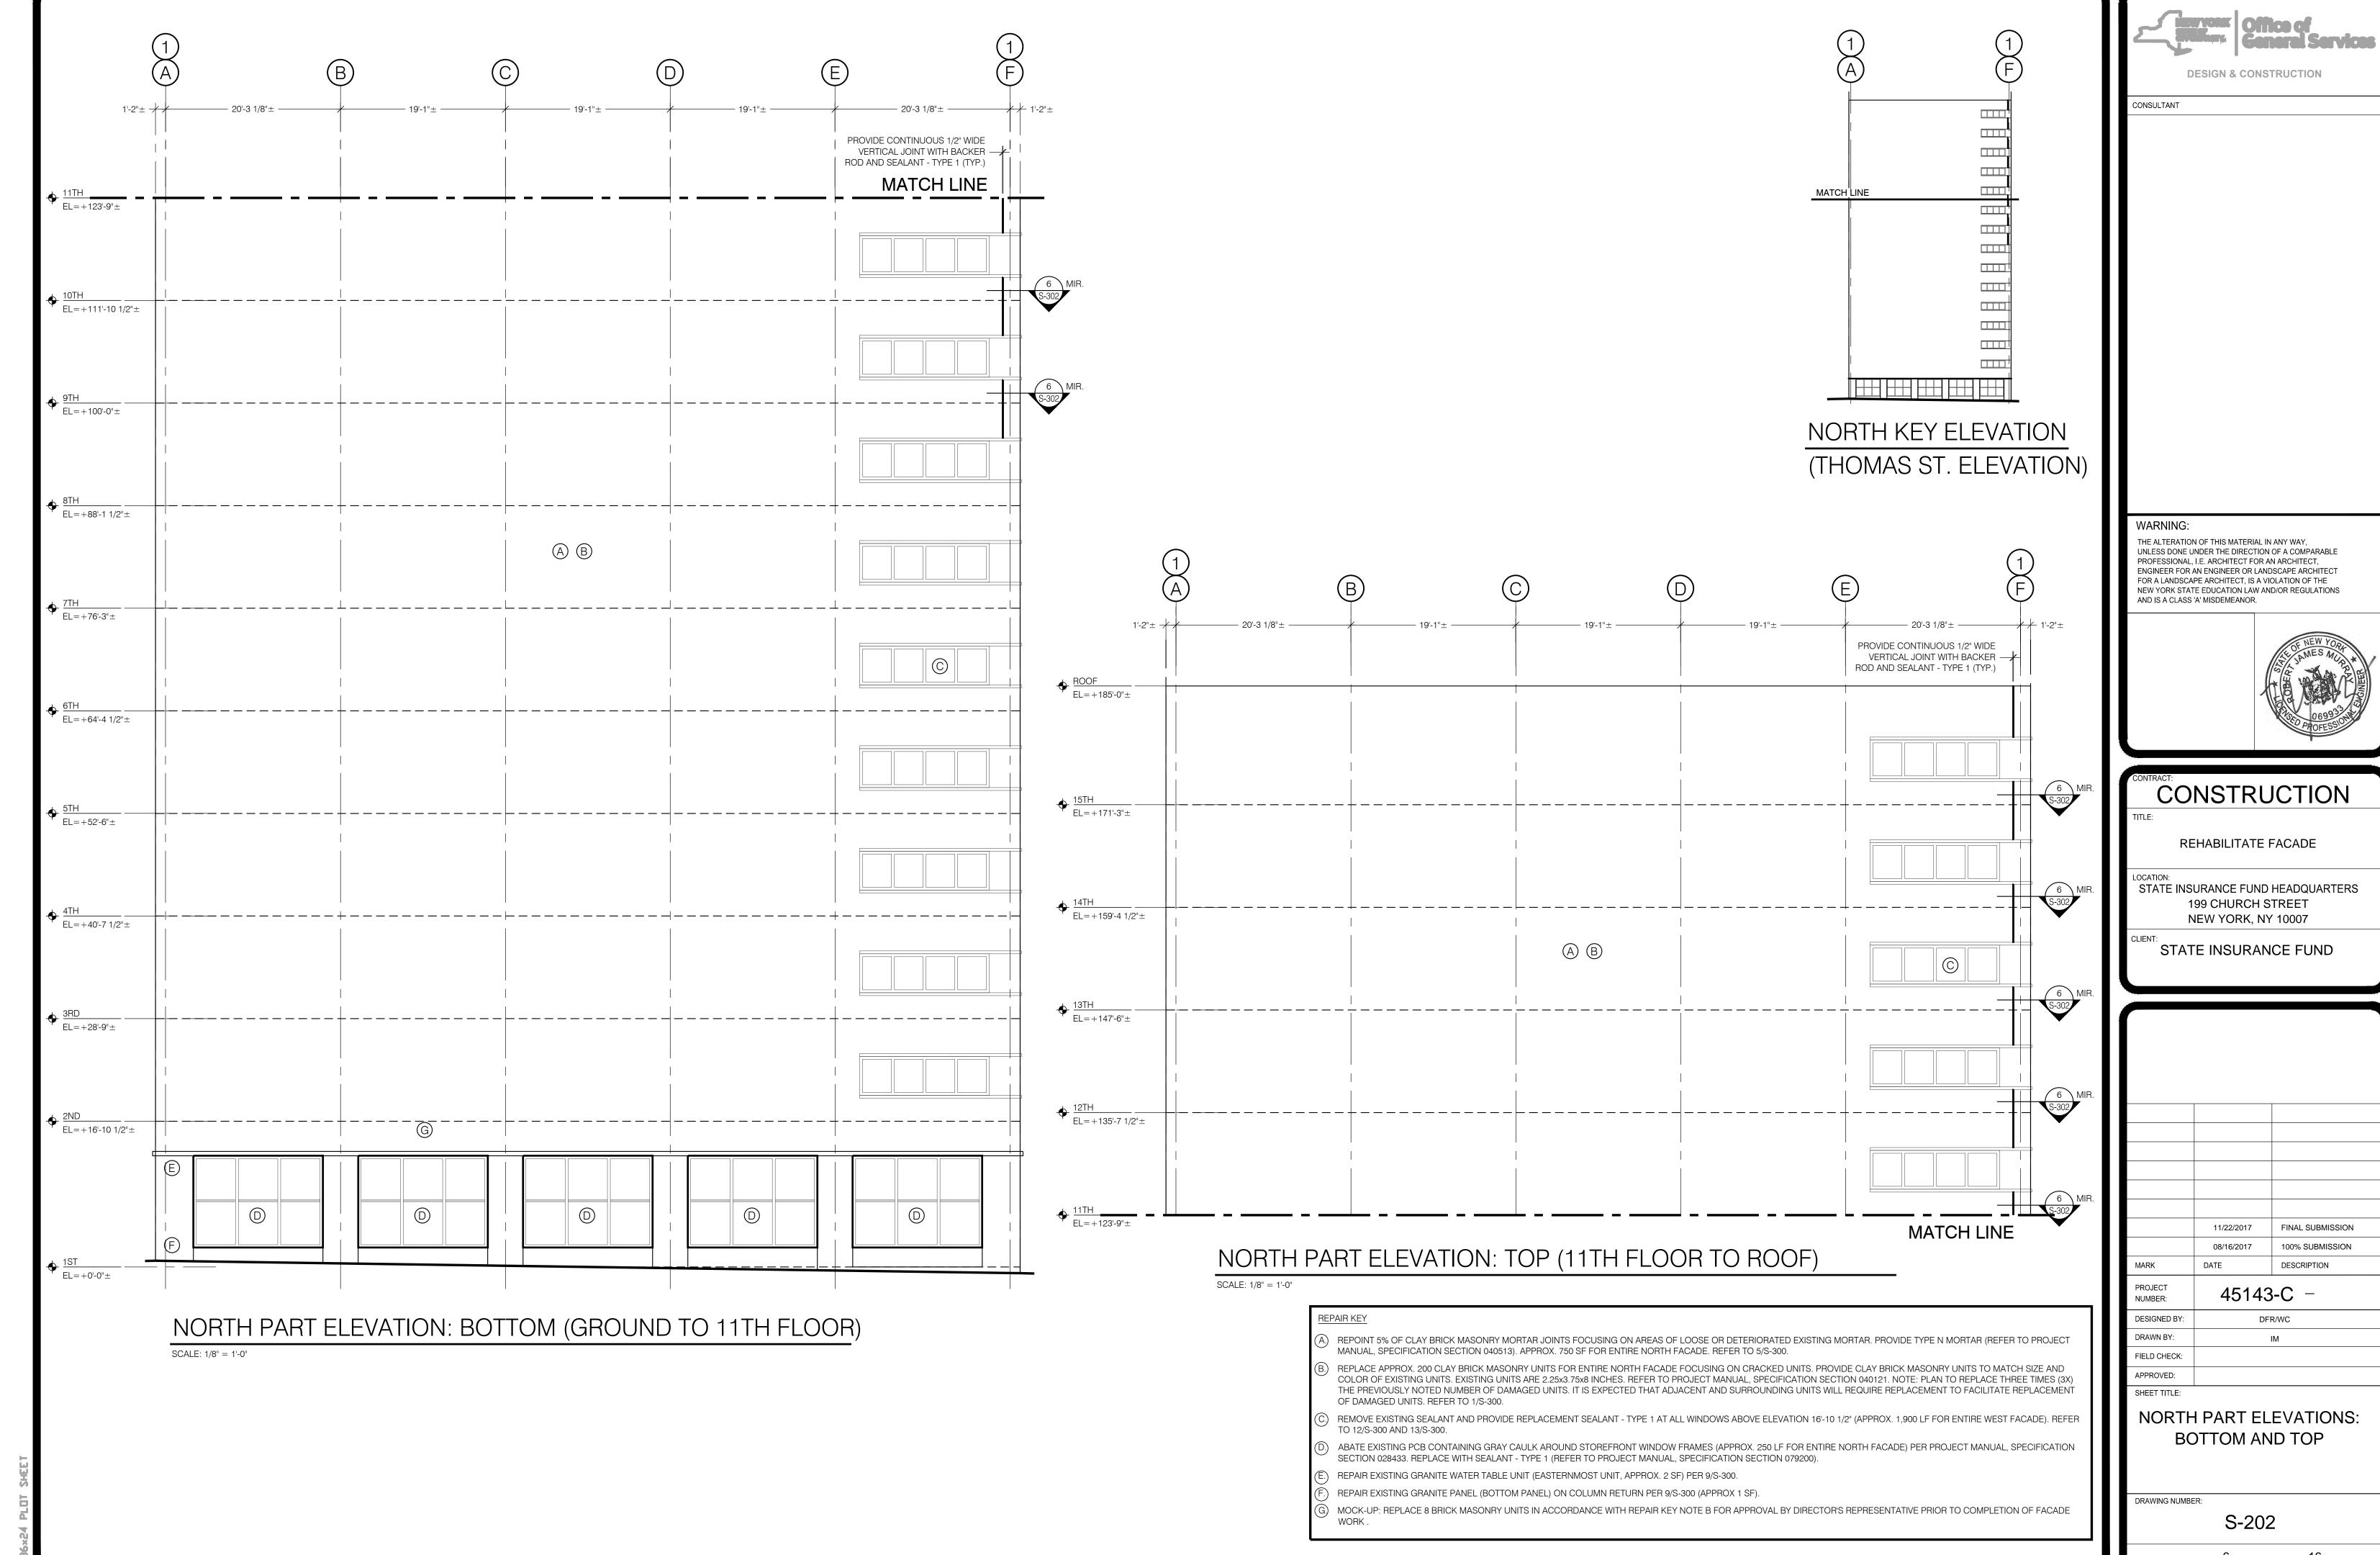
REHABILITATE FACADE


STATE INSURANCE FUND HEADQUARTERS 199 CHURCH STREET


FINAL SUBMISSION 100% SUBMISSION DESCRIPTION 45143-C -


WEST PART ELEVATION:


(11TH FLOOR TO ROOF)



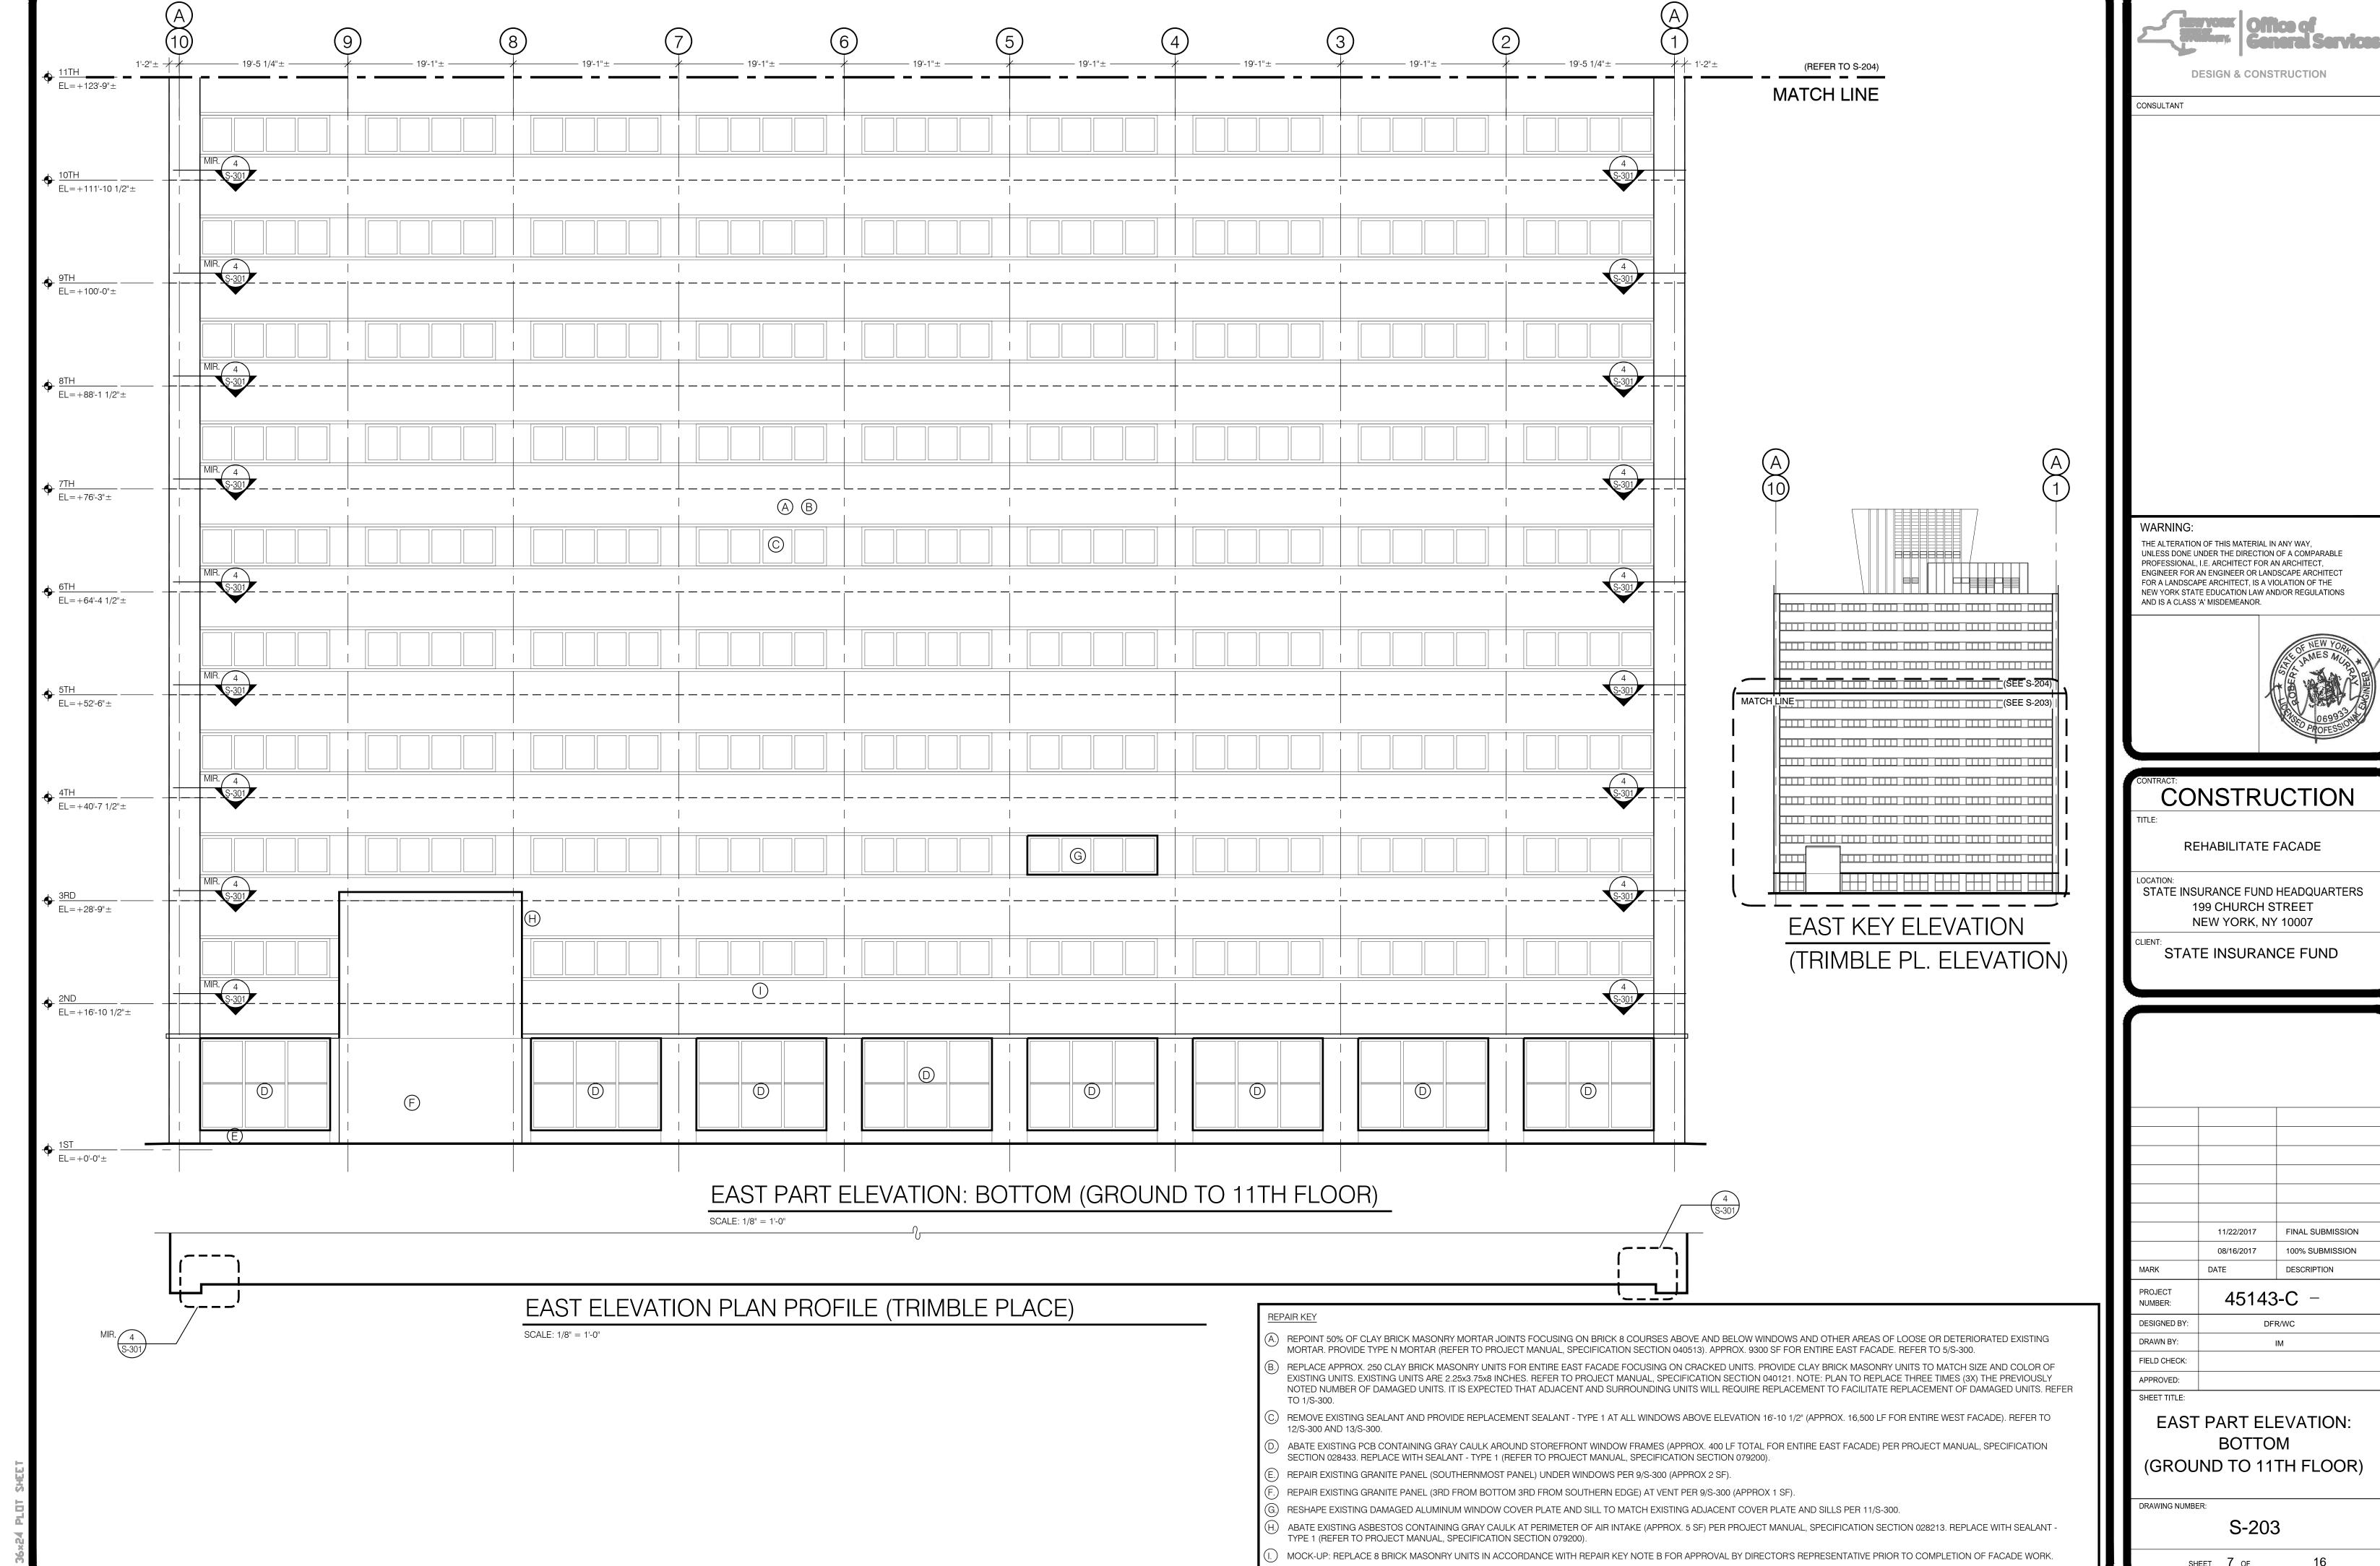

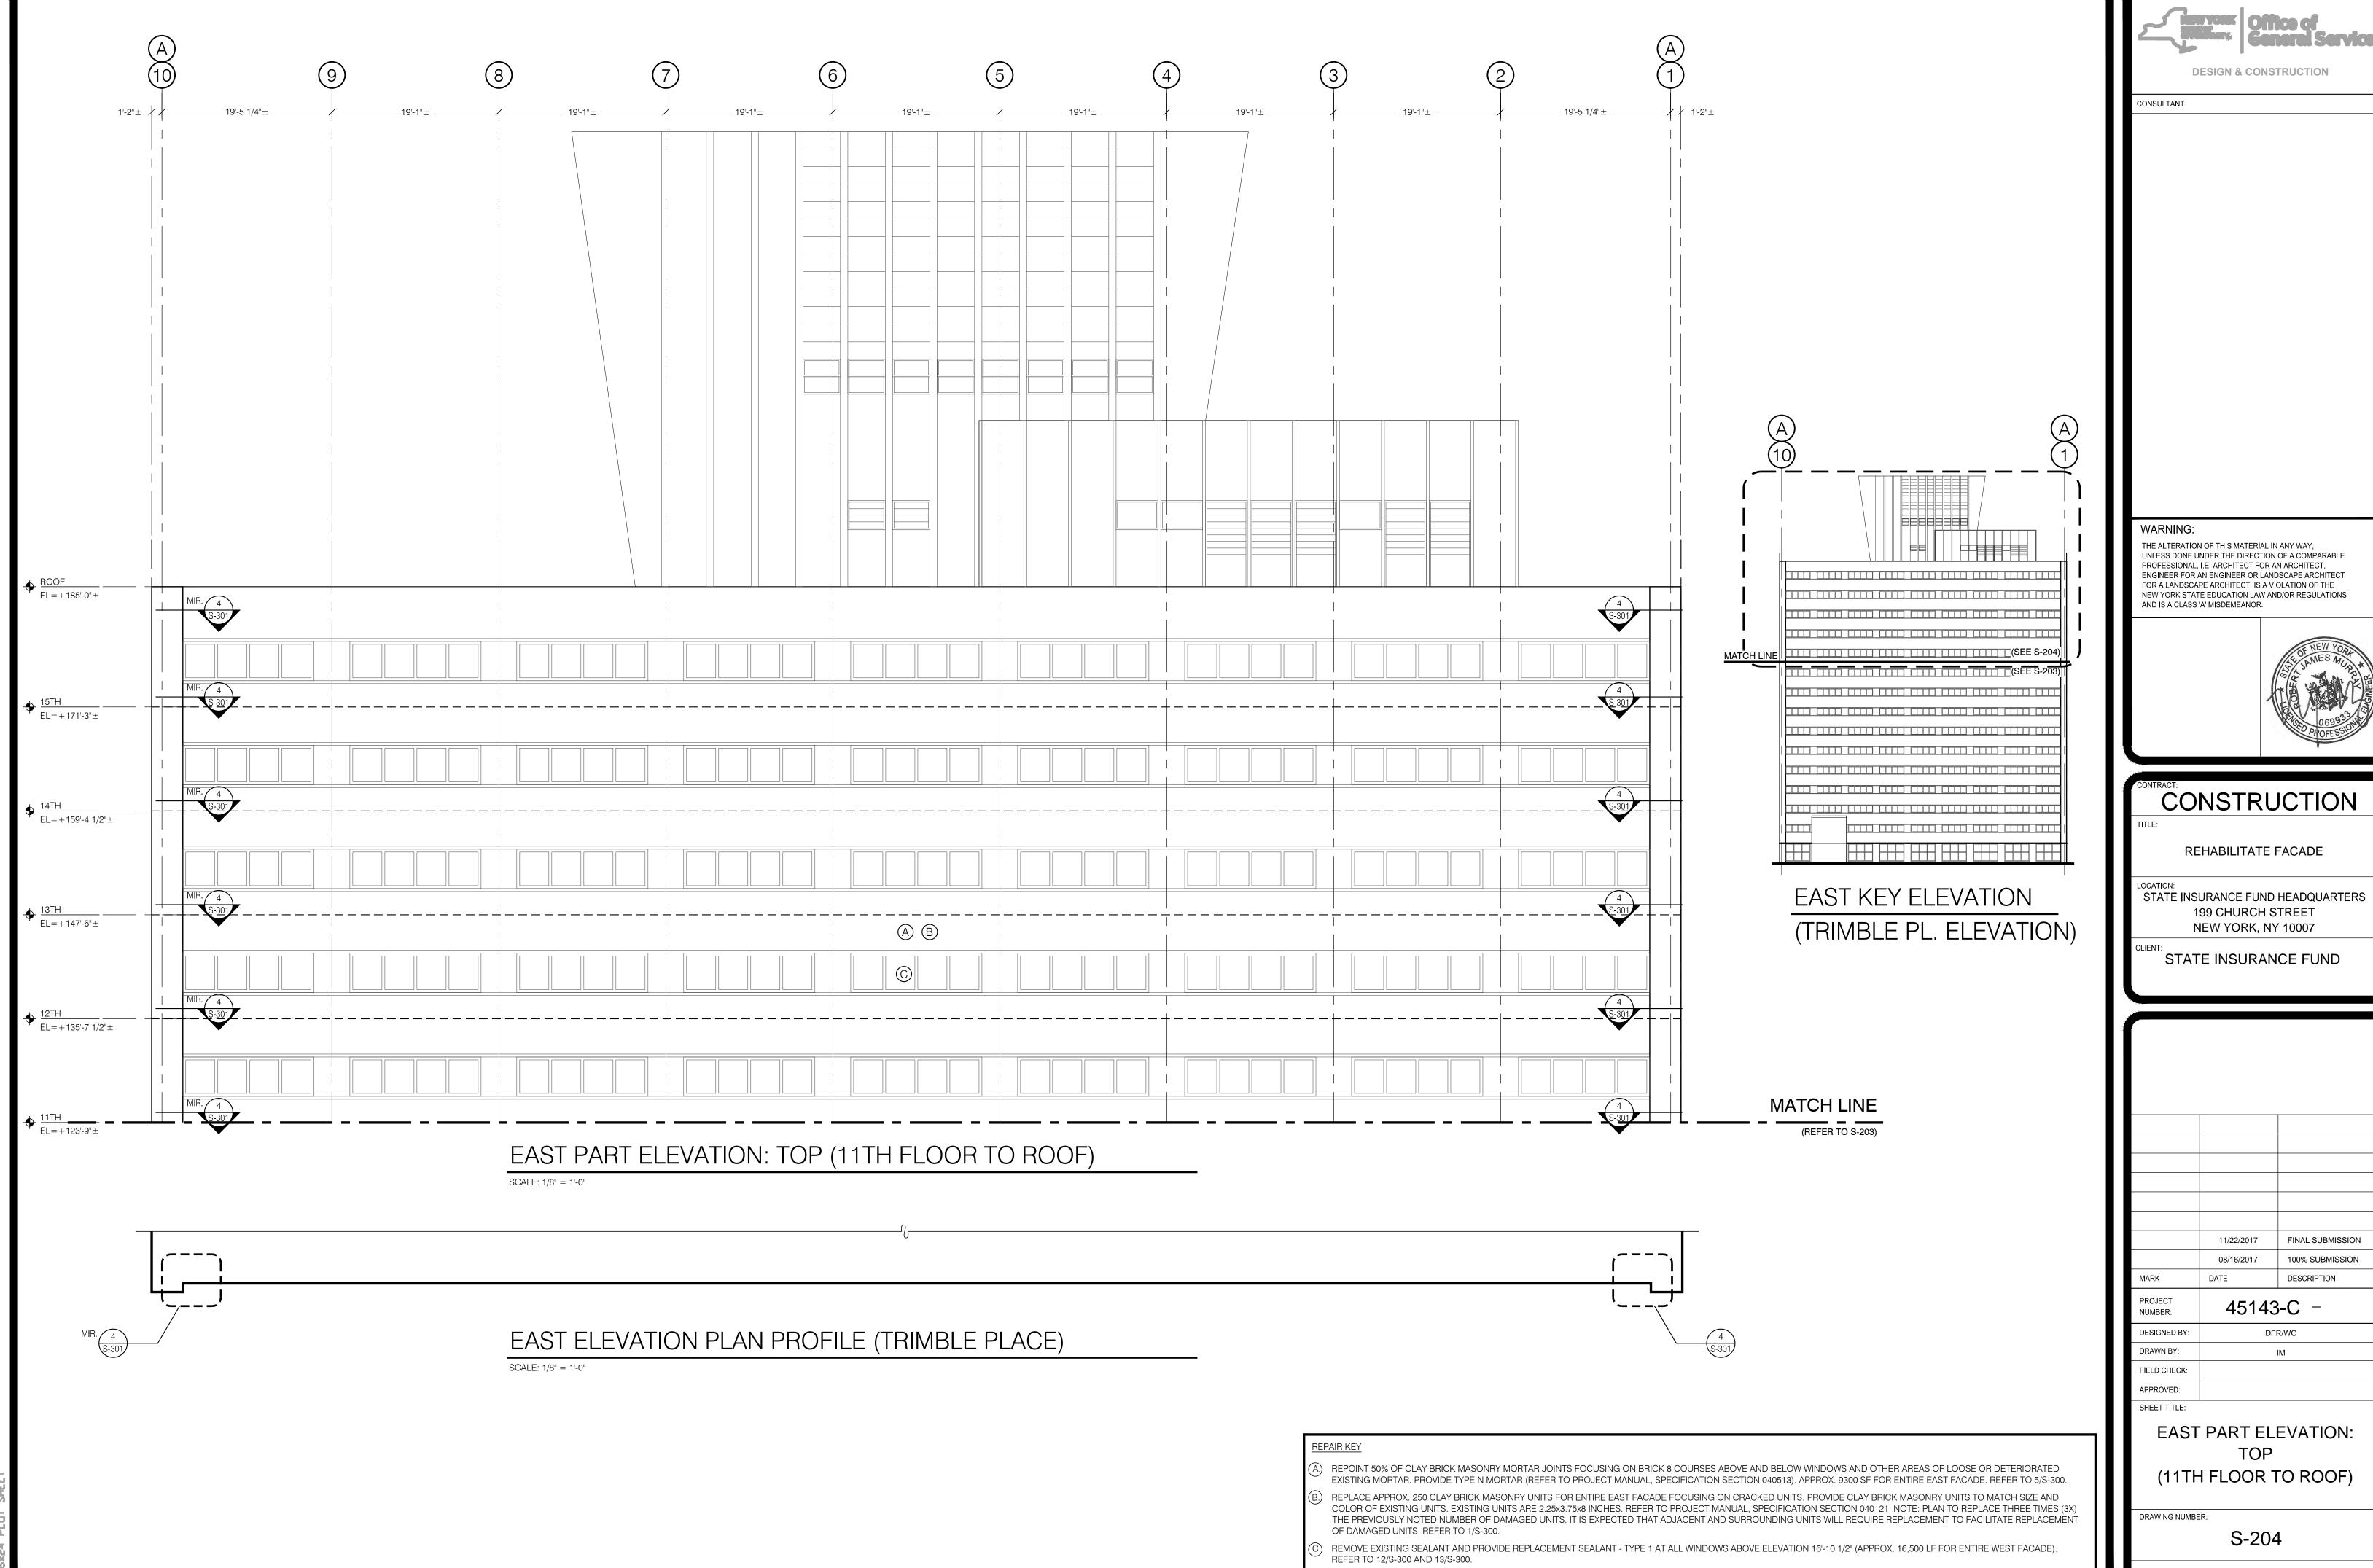

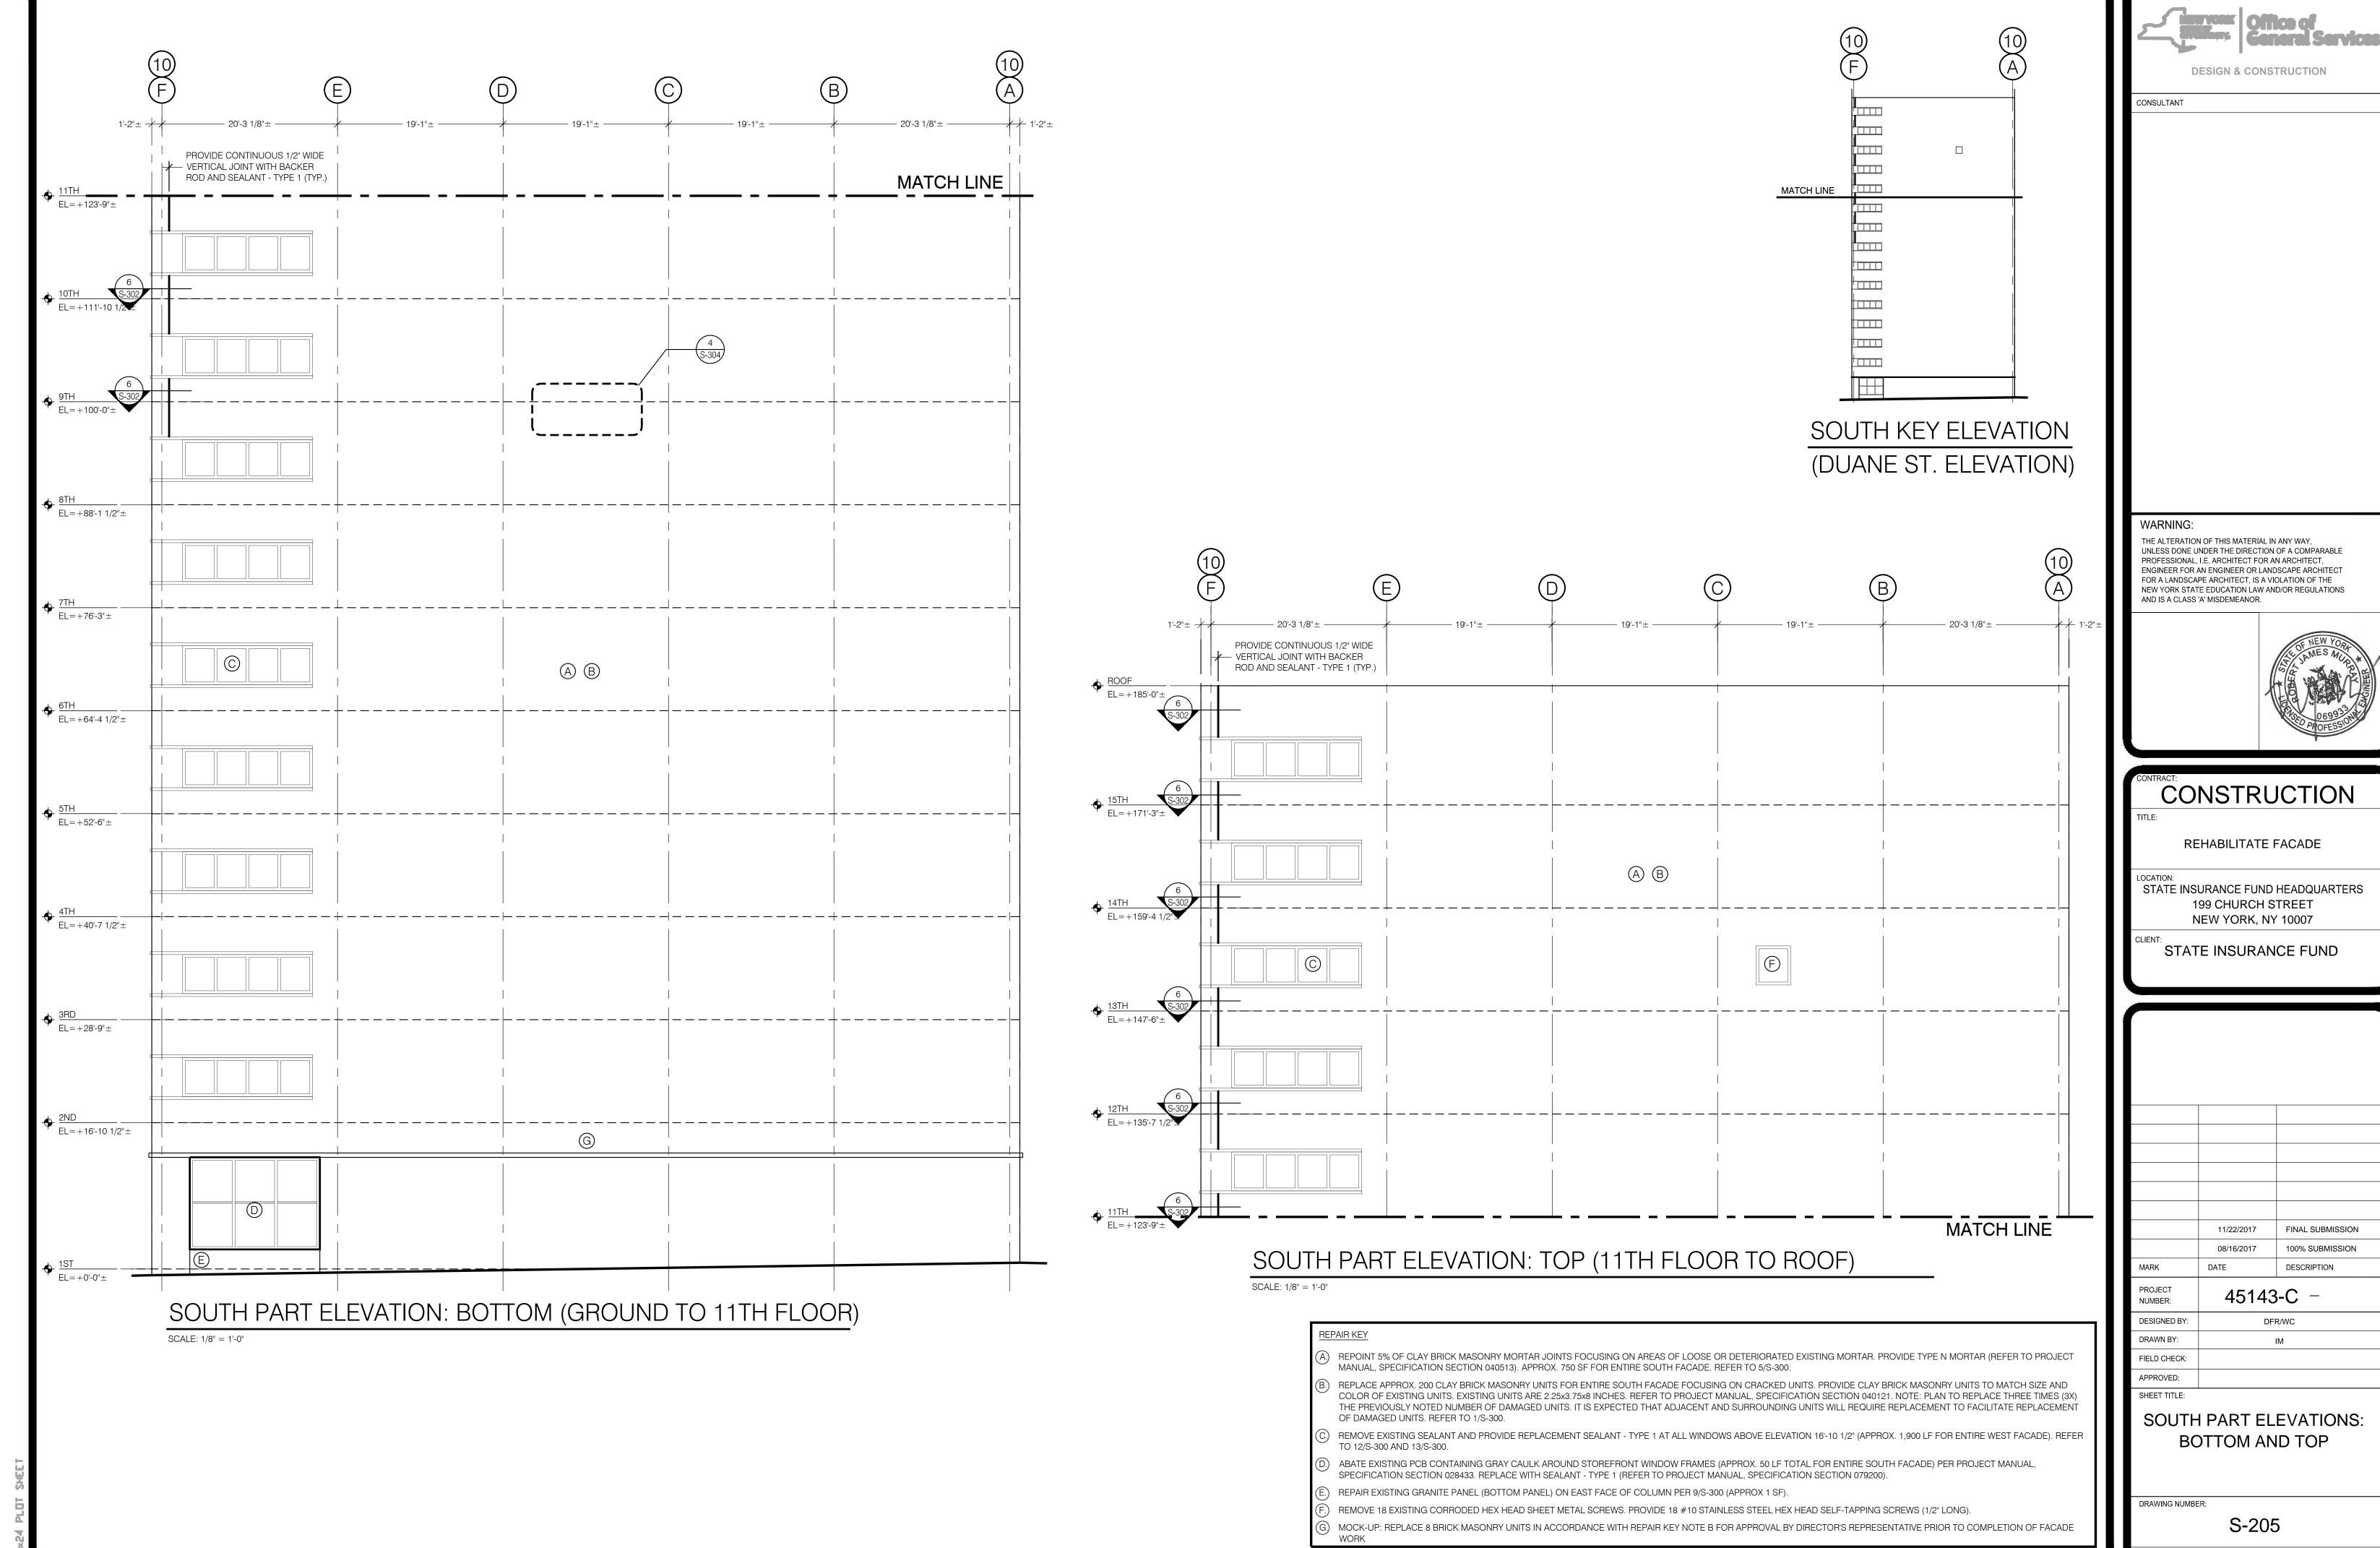

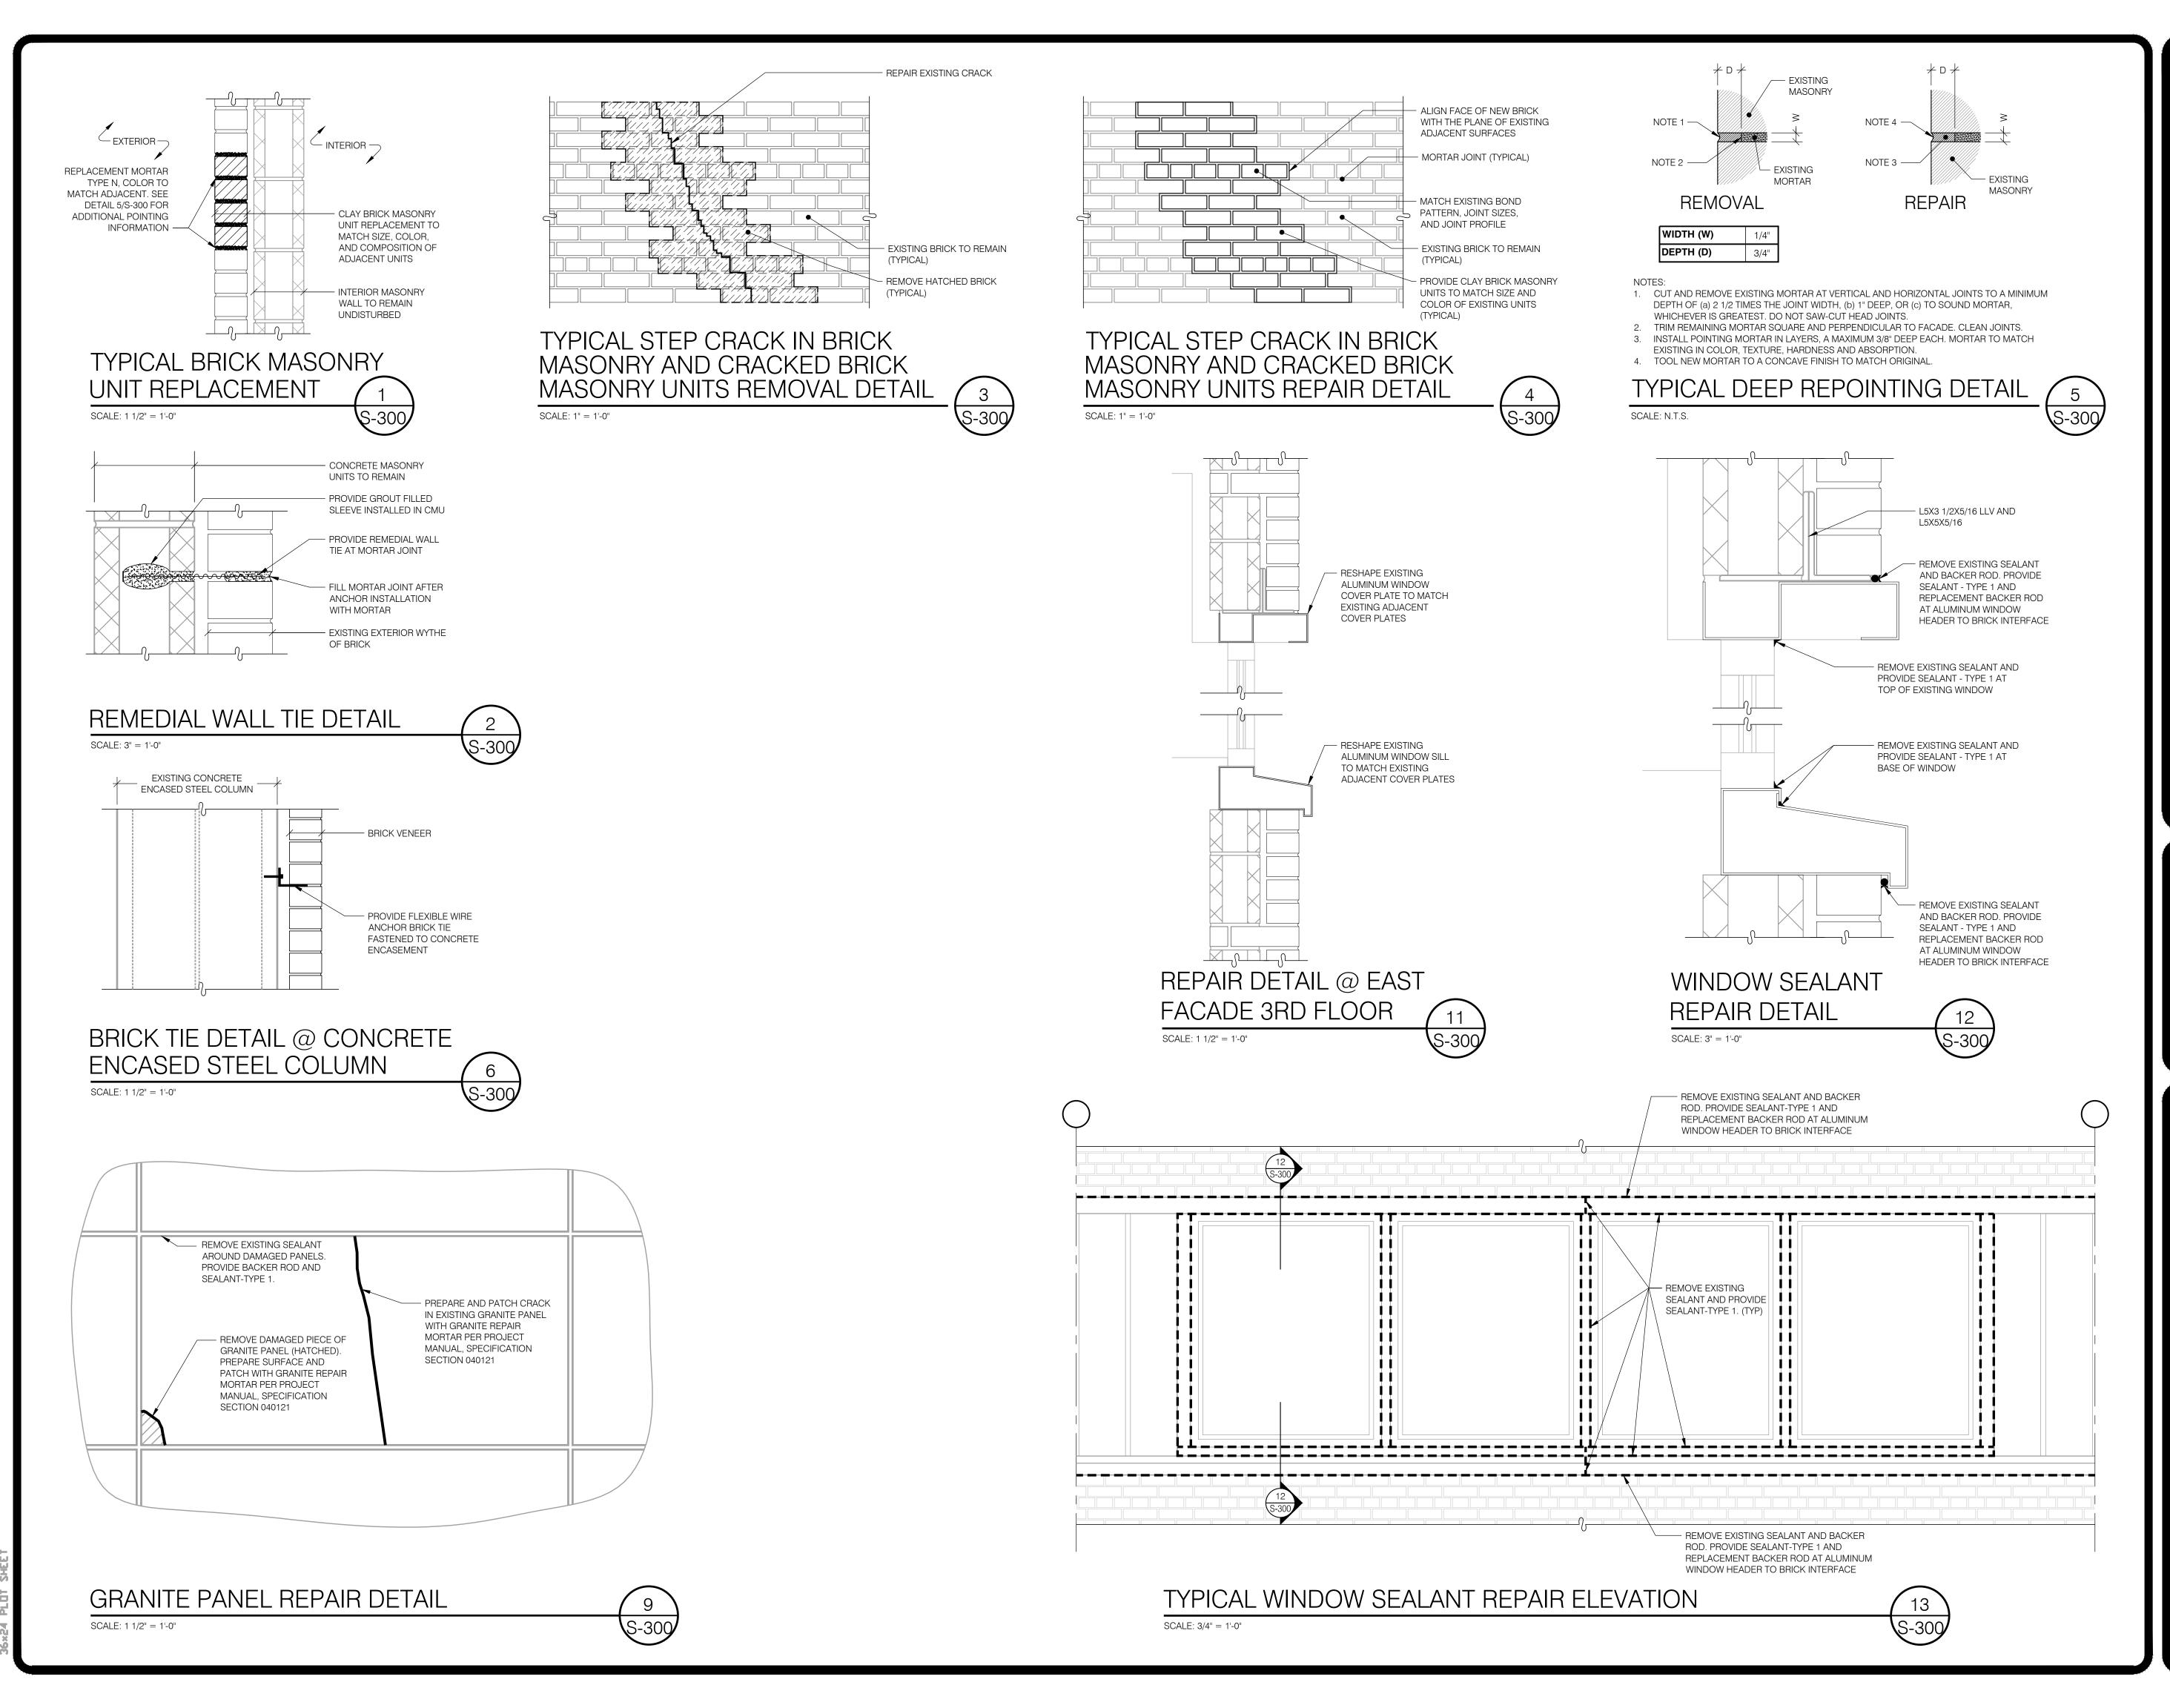

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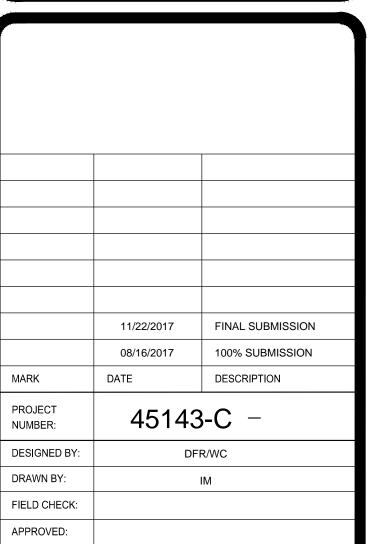


CONSTRUCTION

REHABILITATE FACADE

STATE INSURANCE FUND HEADQUARTERS 199 CHURCH STREET NEW YORK, NY 10007


STATE INSURANCE FUND



REMOVAL AND REPAIR **DETAILS** 

DRAWING NUMBER: S-300

SHEET TITLE:

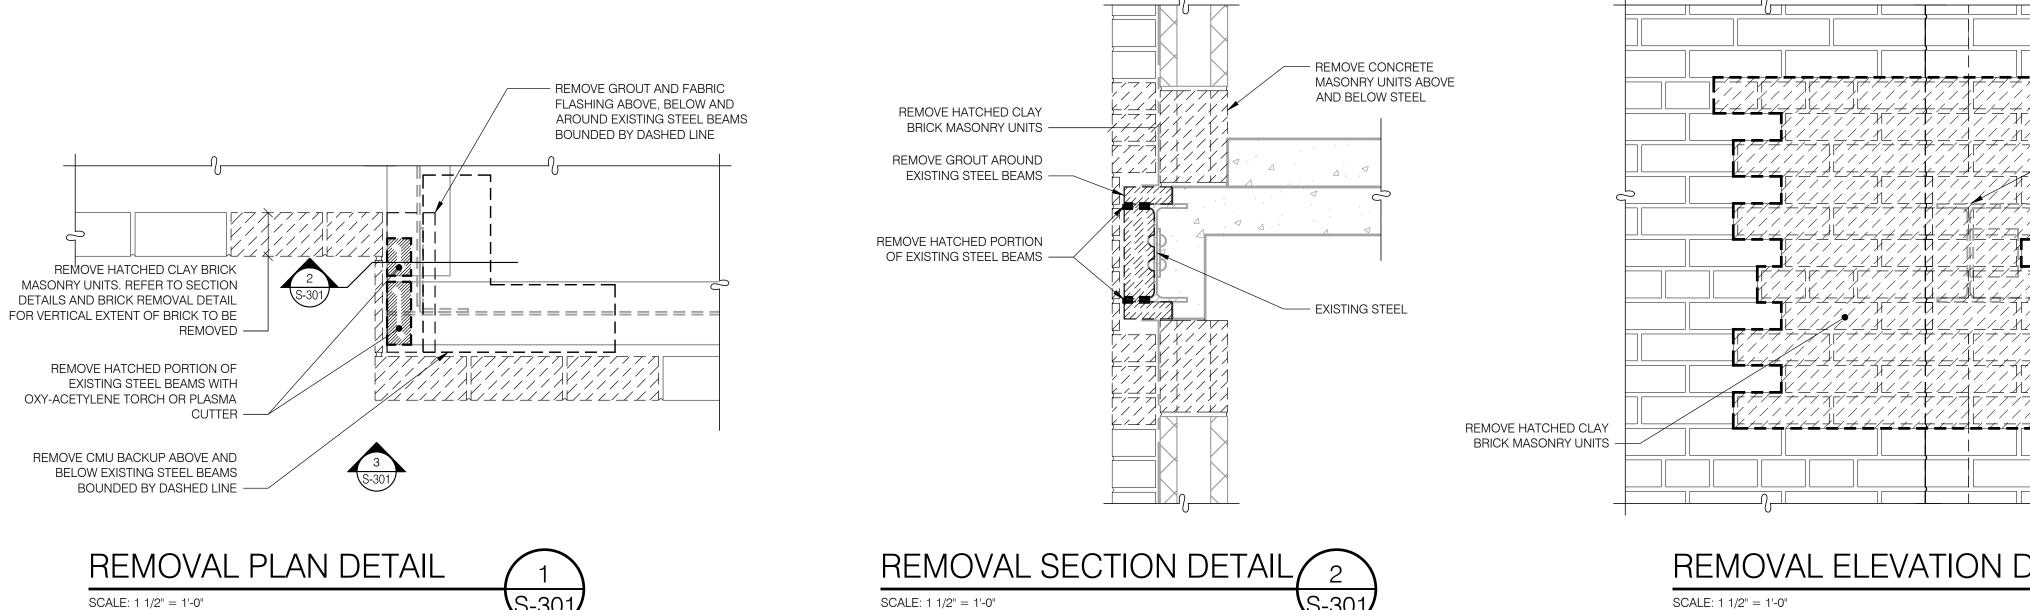

NEW CLAY BRICK MASONRY UNITS ----

. REMOVE CLAY BRICK MASONRY UNITS AS SHOWN TO ALLOW FOR ACCESS TO AND PARTIAL REMOVAL OF STEEL BEAMS.

4. REMOVE INDICATED PORTIONS OF EXISTING STEEL BEAMS WITH OXY-ACETYLENE TORCH OR PLASMA CUTTER.

5. PROVIDE GROUT SLOPED TO MATCH ADJACENT ON TOP OF ALTERED STEEL BEAMS.

REMOVE ONE CONCRETE MASONRY UNIT IN EACH DIRECTION (NORTH-SOUTH AND EAST-WEST) AT CORNER ABOVE AND BELOW STEEL BEAMS. 3. REMOVE SPANDREL FABRIC FLASHING AND SLOPED GROUT AROUND EXISTING STEEL BEAMS 2" BEYOND EXTENT OF EXISTING STEEL BEAMS

5. PROVIDE COLD FLUID APPLIED WATERPROOFING SYSTEM OVER GROUT AND AROUND EXPOSED STEEL. PROVIDE 4" LAP OVER EXISTING


B. PROVIDE REPLACEMENT CLAY BRICK MASONRY UNITS. PROVIDE PARTIAL WIDTH UNITS AT STEEL CONFLICT LOCATIONS ON EAST AND WEST

**REPAIR SEQUENCE:** 

TO BE REMOVED.


SPANDREL FABRIC FLASHING.

7. PROVIDE REPLACEMENT CONCRETE MASONRY UNITS.

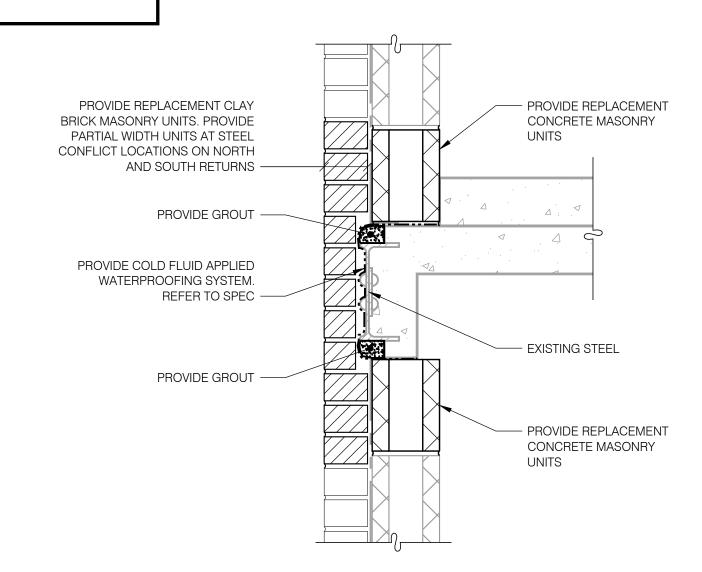





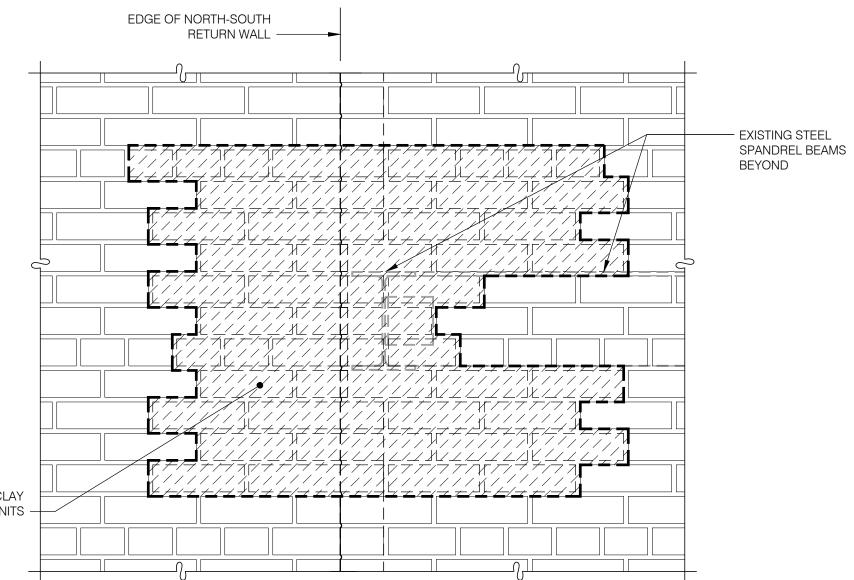


REMOVAL ELEVATION DETAIL

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CONSTRUCTION

REHABILITATE FACADE

STATE INSURANCE FUND HEADQUARTERS 199 CHURCH STREET NEW YORK, NY 10007

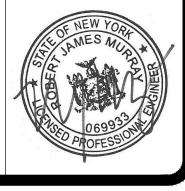STATE INSURANCE FUND

	Γ			
	11/22/2017	FINAL SUBMISSION		
	08/16/2017	100% SUBMISSION		
MARK	DATE	DESCRIPTION		
PROJECT	45143			
NUMBER:	43140	) <del>-</del> C		
DESIGNED BY:	DFR/WC			
DRAWN BY:		IM		
FIELD CHECK:				
APPROVED:				


REMOVAL AND REPAIR DETAILS AT NORTHEAST AND SOUTHEAST CORNERS


DRAWING NUMBER:

SHEET TITLE:


S-301


SHEET 11 OF

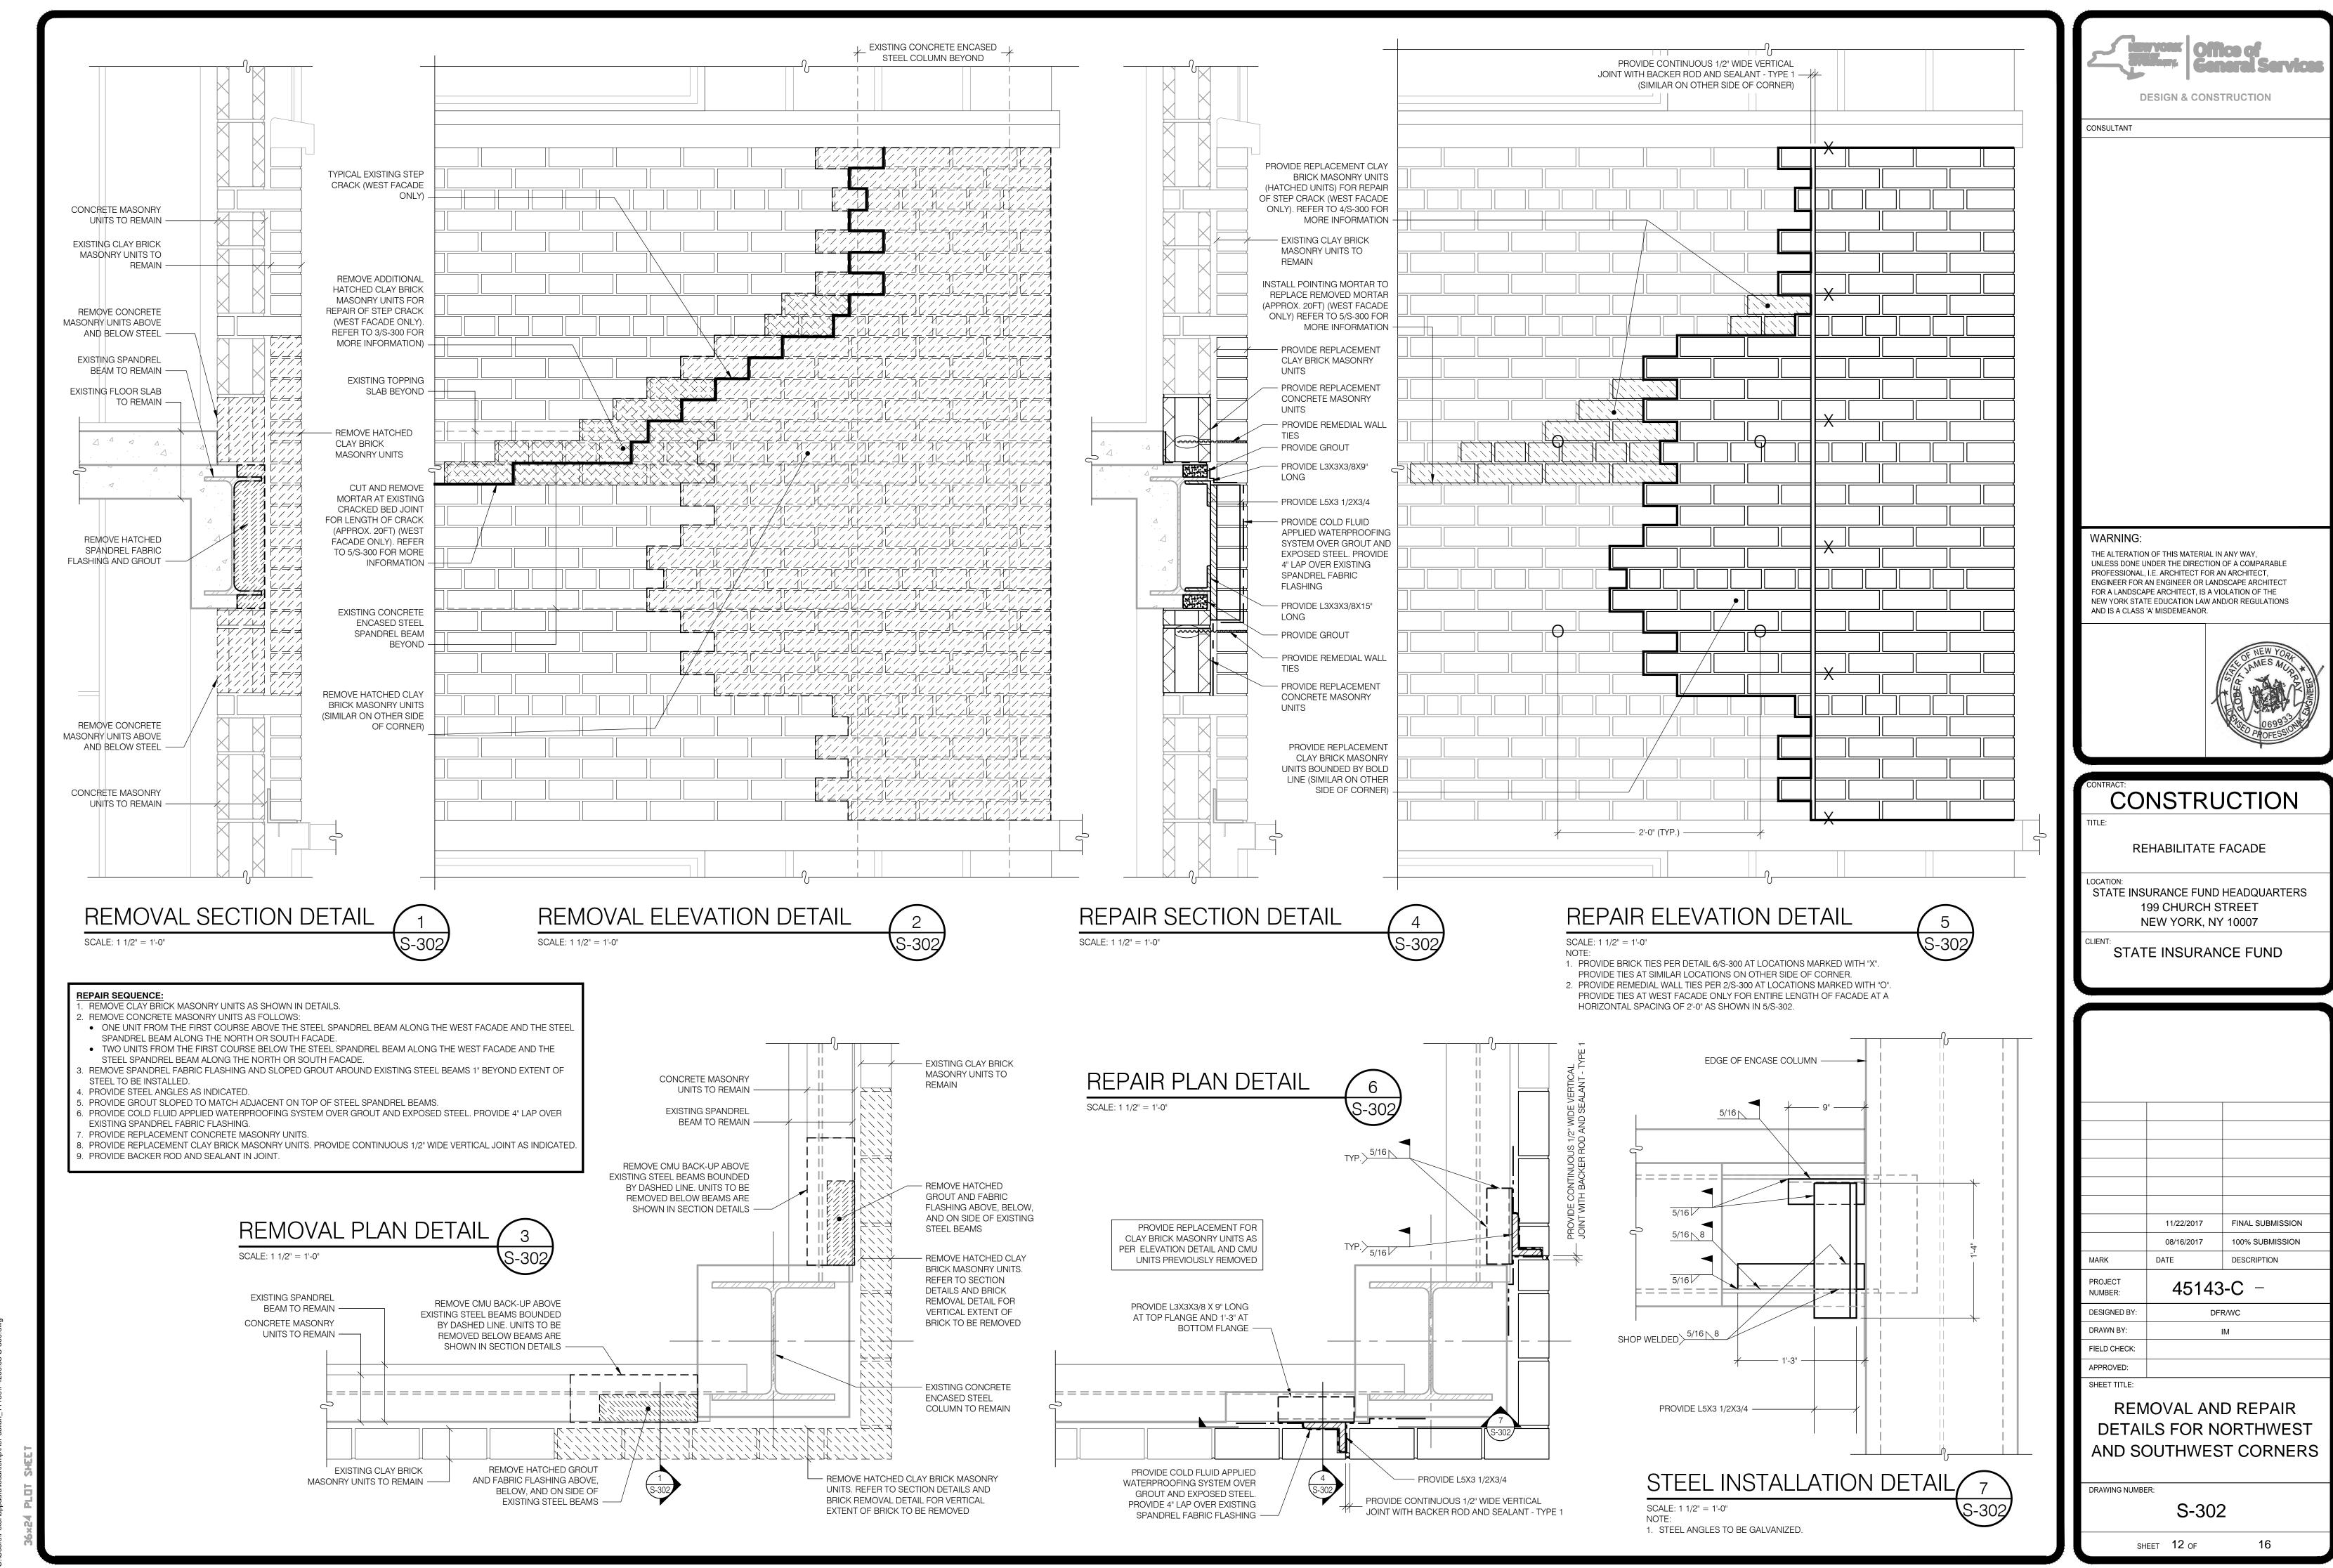


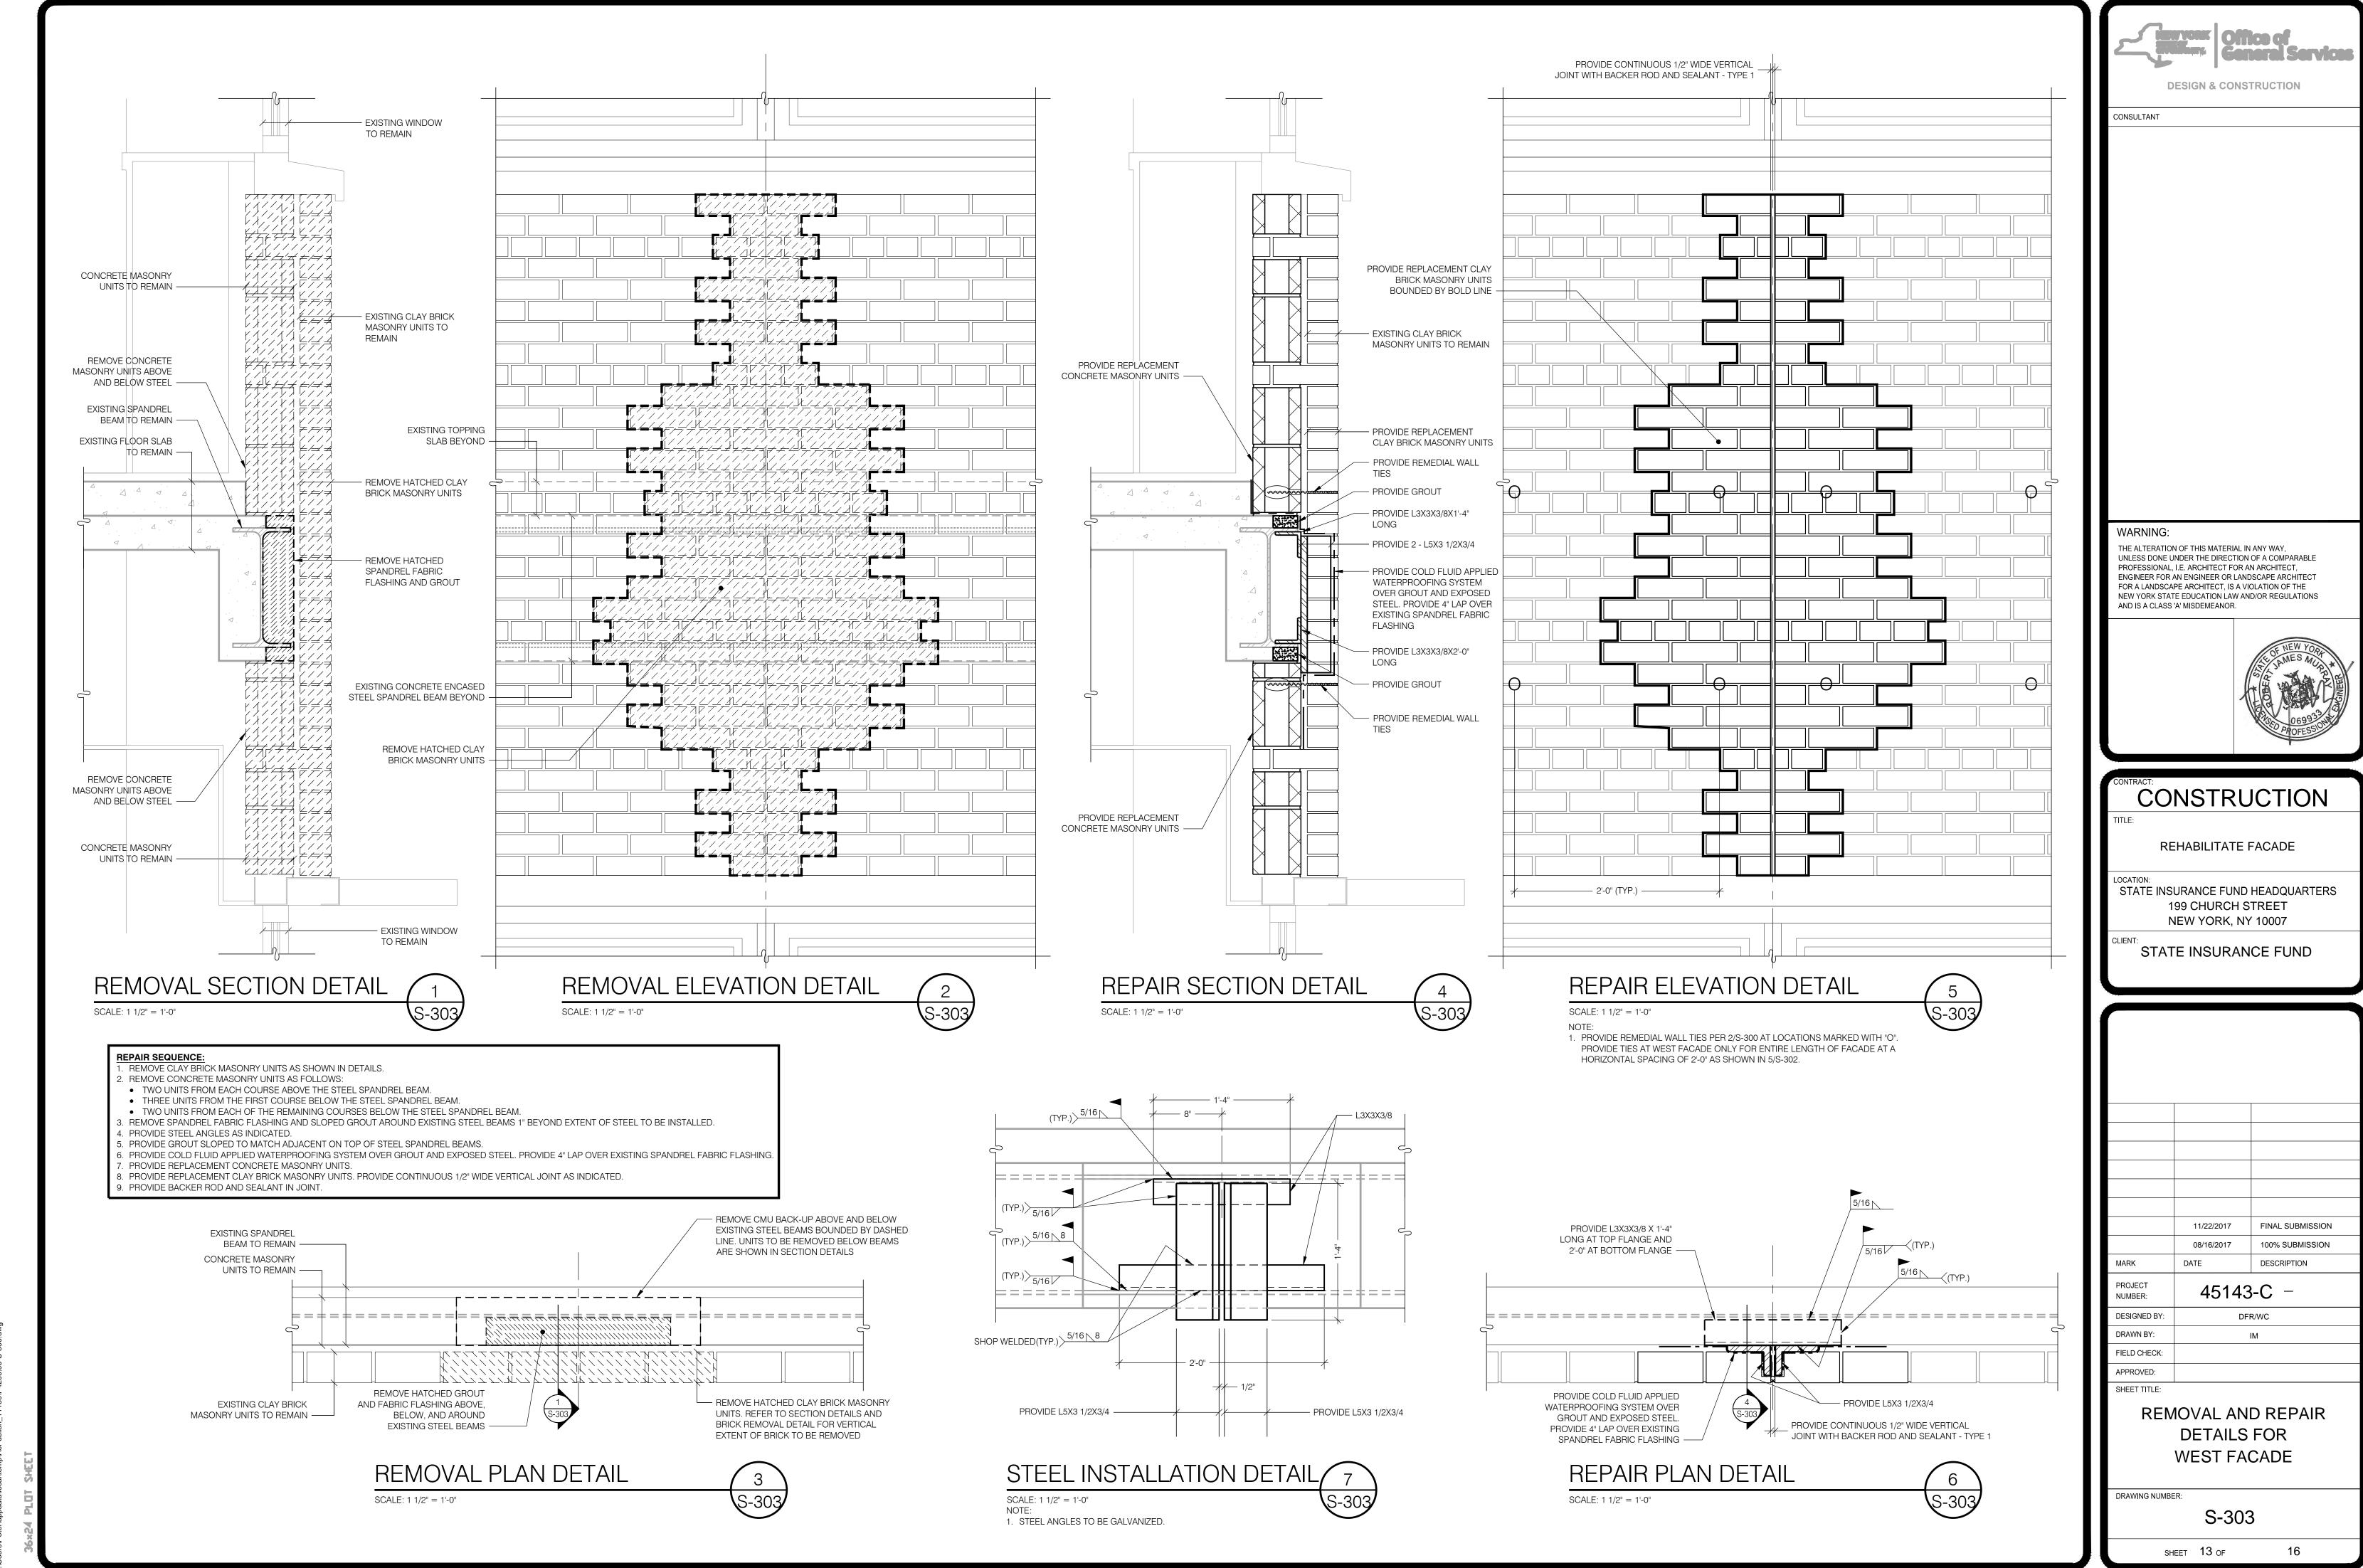

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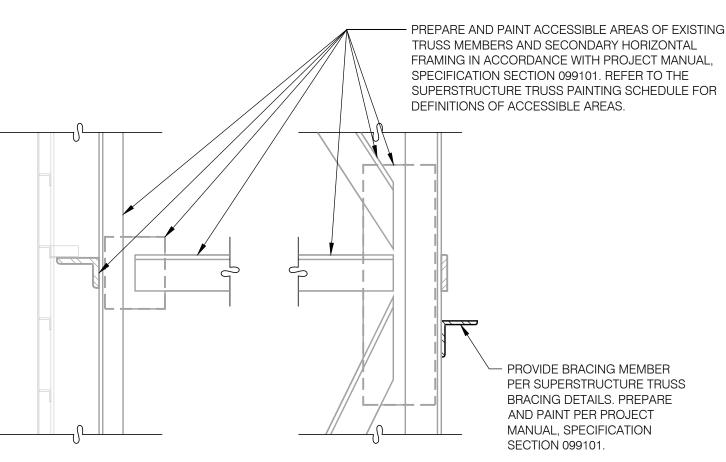


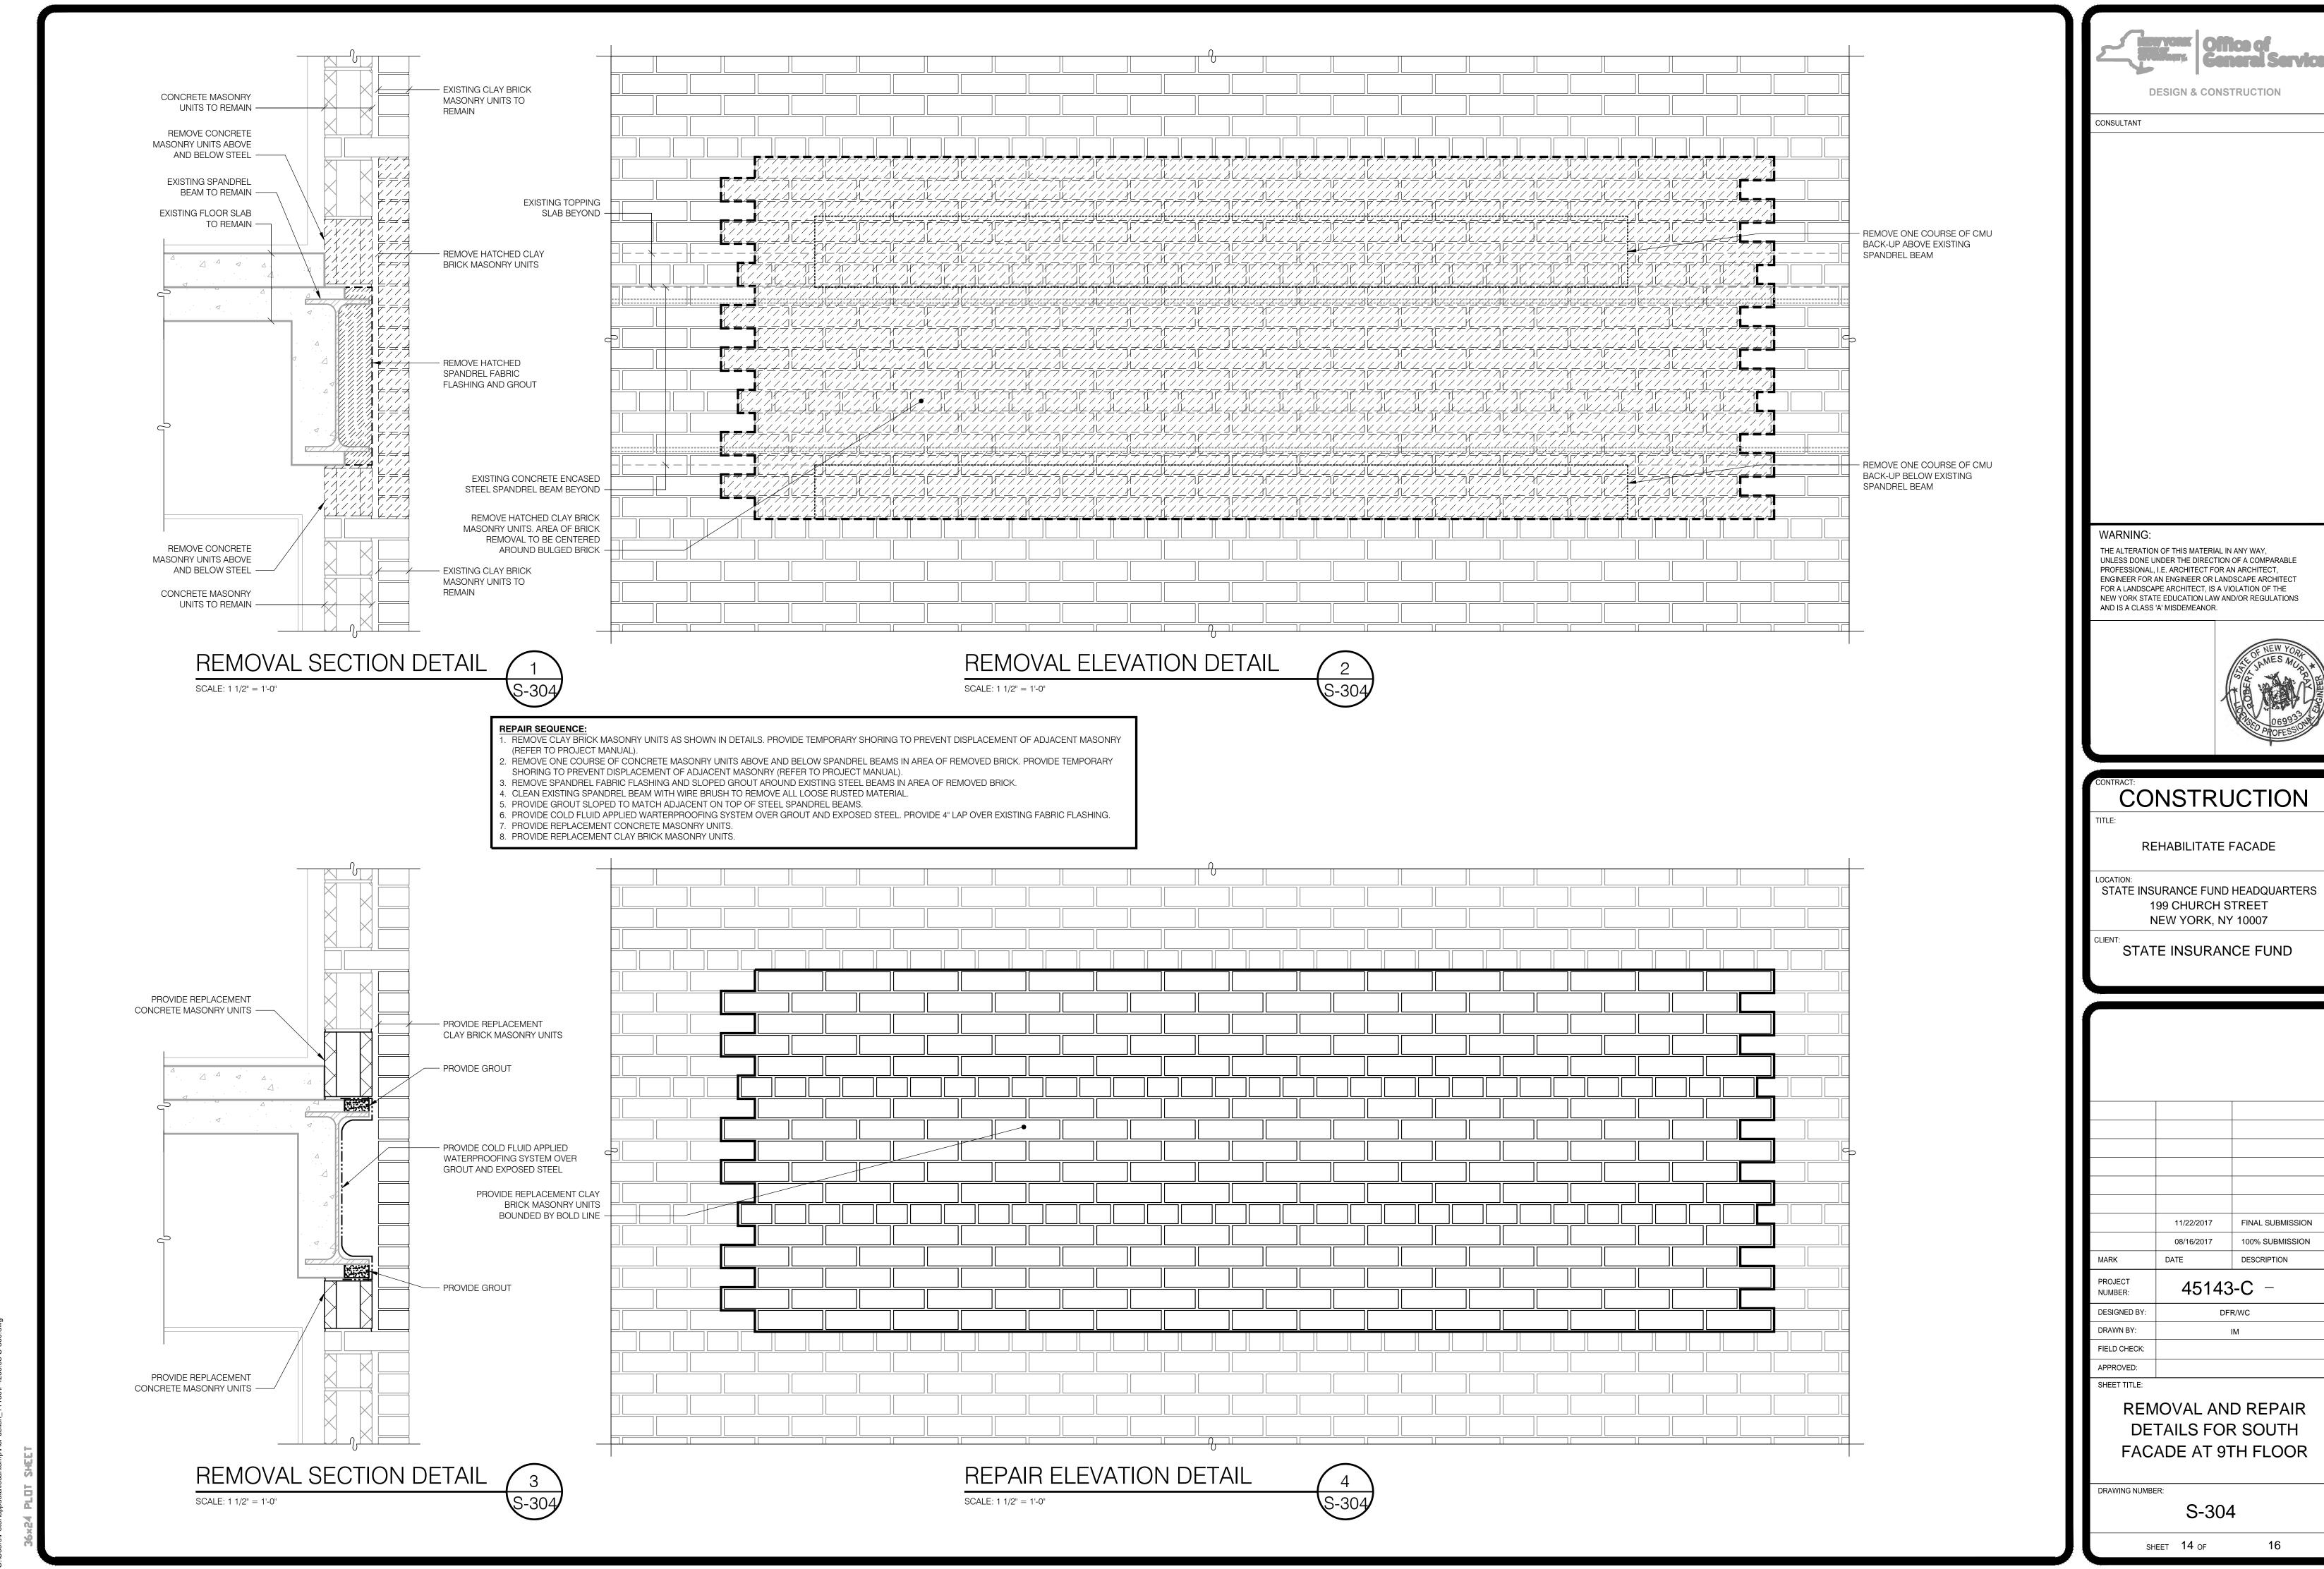

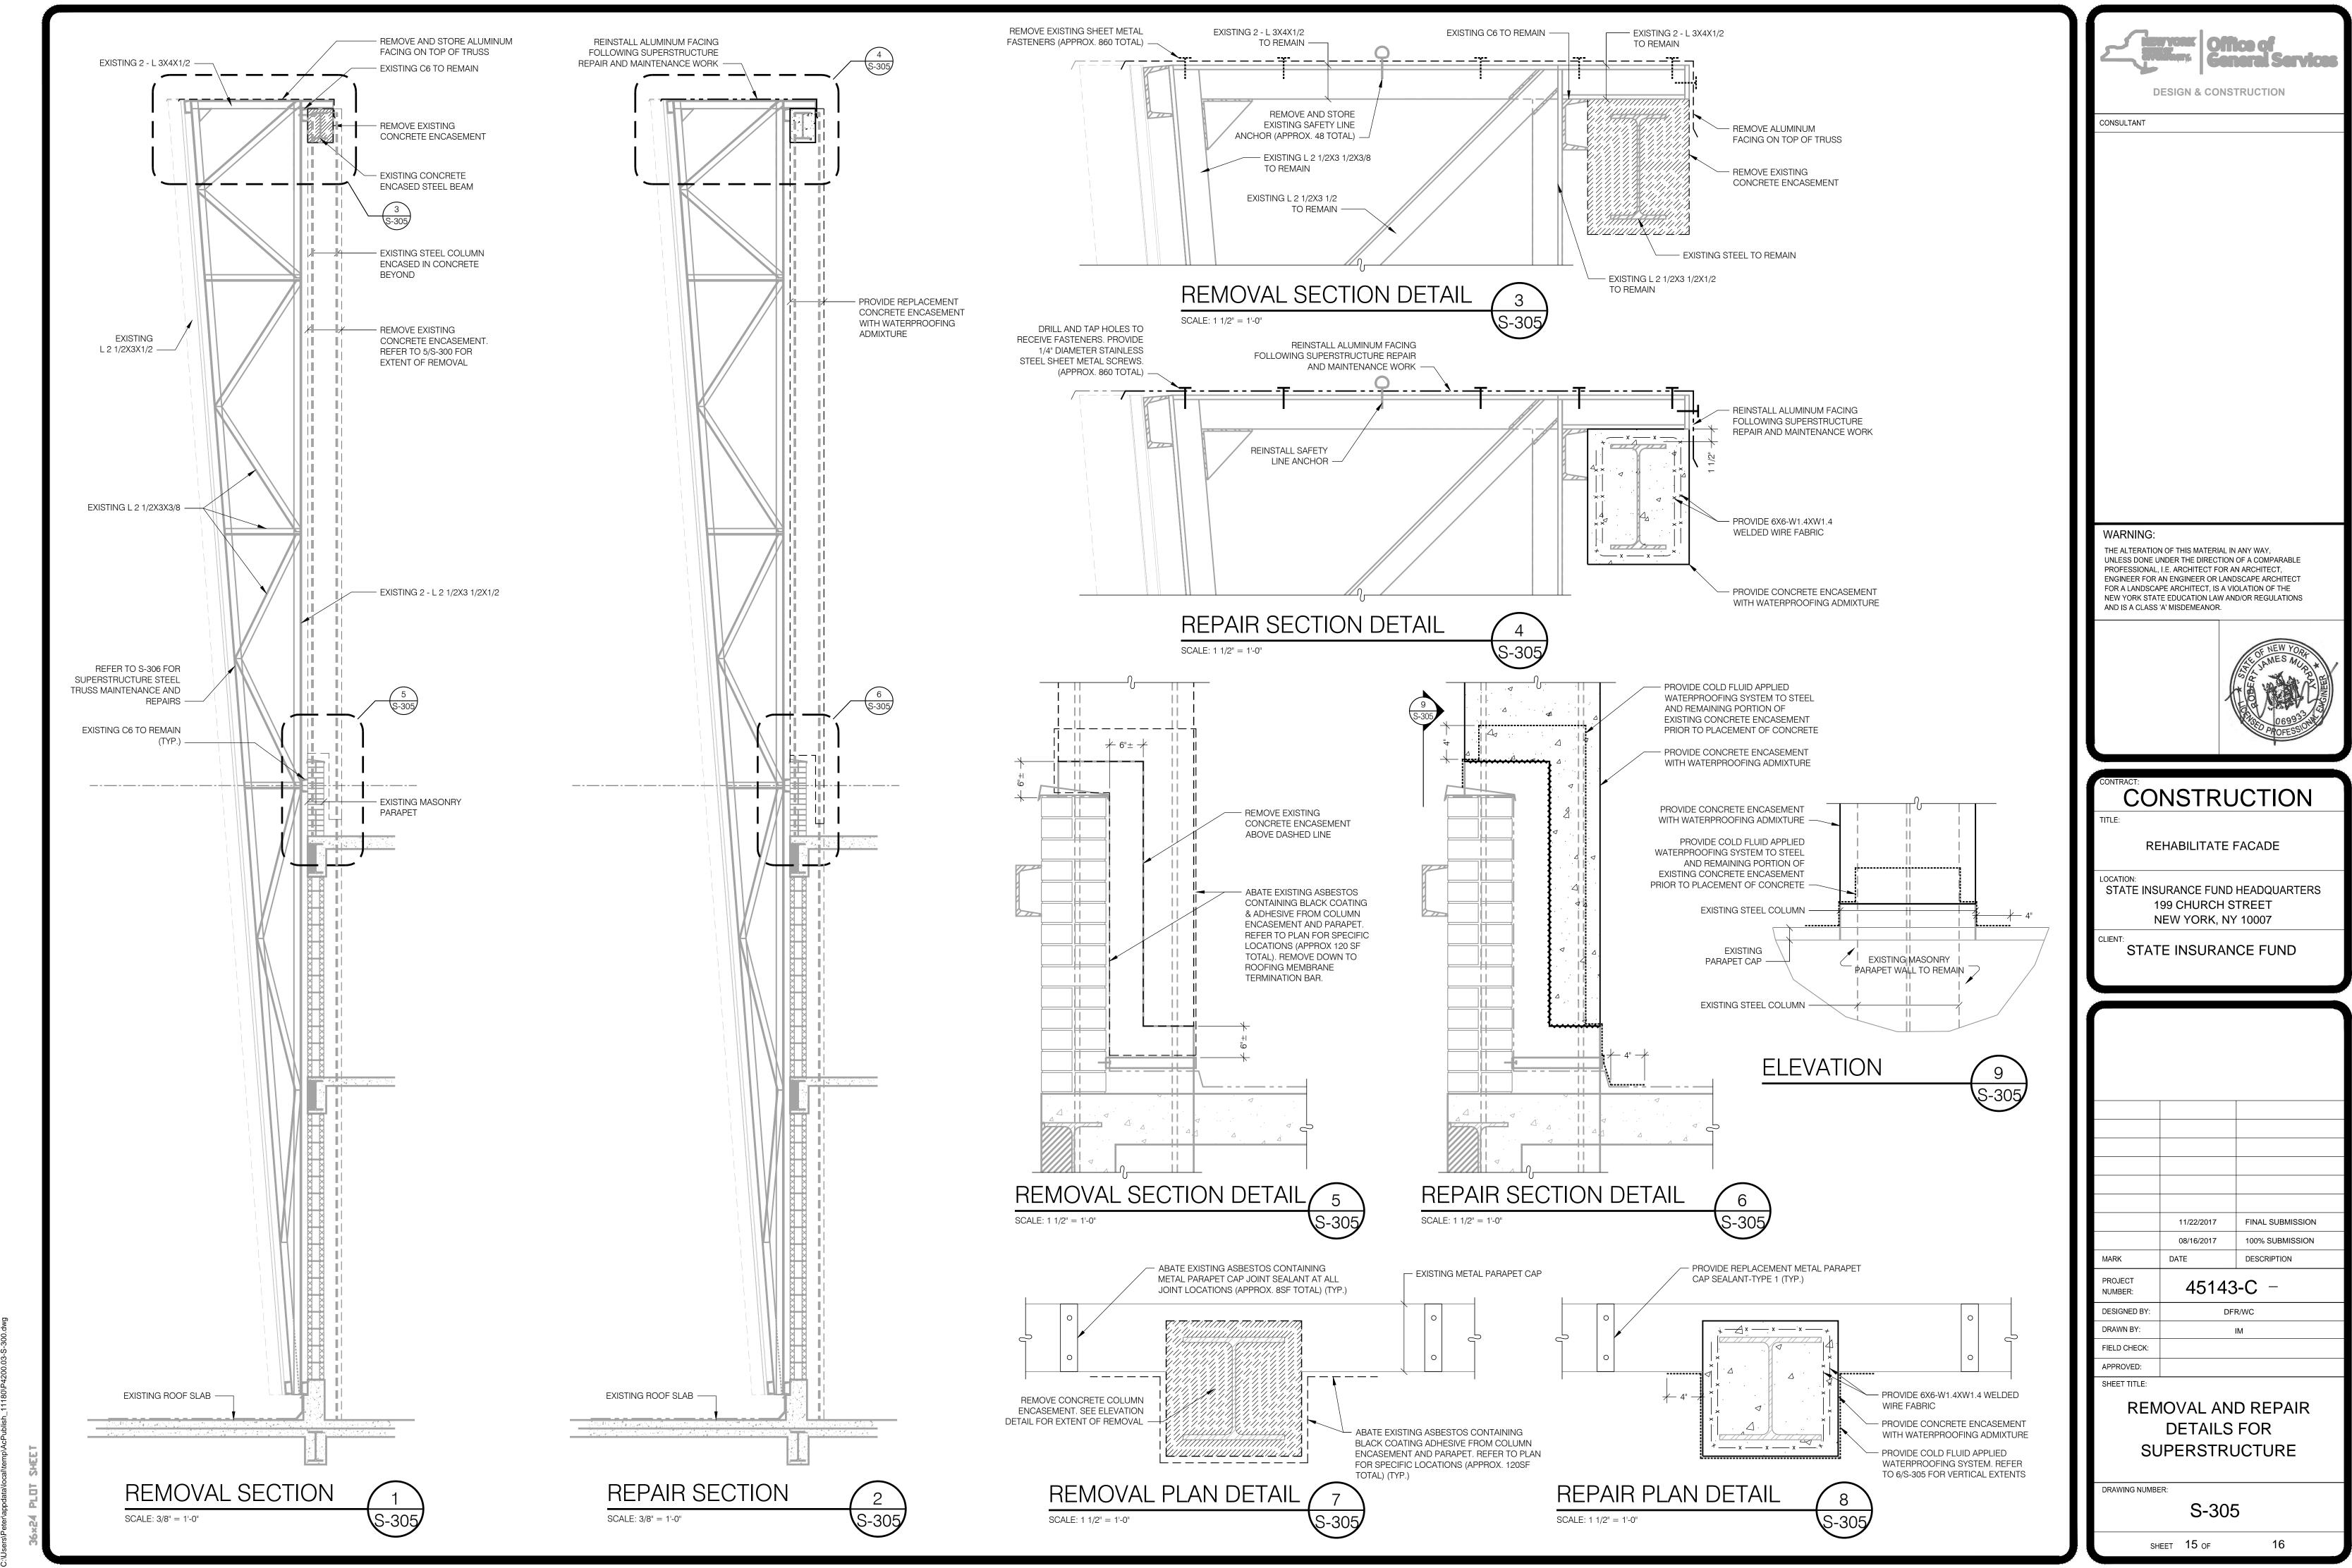TRUSS	TRUSS	TRUSS LOCATION (REFER TO SUPERSTRUCTURE TRUSS MAINTENANCE AND REPAIR KEY)											
NUMBER TYPE	2	5	6i	8i	10i	S3	S4	S5	S6	S7	S8	S9	
T8	В											Х	
T17	В							х				х	
T18	В							х					
T20	В							х					
T21	В							Х					
T27	В							х					
T28	В			х			Х	х					
T32	В											х	
T41	Α						Х	х					
T42	Α	х		х			Х	Х					
T44	Α		х	х			х						
T45	А						Х	х					
T47	Α				х	Х	Х	Х	Х	Х	х	Х	Х
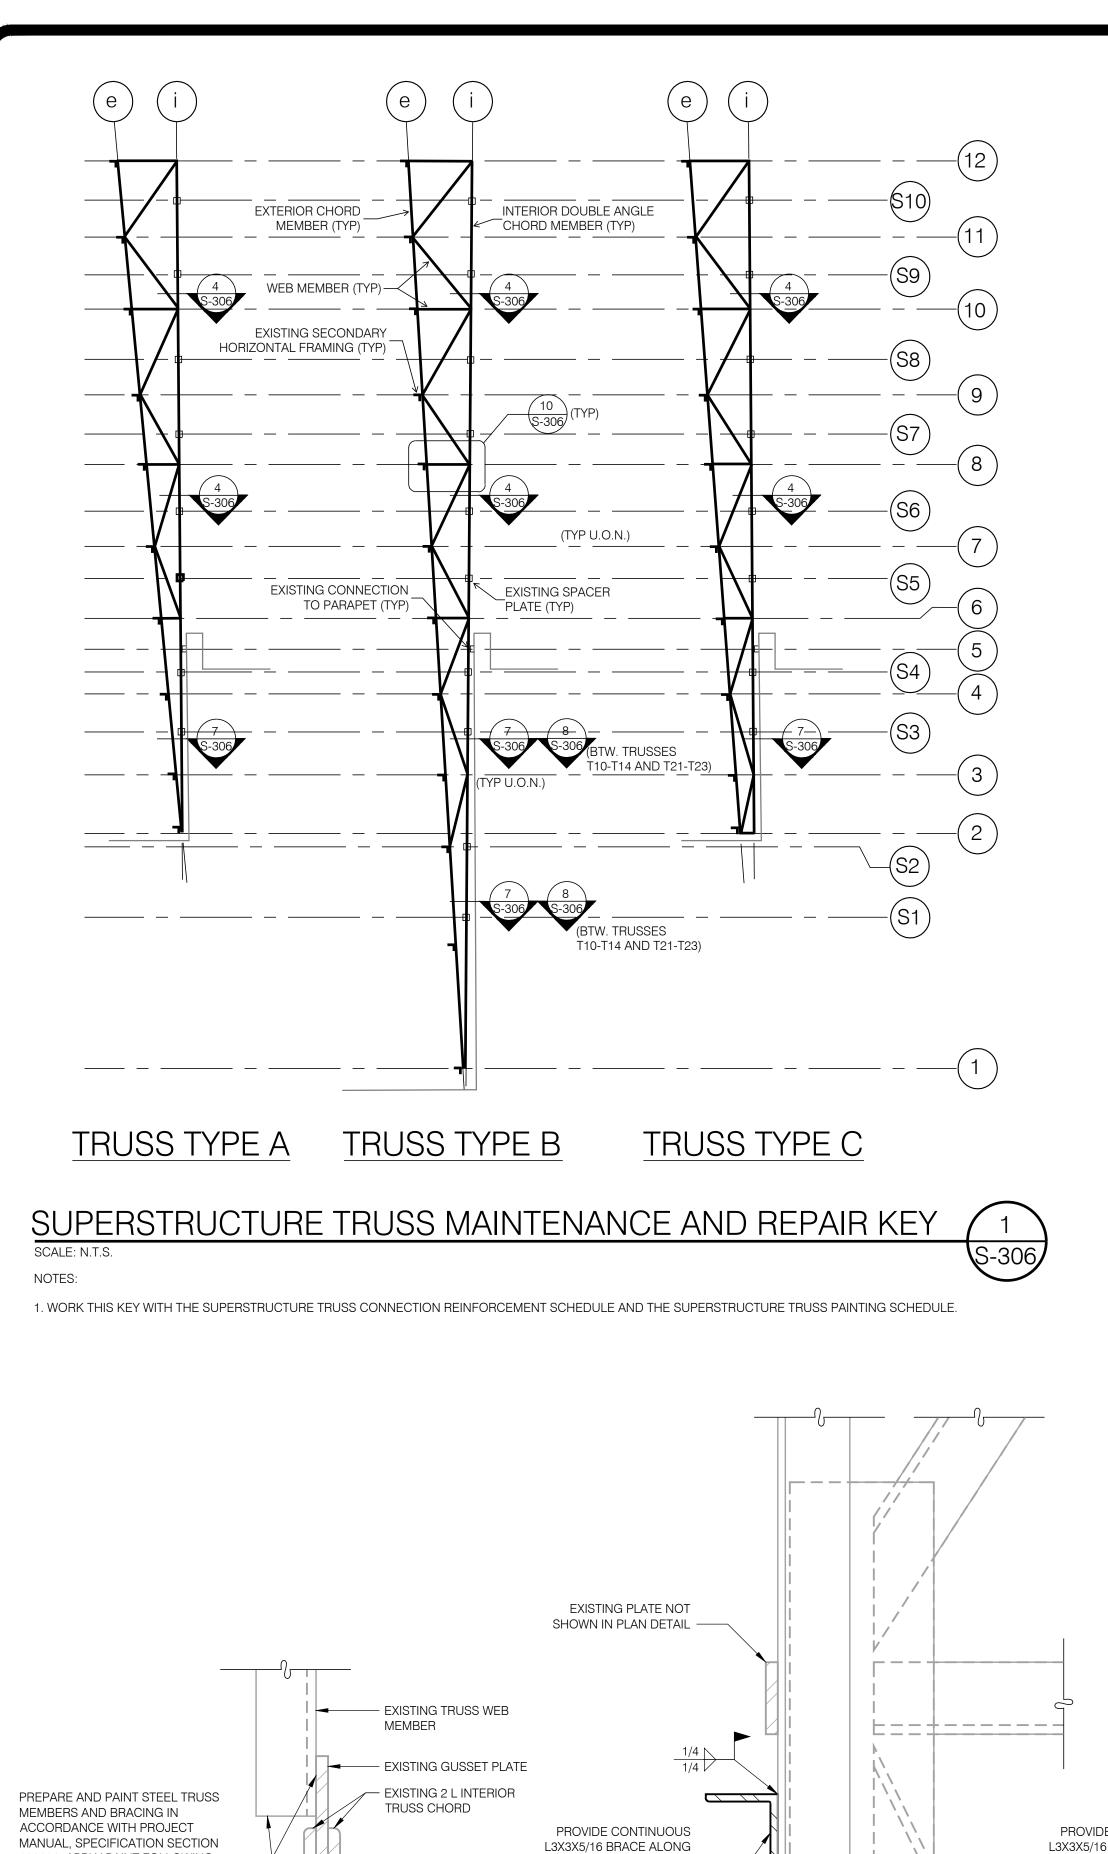
#### SUPERSTRUCTURE TRUSS CONNECTION REINFORCEMENT SHCEDULE


1. WORK THIS SCHEDULE WITH S-100 AND THE SUPERSTRUCTURE TRUSS MAINTENANCE AND REPAIR KEY. 2. "x" INDICATES RUST JACKING AND FAILED WELD OBSERVED AT GUSSET OR SPACER PLATE. REFER TO 9/S-306 FOR REPAIR.



S-306

TYPICAL SUPERSTRUCTURE TRUSS PAINTING DETAIL

SCALE: 1 1/2" = 1'-0" NOTE: PAINT TO BE APPLIED FOLLOWING INSTALLATION OF REINFORCEMENT AND BRACING.

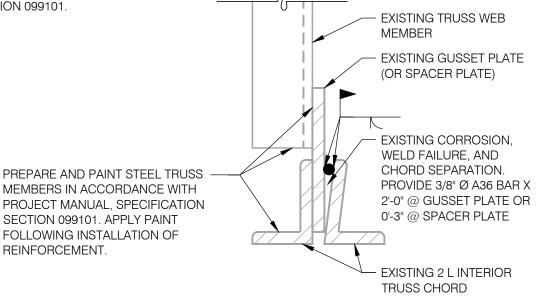

S-306

#### SUPERSTRUCTURE TRUSS BRACING PLAN DETAIL


SCALE: 3" = 1'-0"

SECTION 099101. APPLY PAINT

FOLLOWING INSTALLATION OF

REINFORCEMENT.

NOTE: REFER TO TRUSS CONNECTION REINFORCEMENT SCHEDULE

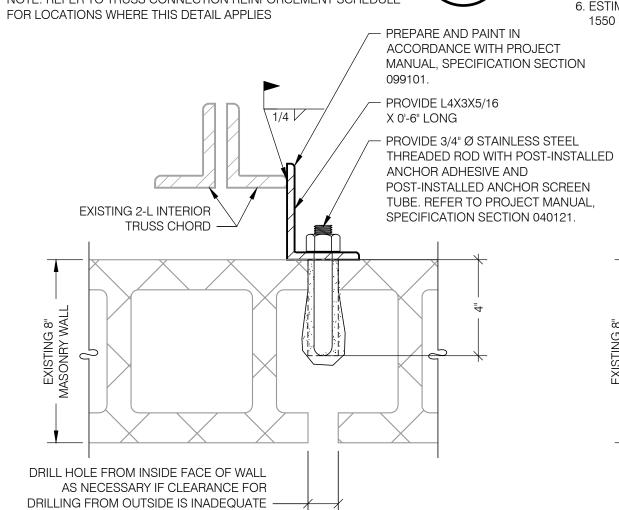

# SUPERSTRUCTURE TRUSS BRACING @ MASONRY WALL PLAN DETAIL

NUMBER	TYPE	NOTES)	FRAMING (SF)
T1	С	P1	160
T2	С	P1	160
T3	С	P2	45
T4	С	P2	45
T5	С	P2	45
T6	В	P2	45
T7	В	P2	45
T8	В	P2	45
T9	В	P2	45
T10	В	P1	200
T11	В	P1	200
T12	В	P1	200
T13	В	P1	200
T14	В	P1	200
T15	В	P1	200
T16	В	P1	200
T17	В	P1	200
T18	В	P1	200
T19	В	P1	200
T20	В	P1	200
T21	В	P1	200
T22	В	P1	200
T23	В	P1	200
T24	В	P1	200
T25	В	P1	200
T26	В	P1	200
T27	В	P1	200
T28	В	P1	200
T29	В	P1	200
T30	В	P2	45
T31	В	P2	45
T32	В	P2	45
T33	В	P2	45
T34	С	P2	45
T35	С	P2	45
T36	С	P2	45
T37	С	P1	160
T38	С	P1	160
T39	Α	P1	150
T40	Α	P1	150
T41	Α	P1	150
T42	Α	P1	150
T43	Α	P1	150
T44	Α	P1	150
T45	А	P1	150
T46	A	P1	150
T47	A	P1	150
T48	A	P1	150
-		TOTAL=	6770

DESIGNATION | PREPARATION AND PAINT

TRUSS TRUSS (SEE SCHEDULE EXCLUDING SECONDARY

#### SUPERSTRUCTURE TRUSS PAINTING SCHEDULE


1. WORK THIS SCHEDULE WITH S-100 AND THE SUPERSTRUCTURE TRUSS MAINTENANCE 2. PREPARE AND PAINT ACCESSIBLE AREAS OF TRUSSES AND SECONDARY HORIZONTAL

S-306

FRAMING IN ACCORDANCE WITH PROJECT MANUAL. REFER TO 10/S-306. ACCESSIBLE AREAS ARE DEFINED IN THE FOLLOWING NOTES. 3. "P1" INDICATES ENTIRE TRUSS AND ADJACENT SECONDARY HORIZONTAL FRAMING ARE

4. "P2" INDICATES INSIDE FACE OF INTERIOR DOUBLE ANGLE CHORD MEMBER IS ADJACENT SECONDARY HORIZONTAL FRAMING ARE FULLY ACCESSIBLE ABOVE LOUVERS, OTHER PORTIONS OF TRUSS AND SECONDARY FRAMING ARE INACCESSIBLE.

5. "P3" INDICATES INSIDE FACE OF INTERIOR DOUBLE ANGLE CHORD MEMBER IS ACCESSIBLE FOR THE HEIGHT OF THE LOUVERS ABOVE THE BULKHEAD. TRUSS AND ADJACENT SECONDARY HORIZONTAL FRAMING ARE FULLY ACCESSIBLE ABOVE LOUVERS. OTHER PORTIONS OF TRUSS AND SECONDARY FRAMING ARE INACCESSIBLE 6. ESTIMATED TOTAL QUANTITY OF SECONDARY FRAMING TO BE PREPARED AND PAINTED IS

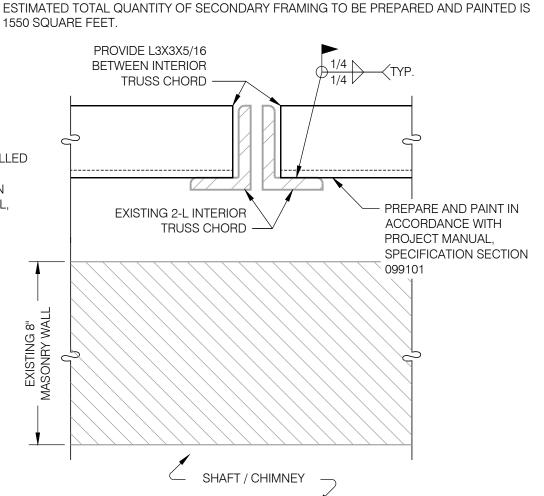

## SUPERSTRUCTURE TRUSS BRACING @ MASONRY WALL PLAN DETAIL

S-306 SCALE: 3" = 1'-0"

**DESIGN & CONSTRUCTION** CONSULTANT

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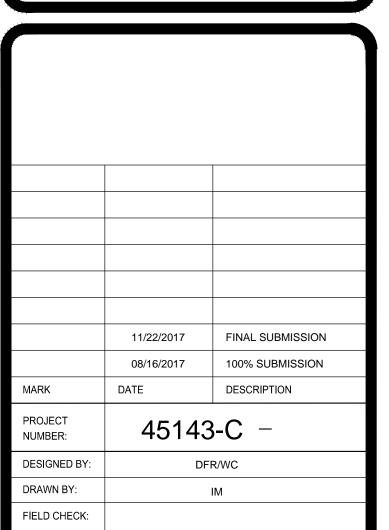


### CONSTRUCTION

REHABILITATE FACADE

STATE INSURANCE FUND HEADQUARTERS 199 CHURCH STREET NEW YORK, NY 10007

STATE INSURANCE FUND




SHEET TITLE: REMOVAL AND REPAIR **DETAILS FOR** SUPERSTRUCTURE

DRAWING NUMBER:

APPROVED:

S-306

SHEET 16 OF

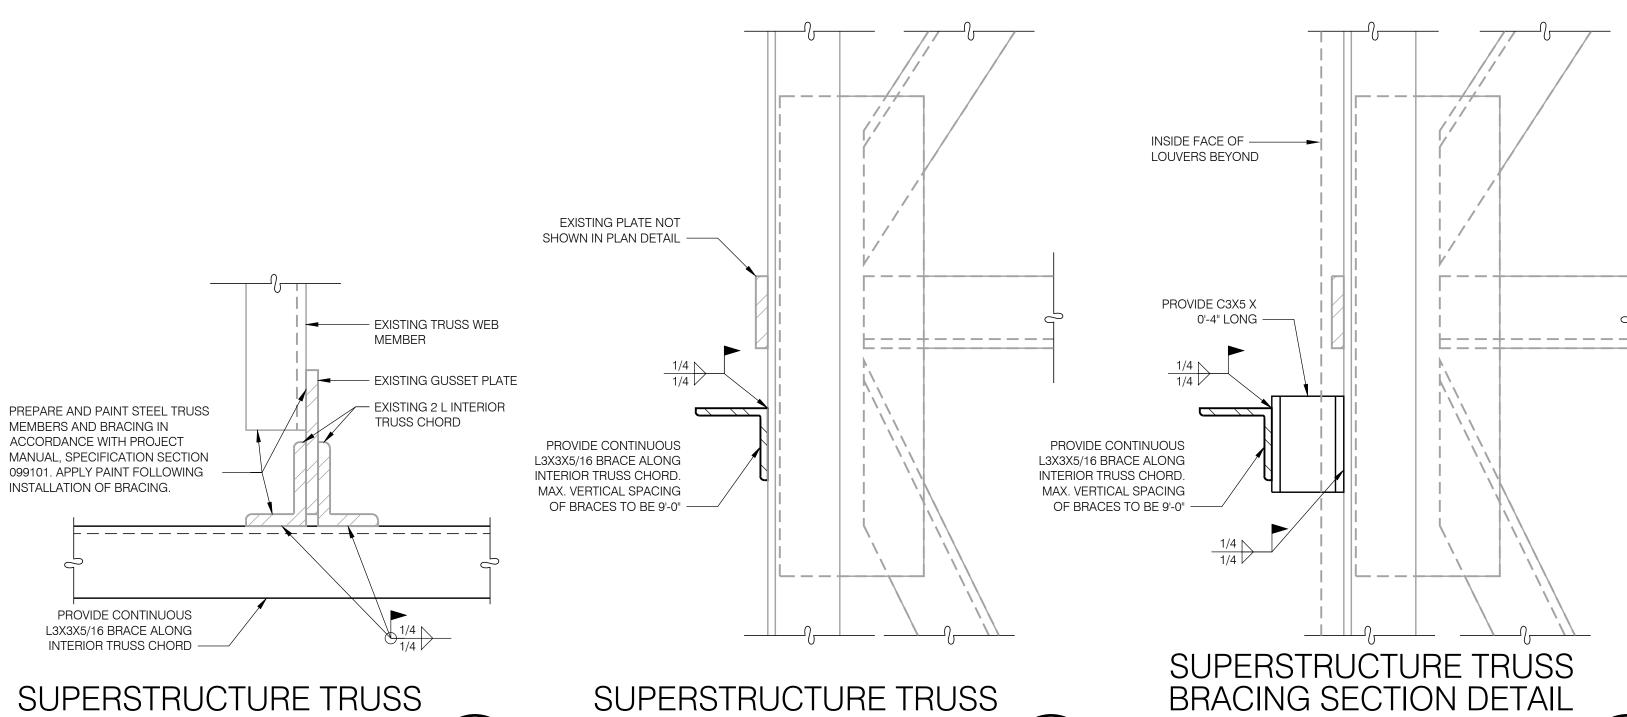

BRACING SECTION DETAIL

SCALE: 3" = 1'-0"

BRACING SECTION DETAIL AT LOUVERS

NOTE: THIS BRACING DETAIL IS NOT APPLICABLE AT TRUSSES IN

BRACING PLAN DETAIL